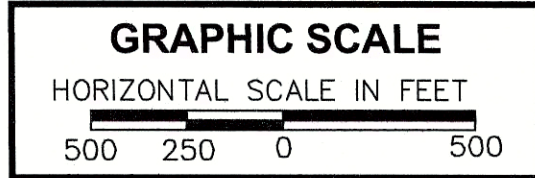


LOCATION PLAN



TOWN OF BROOKFIELD

DEPARTMENT OF PUBLIC WORKS

TOWN DISTRICT SIDEWALK AND ACCESS MANAGEMENT PLAN STATE LOT CIP PROJECT NO. L018-0001

ROAD	MAINTENANCE RESPONSIBILITY	LENGTH
FEDERAL RD - ROUTE 202	STATE	1,350 FT
STATION RD	TOWN	375 FT
WHISCONIER RD - ROUTE 25	STATE	575 FT


GENERAL NOTES:

- CONSTRUCTION SPECIFICATIONS:
CONNECTICUT DEPARTMENT OF TRANSPORTATION, STANDARD SPECIFICATIONS FOR ROADS, BRIDGES AND INCIDENTAL CONSTRUCTION, FORM 816, DATED 2004; SUPPLEMENTAL SPECIFICATIONS, DATED JANUARY 2016; AND SPECIAL PROVISIONS.
- BASED ON CONNECTICUT COORDINATE SYSTEM N.A.D. 1983.
- VERTICAL DATUM BASED ON NAVD 88.
- URS CORPORATION IS NOW PART OF AECOM.

INDEX OF DRAWINGS

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	ABBREVIATIONS, AND LEGEND
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STEPHEN F. MITCHELL
CONNECTICUT PE #13321
FEBRUARY 15, 2017

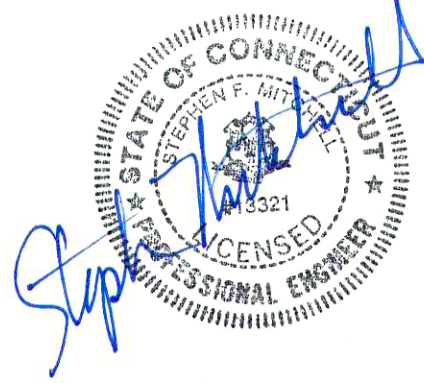

AECOM

500 ENTERPRISE DRIVE, SUITE 3B
ROCKY HILL, CT 06067
(860) 529-8882

DETAIL ESTIMATE

ITEM NUMBER	0100100A	0202001A	0201001	0202529	0205001	0205003	0209001	0212000	0219011A	0406170	0406172	0406236	0406257A	0406999A	0507001A	0507006A	0507021A	0507201A	0507754A	0507781A	0507831A	0507899A	0651001	0651011	0651012	0651742	0811101	0813021	0813031	0813451	0815001	0921001A	0921005A	
DESCRIPTION	RESET MONITORING WELL	EARTH EXCAVATION	CLEARING AND GRUBBING	CUT BITUMINOUS CONCRETE PAVEMENT	TRENCH EXCAVATION 0-4' DEEP	TRENCH EXCAVATION 0-10' DEEP	FORMATION OF SUBGRADE	SUBBASE	SEDIMENT CONTROL SYSTEM AT CATCH BASIN	HMA S1	HMA S0.375	MATERIAL FOR TACK COAT	MILLING OF HMA (0" TO 4")	ASPHALT ADJUSTMENT COST	TYPE "C" CATCH BASIN	TYPE "C" CATCH BASIN TOP	TYPE "C" CATCH BASIN DOUBLE GRATE - TYPE 1	TYPE "C-L" CATCH BASIN	RESET TYPE "C" CATCH BASIN DOUBLE GRATE - TYPE 1	RESET MANHOLE	CONVERT CATCH BASIN TO MANHOLE	OFFSET TYPE "C" CATCH BASIN	BEDDING MATERIAL	12" R.C. PIPE	15" R.C. PIPE	10" POLYVINYL CHLORIDE PIPE	CONCRETE PARK CURBING	6" GRANITE STONE CURBING	6" GRANITE CURVED STONE CURBING	GRANITE STONE TRANSITION CURBING	BITUMINOUS CONCRETE LIP CURBING	CONCRETE SIDEWALK	CONCRETE SIDEWALK RAMP	
UNIT	EA.	C.Y.	L.S.	L.F.	C.Y.	C.Y.	S.Y.	C.Y.	EA.	TON	TON	GAL.	S.Y.	EST.	EA.	EA.	EA.	EA.	EA.	EA.	EA.	EA.	C.Y.	L.F.	L.F.	L.F.	L.F.	L.F.	L.F.	L.F.	S.F.	S.F.		
SUBTOTAL	11	2280	1	5160	150	250	1323	367	25	457	1621	932	9174	1	12	1	3	4	1	1	3	1	8	167	282	14	60	3273	997	72	294	15935	2002	
UNASSIGNED	0	120	0	258	10	15	70	20	0	30	90	50	500	0	0	0	0	0	0	0	0	1	8	18	1	5	164	50	4	11	797	100		
TOTAL	11	2400	1	5418	160	265	1393	387	25	487	1711	982	9674	1	12	1	3	4	1	1	3	1	9	175	300	15	65	3437	1047	76	305	16732	2102	

ITEM NUMBER																																																																																																																																																																																																																																																																																																																																																																																																																																																																																																																																																																																																																																																																																																																																																																																																																																																																																																																																																																																																				
DESCRIPTION	0921013A		0921031A		0921039A		0921102A		0922250A		0922501		0944000A		0945301		0950005A		0970006A		0970007A		0971001A		0975004		0977001		0978002		0979003		0980001A		1001001		1002203		1003894A		1008115		1008908A		1010021		1010060A		1102002		1102008		1102011		1102014		1106001A		1106002A		1106003A																																																																																																																																																																																																																																																																																																																																																																																																																																																																																																																																																																																																																																																																																																																																																																																																																																																																																																																																							
	CONCRETE DRIVEWAY APRON	DECORATIVE CONCRETE CROSSWALK (HERRINGBONE PATTERN)	DETECTABLE WARNING STRIP	BRICK PAVERS	BITUMINOUS CONCRETE BIKEWAY	BITUMINOUS CONCRETE DRIVEWAY	FURNISHING AND PLACING TOPSOIL	MULCHING	TURF ESTABLISHMENT	TRAFFICPERSON (MUNICIPAL POLICE OFFICER) (ESTIMATED COST)	TRAFFICPERSON (UNIFORMED FLAGGER)	MAINTENANCE AND PROTECTION OF TRAFFIC	MOBILIZATION AND PROJECT CLOSEOUT	TRAFFIC CONE	TRAFFIC DRUM	CONSTRUCTION BARRICADE TYPE III	CONSTRUCTION STAKING	TRENCHING AND BACKFILLING	TRAFFIC CONTROL FOUNDATION-PEDESTAL-TYPE I	ORNAMENTAL LIGHT SYSTEM	2" RIGID METAL CONDUIT IN TRENCH	CLEAN EXISTING CONDUIT	CONCRETE HANDHOLE - TYPE II	CLEAN EXISTING CONCRETE HANDHOLE	8' ALUMINUM PEDESTAL	4'-4" ALUMINUM PEDESTAL	14' ALUMINUM PEDESTAL	20' ALUMINUM PEDESTAL	1 WAY PEDESTRIAN SIGNAL POLE MOUNTED	2 WAY PEDESTRIAN SIGNAL POLE MOUNTED	1 WAY PEDESTRIAN SIGNAL PEDESTAL MOUNTED																																																																																																																																																																																																																																																																																																																																																																																																																																																																																																																																																																																																																																																																																																																																																																																																																																																																																																																																																																					
UNIT	S.F.	S.F.	EA.	S.Y.	S.Y.	S.Y.	S.Y.	S.Y.	S.Y.	EST.	HR.	L.S.	L.S.	EA.	EA.	EA.	LS	L.F.	EA.	L.S.	L.F.	L.F.	EA.	EA.	EA

ITEM NUMBER	106004A	107011A	1111401A	1111407A	1111451A	1113049	1113050	1113103	1117110A	1117111A	1118012A	1206023A	1208931	1208932	1210101A	1210102A	1210105A	1220013A	1303196A	1407001A
DESCRIPTION	2 WAY PEDESTRIAN SIGNAL PEDESTAL MOUNTED	ACCESSIBLE PEDESTRIAN SIGNAL AND DETECTOR (TYPE A)	LOOP VEHICLE DETECTOR	CAMERA VIDEO DETECTION SYSTEM	LOOP DETECTOR SAW CUT	2 CONDUCTOR NO. 8 CABLE	2 CONDUCTOR NO. 14 CABLE	7 CONDUCTOR NO. 14 CABLE	RECTANGULAR RAPID FLASHING BEACON (RRFB) TYPE A	RECTANGULAR RAPID FLASHING BEACON (RRFB) TYPE B	REMOVAL AND/OR RELOCATION OF TRAFFIC SIGNAL EQUIPMENT	REMOVAL AND RELOCATION OF EXISTING SIGNS	SIGN FACE - SHEET ALUMINUM (TYPE IX RETROREFLECTIVE SHEETING)	SIGN FACE - SHEET ALUMINUM (TYPE IV RETROREFLECTIVE SHEETING)	4" WHITE EPOXY RESIN PAVEMENT MARKINGS	4" YELLOW EPOXY RESIN PAVEMENT MARKINGS	EPOXY RESIN PAVEMENT MARKINGS, SYMBOLS AND LEGENDS	CONSTRUCTION SIGNS BRIGHT FLUORESCENT SHEETING	RELOCATE FIRE HYDRANT	ADJUST UTILITY GATE
UNIT	EA.	EA.	EA.	EA.	L.F.	L.F.	L.F.	L.F.	EA.	EA.	L.S.	L.S.	S.F.	S.F.	L.F.	L.F.	S.F.	S.F.	EA.	EA.
SUBTOTAL	4	8	4	1	293	50	1358	1008	2	1	1	1	26	316	4609	4528	865	190	1	6
UNASSIGNED	0	0	0	0	15	3	68	50	0	0	0	0	2	16	231	227	44	10	0	1
TOTAL	4	8	4	1	308	53	1426	1058	2	1	1	1	28	332	4840	4755	909	200	1	7

TOWN OF BROOKFIELD, CT			
<div>AECON 500 ENTERPRISE DRIVE, SUITE 3B ROCKY HILL, CT 06067 (860) 529-8882</div>	PROJECT NAME: TOWN DISTRICT SIDEWALK AND ACCESS MANAGEMENT PLAN		
	SHEET TITLE: DETAILED ESTIMATE		
	FILE NAME:----	PLOT DATE: 4/20/2016	DRAWING NO.: DE-01
	PROJECT LEADER: SM DESIGNED BY: AG	DRAWN BY: AG CHECKED BY: PG X	SHEET NO.: 2

4/8/2015 4:03 PM
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GENERAL NOTES

1.

THE EXISTING CONDITIONS BASE PLAN WAS COMPILED FROM RECORD MAPS, RESEARCH AND OTHER SOURCES OF INFORMATION. THE EXISTING INFORMATION ALONG THE PROJECT ALIGNMENT WAS BASED ON FIELD SURVEY. THE UNDERGROUND UTILITIES DEPICTED HAVE BEEN PLOTTED FROM FIELD SURVEY INFORMATION AND EXISTING DRAWINGS. THE CONSULTANT MAKES NO GUARANTEES THAT THE UNDERGROUND UTILITIES DEPICTED COMPRISE ALL SUCH UTILITIES IN THIS AREA, EITHER IN SERVICES OR ABANDONED. THE CONSULTANT FURTHER DOES NOT WARRANT THAT THE UNDERGROUND UTILITIES DEPICTED ARE IN THE EXACT LOCATION INDICATED. THE CONSULTANT HAS NOT PHYSICALLY EXPOSED THE UNDERGROUND UTILITIES.
2.

THE CONTRACTOR SHALL DETERMINE, PRIOR TO CONSTRUCTION, THE LOCATIONS OF ALL UTILITIES AND SHALL BE RESPONSIBLE FOR ALL DAMAGES RESULTING FROM HIS OPERATIONS. CALL BEFORE YOU DIG, 1-800-922-4456, AT LEAST 24 HOURS PRIOR TO STARTING CONSTRUCTION. THE CONTRACTOR IS TO COORDINATE ACTIVITIES WITH INDIVIDUAL COMPANY REPRESENTATIVES. THE CONTRACTOR SHALL ACCURATELY LOCATE ALL UNDERGROUND UTILITIES IN AREAS WHERE PROPOSED CONSTRUCTION MAY CONFLICT WITH THEM AND SHALL BE RESPONSIBLE FOR ALL DAMAGES.
3.

AS CONSTRUCTION IS COMPLETED, THE CONTRACTOR SHALL REMOVE ALL EXCESS MATERIAL, DEBRIS, ETC. AND RESTORE AND/OR REPAIR ANY DAMAGE TO LANDSCAPING.
4.

ANY PIPE LENGTHS SHOWN ARE MEASURED FROM CENTER TO CENTER OF STRUCTURES.
5.

AREAS OUTSIDE THE WORK LIMITS DISTURBED BY CONSTRUCTION SHALL BE RETURNED TO THEIR ORIGINAL CONDITION OR BETTER AND SHALL BE GRADED TO MEET PROPOSED CONSTRUCTION AS DIRECTED BY THE ENGINEER. COST FOR THIS WORK SHALL BE THE CONTRACTORS SOLE RESPONSIBILITY AT NO COST TO THE OWNER.
6.

THE CONTRACTOR SHALL PROCURE ALL THE NECESSARY PERMITS AND LICENSES, PAY ALL CHARGES AND FEES, AND GIVE NOTICES NECESSARY AND DUE IN CONNECTION WITH THE LAWFUL EXECUTION OF THE WORK AT NO ADDITIONAL COST TO THE TOWN.
7.

EXCAVATION OF ANY TYPE SHALL BE ACCOMPLISHED IN SUCH A MANNER THAT UNDERGROUND UTILITIES AND STRUCTURES ARE NOT DAMAGED. THE CONTRACTOR SHALL BE SOLELY RESPONSIBLE FOR ANY DAMAGE INCURRED DURING EXCAVATION OPERATIONS. ALL EXCAVATION SHALL BE IN CONFORMANCE WITH THE LATEST OSHA REQUIREMENTS.
8.

ALL UTILITY BOXES, FRAMES, GRATES, ETC. AFFECTED BY THE CONSTRUCTION ACTIVITIES, SHALL BE RESET TO THE PROPER GRADE. ALL COST RELATED TO SUCH WORK SHALL BE CONSIDERED TO BE INCLUDED IN THE PRICE BID.
9.

ALL DRIVEWAYS, ROADS, STAIRS, AND SIDEWALKS DISTURBED BY THE CONSTRUCTION IN OR OUTSIDE THE PROJECT AREA SHALL BE RETURNED TO THEIR ORIGINAL CONDITION OR BETTER AND SHALL BE GRADED TO MEET PROPOSED CONSTRUCTION AS DIRECTED BY THE ENGINEER AT NO ADDITIONAL COST TO THE OWNER.
10.

ANY UTILITY SERVICE CONNECTIONS (GAS, WATER, SEWER, ELECTRIC, ETC.) DISTURBED BY THE CONSTRUCTION ACTIVITIES SHALL BE REPAIRED AND SERVICE RESTORED. AT NO TIME SHALL ANY EXISTING BUILDING BE WITHOUT SERVICES (INCLUDING FIRE PROTECTION) WITHOUT PRIOR NOTIFICATION OF THE PARTICULAR UTILITY AUTHORITY AND PROPERTY OWNER. NO FIRE PROTECTION UTILITIES OF ANY KIND WILL BE DISRUPTED WITHOUT PERMISSION FROM THE FIRE MARSHALL. THE CONTRACTOR SHALL COORDINATE HIS WORK, PRIOR TO A UTILITY SHUTDOWN, WITH THE UTILITY COMPANY AND THE OWNER.
11.

THE CONTRACTOR SHALL SUFFICIENTLY COVER ALL DISTURBED AREAS AT THE END OF EACH WORK DAY TO AVOID ANY RISK OF INJURY TO PEDESTRIAN OR VEHICULAR TRAFFIC. THE CONTRACTOR SHALL INSTALL TEMPORARY SUPPORT SYSTEMS OVER TRENCH EXCAVATIONS THAT ARE TAMPER RESISTANT AND SAFE FOR VEHICULAR AND PEDESTRIAN TRAFFIC. THE CONTRACTOR SHALL INSTALL BARRICADES TO PROTECT AGAINST PEDESTRIAN ACCESS. THE CONTRACTOR SHALL OBTAIN APPROVAL OF THE TEMPORARY SAFETY MEASURES BY THE ENGINEER AND THE OWNER. ALL MAINTENANCE AND PROTECTION OF BOTH PEDESTRIAN AND VEHICULAR TRAFFIC SHALL MEET THE REQUIREMENTS OF ITEM# 0971001A – MAINTENANCE AND PROTECTION OF TRAFFIC AND IS INCLUDED IN THE BID PRICE FOR THIS ITEM.
12.

LOCATION AND ELEVATION OF ALL UNDERGROUND UTILITIES INSTALLED OR FOUND DURING CONSTRUCTION SHALL BE INDICATED BY THE CONTRACTOR ON RECORD DRAWINGS, MEASURED FROM PERMANENT SURFACE FEATURES.
13.

WHEN EXCAVATING CLOSE TO TREES, USE ONLY HAND TOOLS. CARE SHALL BE TAKEN TO ENSURE THAT TREE ROOTS ARE NOT DAMAGED IN ANY WAY. THE INSPECTOR SHALL BE NOTIFIED IMMEDIATELY WHENEVER TREE ROOTS ARE ENCOUNTERED. FURTHER EXCAVATING AT THAT LOCATION SHALL BE AS DIRECTED BY THE INSPECTOR.
14.

CONTRACTOR SHALL INFORM UTILITY COMPANY OF REQUIRED POLE RELOCATION AND COORDINATE HIS WORK WITH UTILITY COMPANY.
15.

PRIOR TO OPENING AN EXCAVATION, EFFORT SHALL BE MADE TO DETERMINE WHETHER UNDERGROUND INSTALLATIONS, (I.E. SEWER, WATER, FUEL, ELECTRIC LINES, ETC.) WILL BE ENCOUNTERED AND, IF SO, WHERE SUCH UNDERGROUND INSTALLATIONS ARE LOCATED. WHEN THE EXCAVATION APPROACHES THE ESTIMATED LOCATION OF SUCH INSTALLATION, THE EXACT LOCATION SHALL BE DETERMINED BY CAREFUL PROBING OR HAND DIGGING, AND WHEN IT IS UNCOVERED, PROPER SUPPORTS SHALL BE PROVIDED FOR THE EXISTING INSTALLATION. UTILITY COMPANIES SHALL BE CONTACTED AND ADVISED PRIOR TO THE START OF ACTUAL EXCAVATION. VERIFICATION BY TEST EXCAVATION IF NECESSARY.
16.

NO MATERIAL OR EQUIPMENT IS ALLOWED TO BE STORED OVERNIGHT WITHIN THE STREET R.O.W.
17.

REFER TO THE SPECIAL CONDITIONS OF THIS PROJECT, SECTION 1.08--PROSECUTION AND POROGRESS FOR HOURS OF WORK RESTRICTIONS.
18.

BEARINGS REFER TO THE CONNECTICUT COORDINATE SYSTEM (NAD 83) BASED UPON MDC MONUMENTS 48053 & 77109 HOLDING THE FOLLOWING PUBLISHED COORDINATE VALUES:
MDC 48053 N 839,947.14 N 840,322.79
E 1,010,596.45 E 1,013,053.96
19.

ELEVATIONS REFER TO THE NATIONAL GEODETIC VERTICAL DATUM OF 1929 (NGVD 29) BASED UPON MDC MONUMENTS V-52, V-123 & V-124 HOLDING THE FOLLOWING PUBLISHED ELEVATIONS:
V-52 75.204 V-123 64.975 V-124 74.68

STANDARD ABBREVIATIONS

ABDN('D)	ABANDON(ED)	IN	INCHES
AC	ACRE/AIR CONDITIONING	INC	INCORPORATED
AOBE	AS ORDERED BY THE ENGINEER	INV	INVERT
ASTM	AMERICAN SOCIETY FOR TESTING AND MATERIALS	L	LENGTH OF CURVE
BC	BOTTOM CURB	LOC	LOCATION
BCLC	BITUMINOUS CONCRETE LIP CURBING	LP	LIGHT POLE
BIT	BITUMINOUS	LT	LEFT
BL	BOTTOM OF LIP	MAX	MAXIMUM
BLDG	BUILDING	MH	MANHOLE
BM	BENCH MARK	MIN	MINIMUM
BOT	BOTTOM	MISC	MISCELLANEOUS
BOW	BACK OF WALK	MON	MONUMENT
BSMT	BASEMENT	MPH	MILES PER HOUR
BW	BOTTOM OF WALL	N	NORTH, NORTHING
C	CABLE	NTS	NOT TO SCALE
CATV	CABLE TELEVISION	N/A	NOT APPLICABLE
CB	CATCH BASIN	N/F	NOW OR FORMERLY
CC	CURVE CENTER	OH	OVERHEAD
CF	CUBIC FEET	P	POWER
CIP	CAST IRON PIPE	PC	POINT OF CURVATURE
CL, C/L	CENTERLINE	PCC	POINT OF COMPOUND CURVATURE
CLF	CHAIN LINK FENCE	PCPP	PERFORATED CORRUGATED POYETHYLENE PIPE
CL&P	CONNECTICUT LIGHT & POWER	PED	PEDESTRIAN
CMP	CORRUGATED METAL PIPE	PI	POINT OF INTERSECTION
CO	COMPANY	PL, P/L	PROPERTY LINE
COMB	COMBINED	POT	POINT OF TANGENCY
CONC	CONCRETE	PRC	POINT OF REVERSE CURVATURE
CONN, CT	CONNECTICUT	PROP	PROPOSED
CPP	CORRUGATED POLYETHYLENE PIPE	PS	PARKING SPACES
CSW	CONCRETE SIDEWALK	PT	POINT OF TANGENCY
CY	CUBIC YARD	PVC	POLYVINYL CHLORIDE
D	STORM MANHOLE	R, RAD	RADIUS
DC	DEGREE OF CURVATURE	RCP	REINFORCED CONCRETE PIPE
DIA	DIAMETER	REINF	REINFORCED
DIP	DUCTILE IRON PIPE	RET	RETAINING
DOT	DEPARTMENT OF TRANSPORTATION	REV	REVISION
DWG	DRAWING	RGCDR	RADIAL GRANITE CURB DRIVEWAY RETURN
DS	DESIGN SPEED	RMC	RIGID METAL CONDUIT
DWL	DASHED WHITE LINE	ROW	RIGHT OF WAY
DYCL	DOUBLE YELLOW CENTERLINE	RT	RIGHT
E	EAST/ELECTRIC/EASTING	S	SOUTH/SANITARY MANHOLE
EG	EXISTING GRADE	SAN	SANITARY
EL, ELEV	ELEVATION	SCH	SCHEDULE
ELEC	ELECTRIC	SF	SQUARE FEET
EMH	ELECTRIC MANHOLE	SHLDR	SHOULDER
EOP	EDGE OF PAVEMENT	SL, S/L	STREET LINE
EX/EXIST	EXISTING	ST	STORM
FES	FLARED END SECTION	STA	STATION
FF	FIRST FLOOR	STD	STANDARD
FT	FEET, FOOT	STRM	STORM
G	GAS	SY	SQUARE YARD
GEN	GENERATOR	T	TANGENT LENGTH/TELEPHONE
GG	GAS GATE	TC	TOP CURB
GRAN	GRANITE	TEL	TELEPHONE
GRC	GALVANIZED RIGID CONDUIT	TF	TOP OF FRAME
GCSC	GRANITE CURVED STONE CURBING	TL	TOP OF LIP
GSC	GRANITE STONE CURBING	TW	TOP OF WALL
H, HOR	HORIZONTAL	TYP	TYPICAL
HC	HANDICAPPED	US	UNITED STATES
HTFD	HARTFORD	USA	UNITED STATES OF AMERICA
HYD	HYDRANT	V, VERT	VERTICAL
		W	WATER
		W/	WITH
		WG, WV	WATER GATE/WATER VALVE
		W/O	WITHOUT
		XFMR	TRANSFORMER
		&	AND
		@	AT
		Δ	DELTA ANGLE
		XX" (YYY)	DISTANCE NOTES IN INCHES (MILLIMETERS)

RIGHT OF WAY KEY

- Ⓐ

RIGHT TO GRADE
- Ⓑ

RIGHT TO RECONSTRUCT DRIVEWAY, STEPS, AND/OR WALK
- Ⓒ

EASEMENT TO CONSTRUCT DRAINAGE
- Ⓓ

ROADWAY RIGHT--OF--WAY TAKING
- Ⓔ

PARCEL NUMBER


LEGEND

DESCRIPTIONS	EXISTING	PROPOSED
EASEMENT LINE		
ROW LINE		
PROPERTY LINE		
PROJECT LIMIT LINE		
GRANITE CURB		
TREELINE OR HEDGE LINE		
BUSHES		
CONIFEROUS TREE		
DECIDUOUS TREE		
CONTOUR LINES (MINOR)		
CONTOUR LINES (MAJOR)		
ABANDON PIPE/STRUCTURE		
REMOVE PIPE/STRUCTURE		
REMOVE SURFACE FEATURE		
SILT FENCE		
INLET PROTECTION – TYPE I		
INLET PROTECTION – TYPE II		
CONSTRUCTION ENTRANCE		
STORM PIPE		
CATCH BASIN		
DRAIN		
GAS MAIN		
GAS GATE		
WATER PIPE		
SANITARY PIPE/LATERAL		
FIRE PROTECTION		
HYDRANT		
STORM MANHOLE		
SANITARY MANHOLE		
WATER GATE VALVE		
TELECOMMUNICATIONS		
OVERHEAD ELECTRIC		
LIGHT POLE		
SIGN		
UTILITY POLE		
R.M.C.		
FENCE		
SURVEY CONTROL LINE		
SAWCUT LINE		
HANDICAP RAMP		
FILL LINE		
CUT LINE		


TOWN OF BROOKFIELD, CT

<div>URS CORPORATION</div> <div>500 ENTERPRISE DRIVE, SUITE 3B</div> <div>ROCKY HILL, CT 06067</div> <div>(860) 529-8882</div>	PROJECT NAME: TOWN DISTRICT SIDEWALK AND ACCESS MANAGEMENT PLAN		
	SHEET TITLE: GENERAL NOTES, STANDARD ABBREVIATIONS & LEGEND		
	FILE NAME:-----	PLOT DATE: 4/20/2016	DRAWING NO.: GN-01
	PROJECT LEADER: SM	DRAWN BY: AG	SHEET NO.: 3
	DESIGNED BY: AG	CHECKED BY: PG	

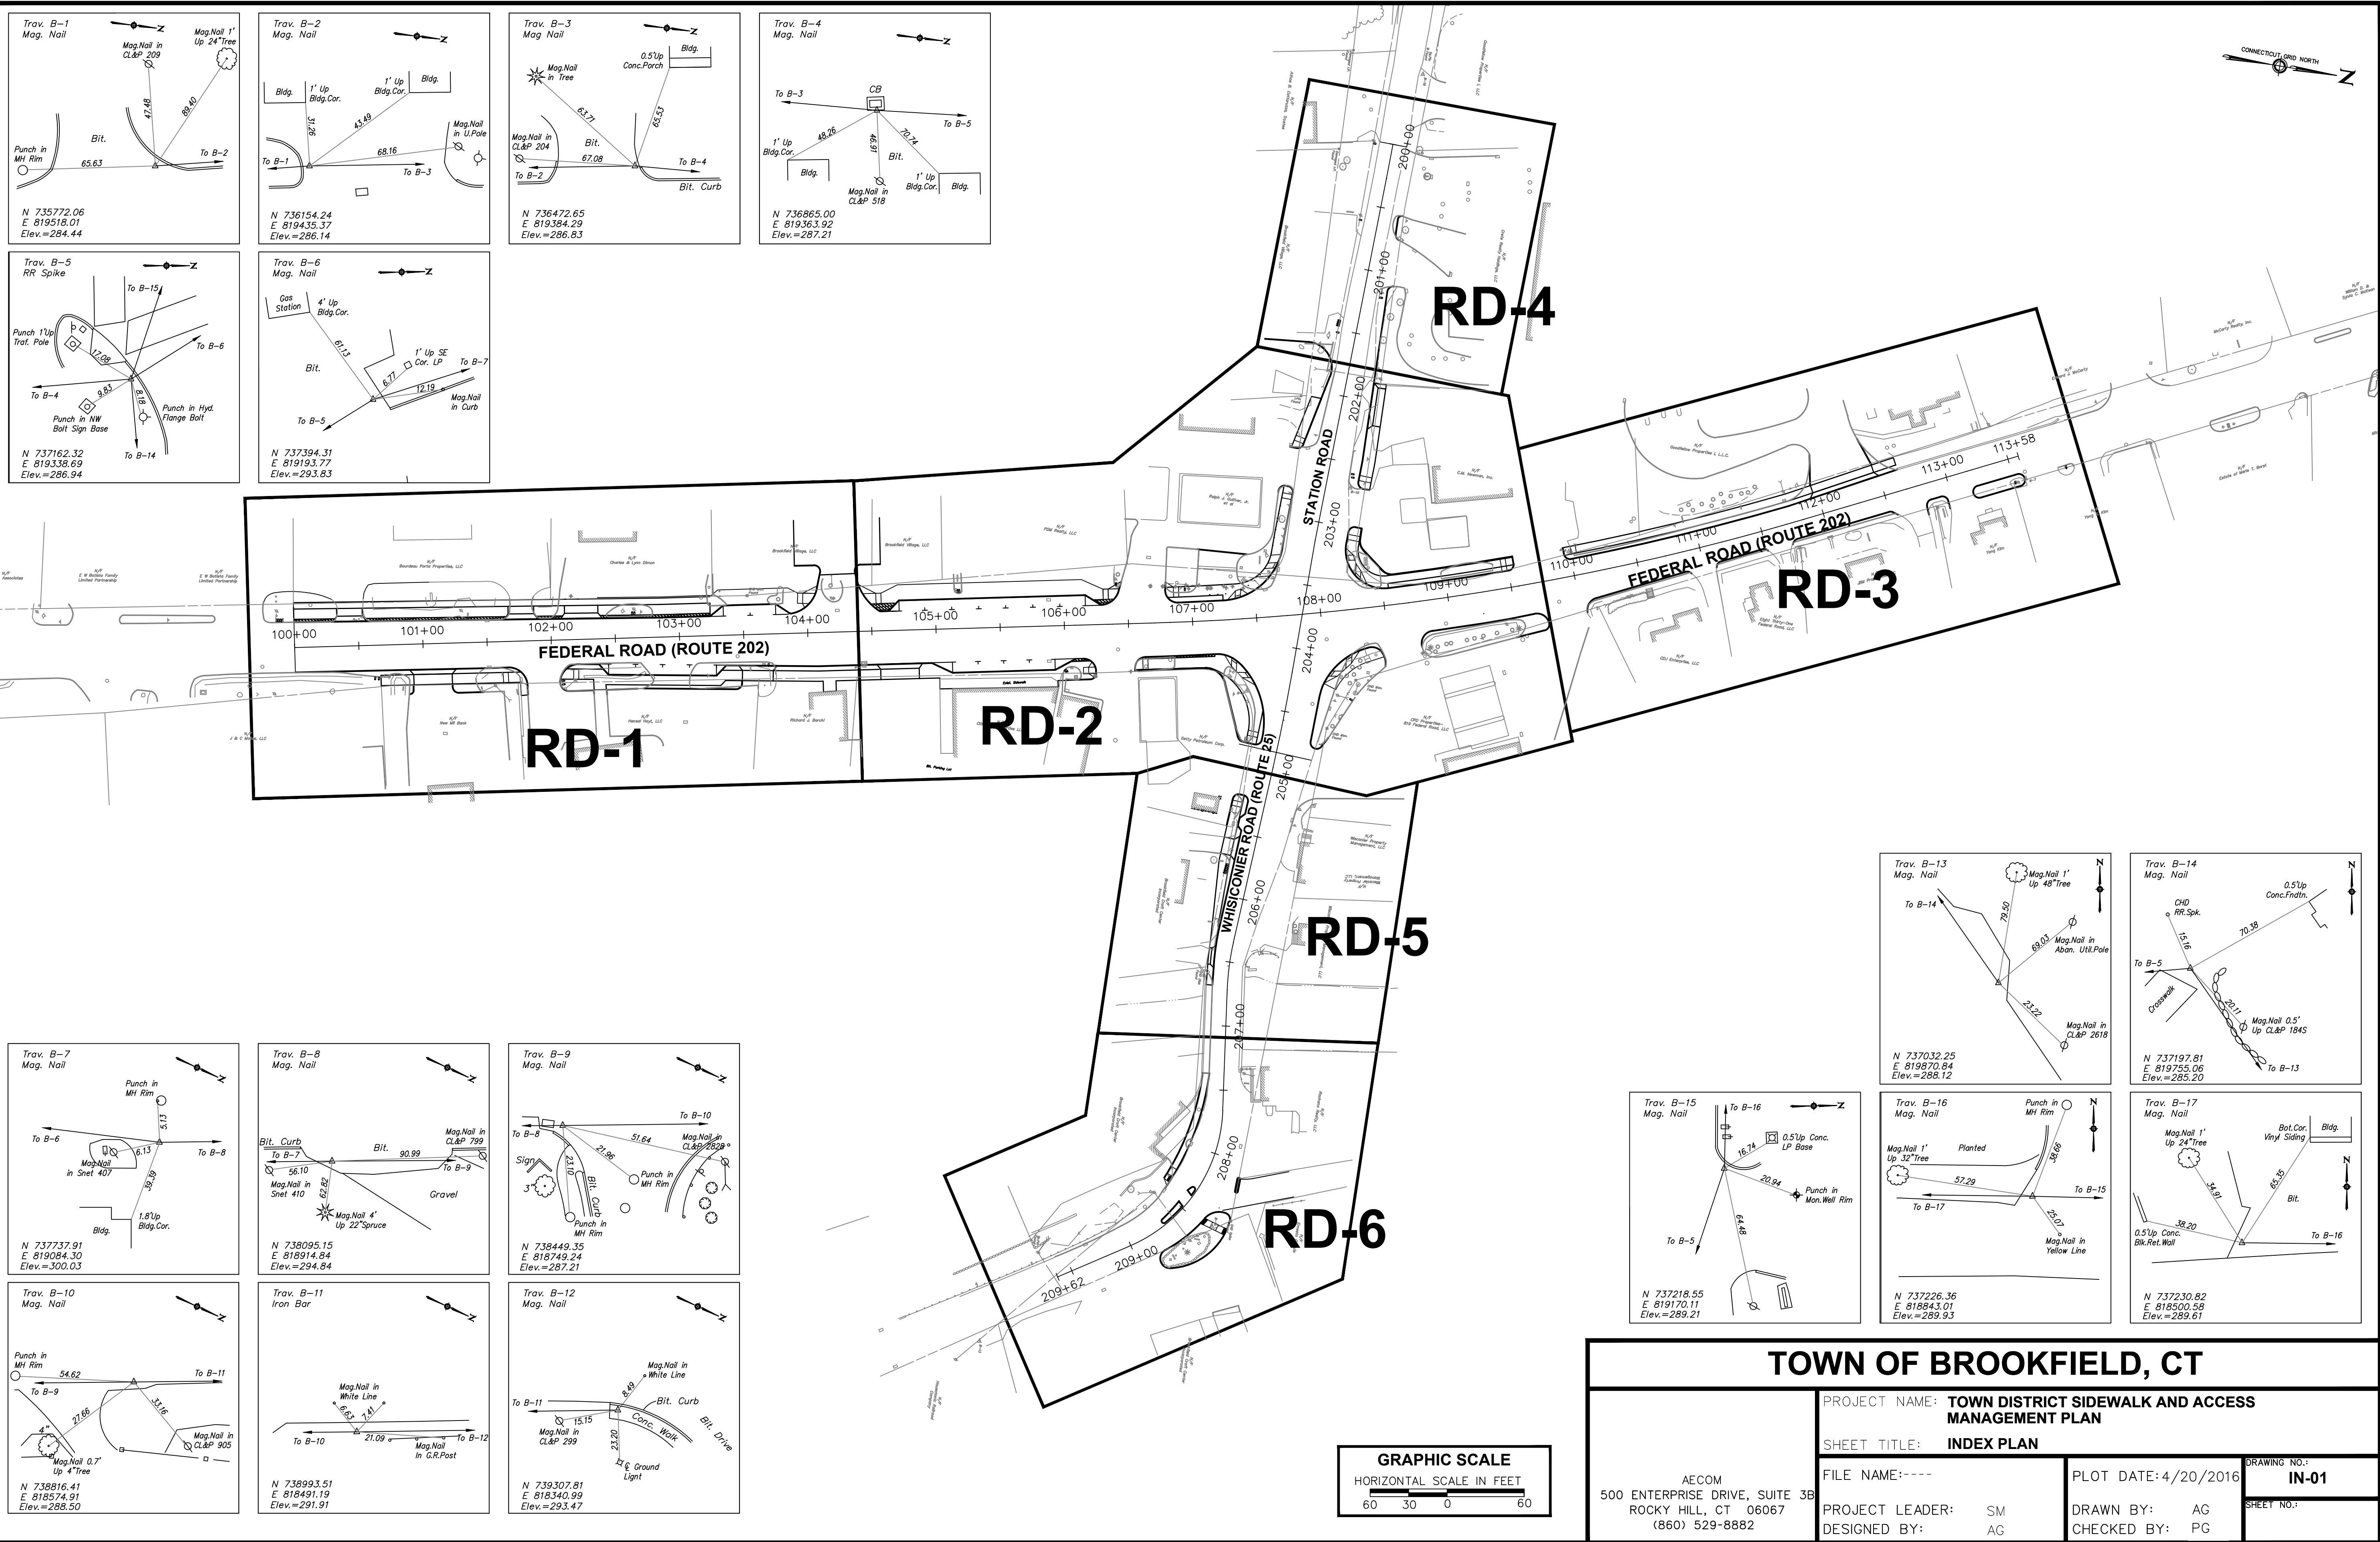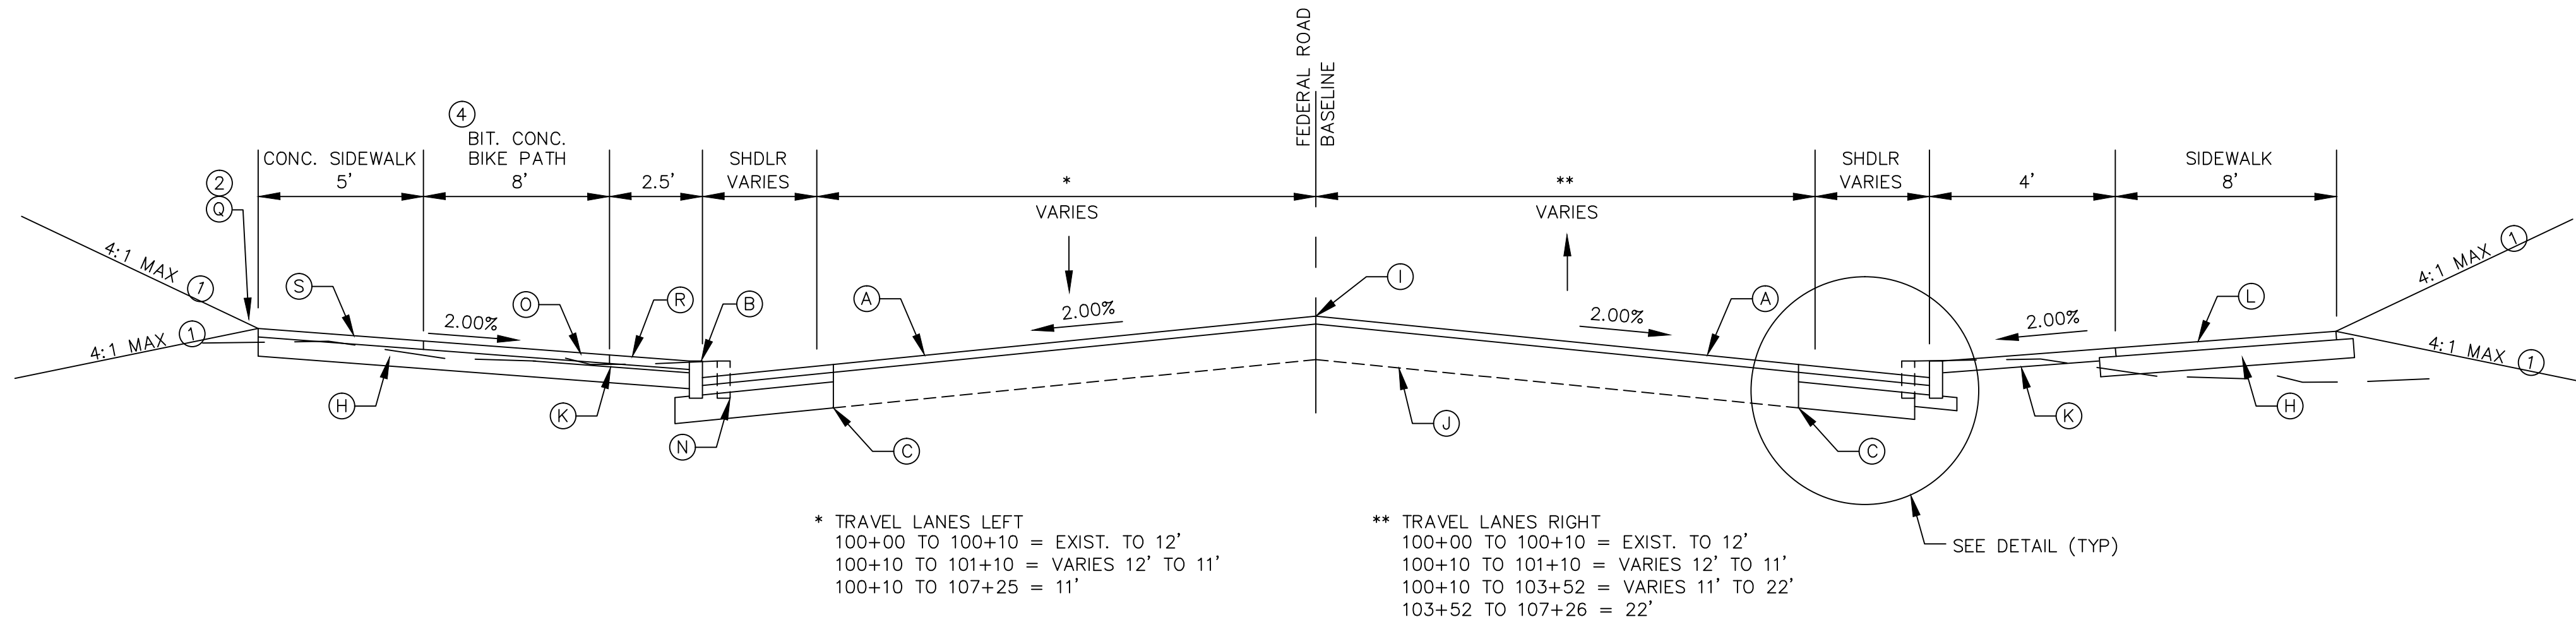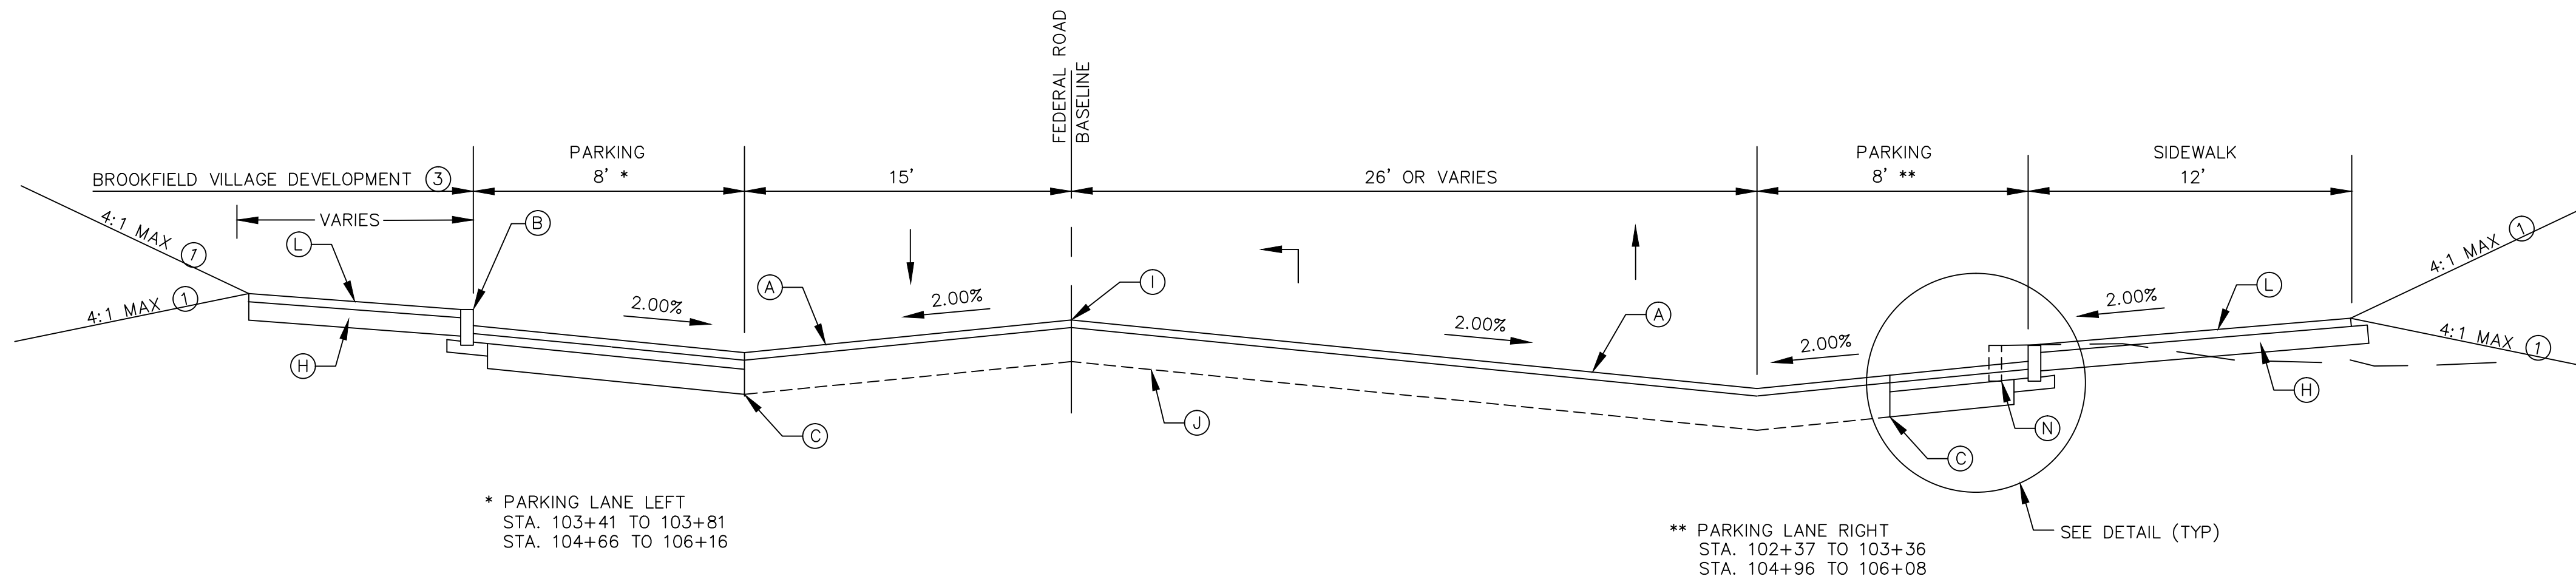
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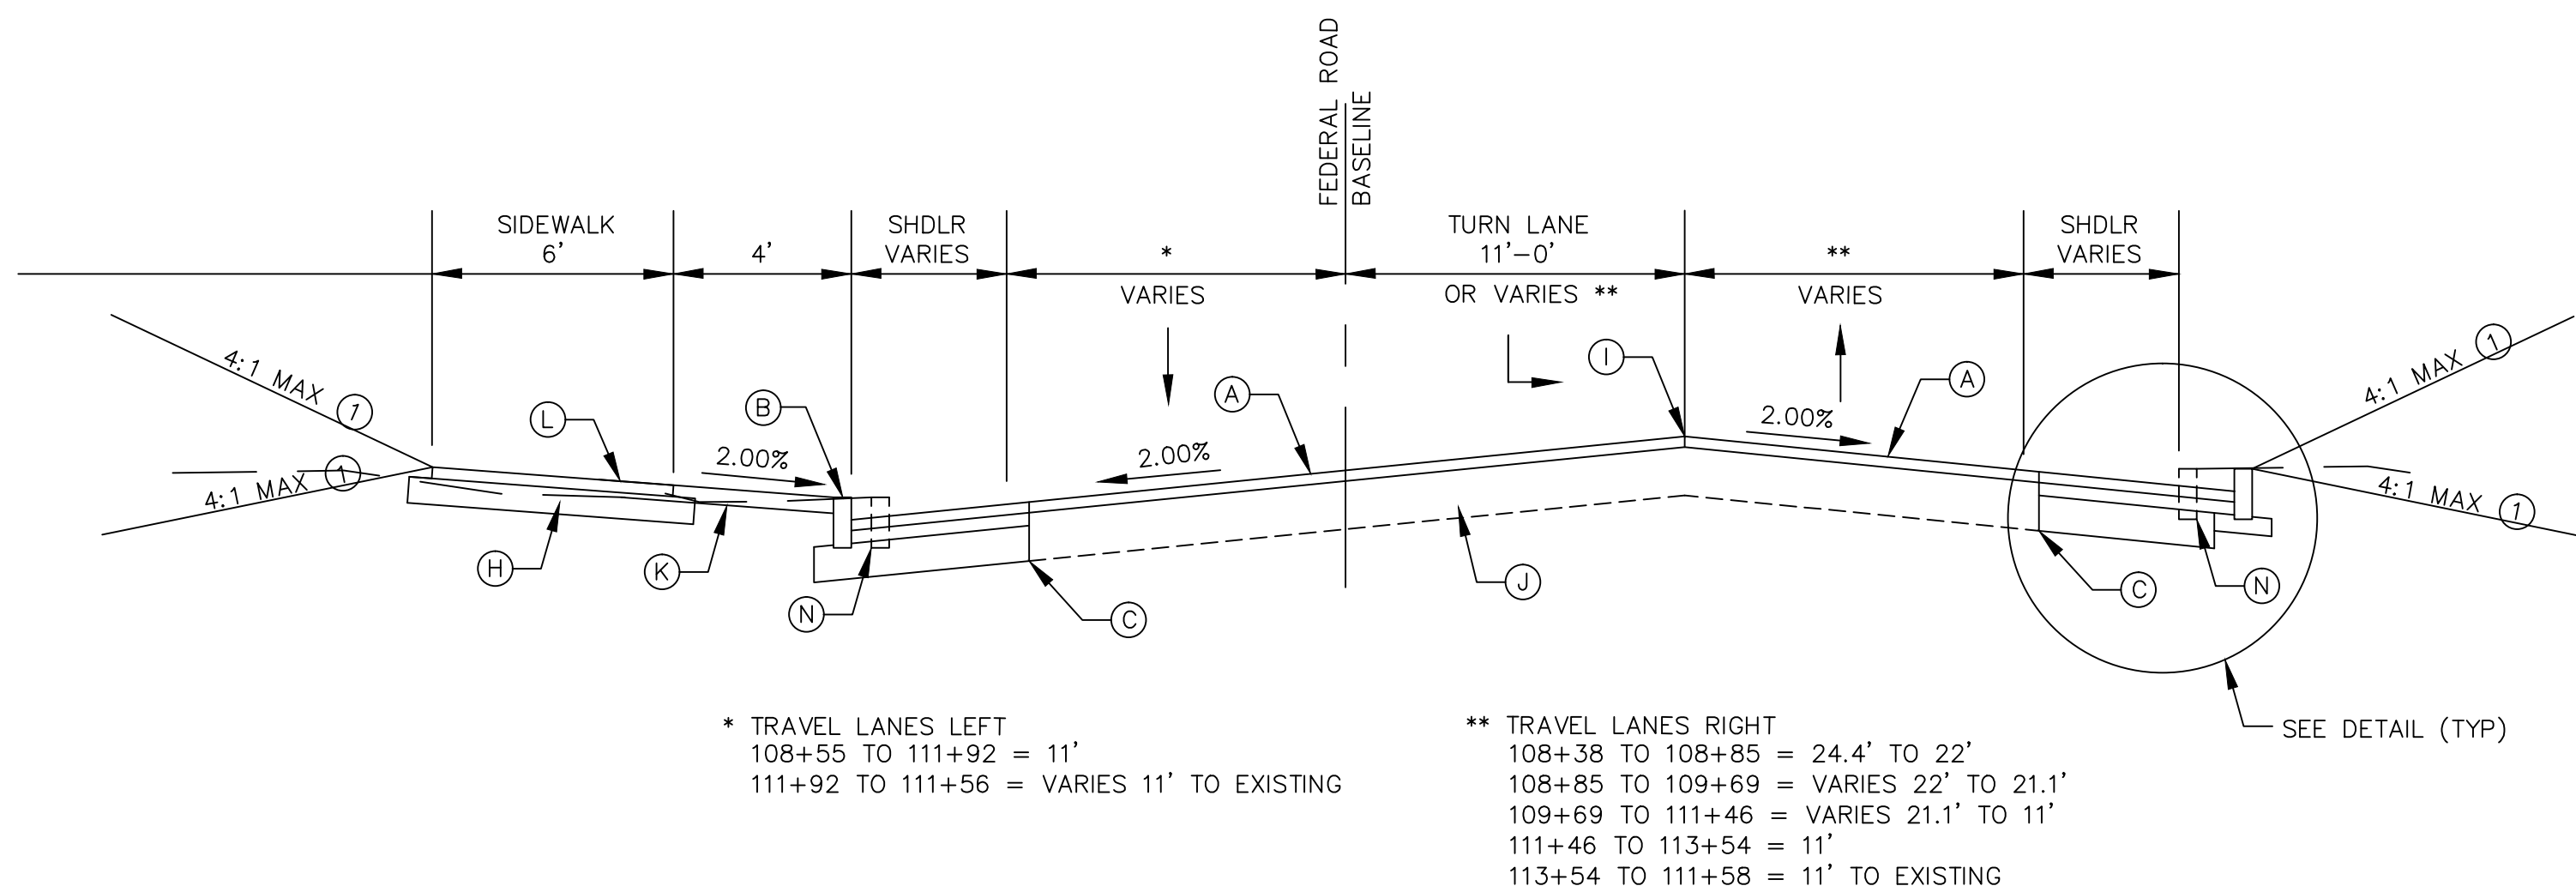
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FEDERAL RD TYPICAL SECTION NO. 1
STA. 100+00 TO 103+25 ±



FEDERAL RD TYPICAL SECTION NO. 2
STA. 103+25 ± TO 106+16



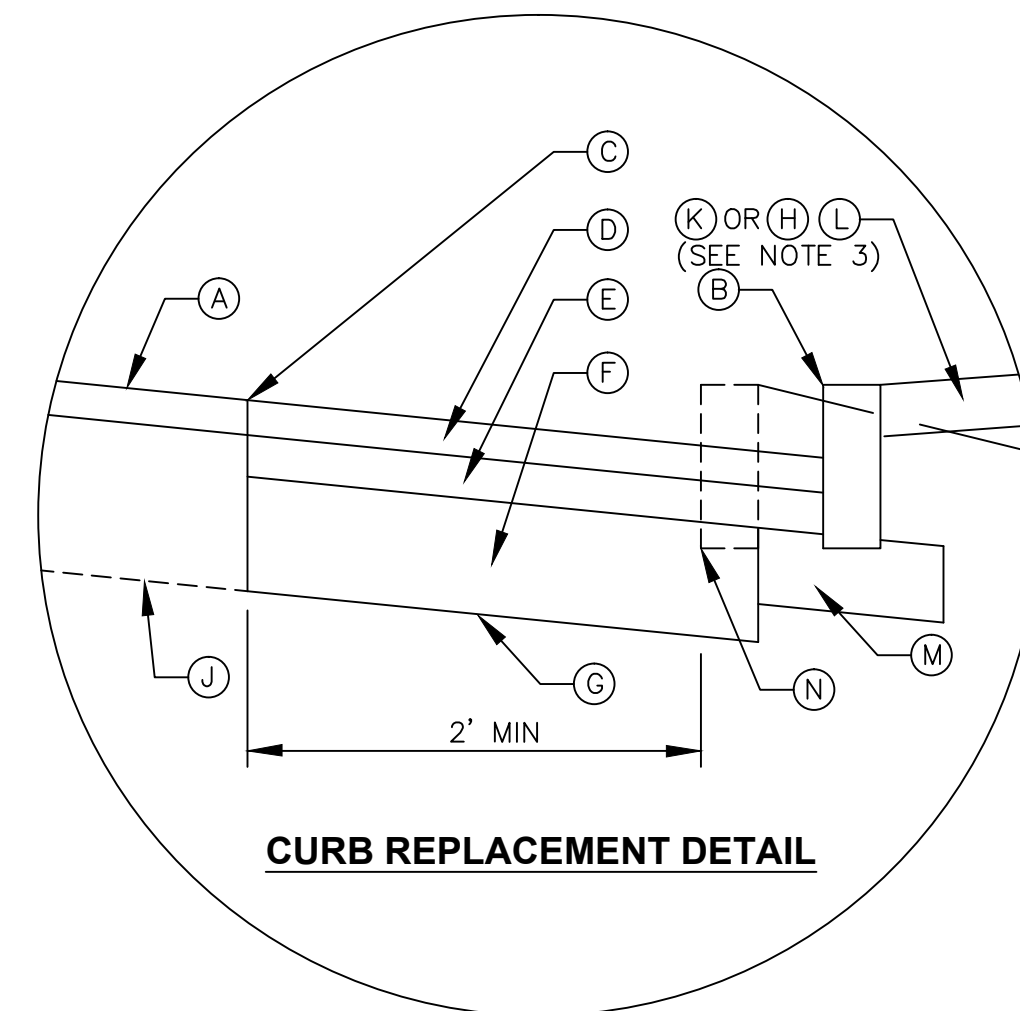
FEDERAL RD TYPICAL SECTION NO. 3
STA. 106+16 TO 113+50

TYPICAL SECTION LEGEND:

- (A) 1-1/2" MILL & 1-1/2" BITUMINOUS OVERLAY
- (B) GRANITE CURB (RESET OR NEW - SEE PLANS FOR LOCATIONS AND APPLICABLE DETAILS)
- (C) SAW CUT PAVEMENT
- (D) 3" HMA S0.375
- (E) 6" HMA S1
- (F) 10" SUBBASE
- (G) FORMATION OF SUBGRADE
- (H) 8" GRANULAR FILL
- (I) POINT OF APPLICATION OF GRADE
- (J) EXISTING ROADWAY STRUCTURE
- (K) 4" TOPSOIL AND TURF ESTABLISHMENT
- (L) CONCRETE SIDEWALK WITH BRICK PAVERS (SEE DETAIL)
- (M) 6" GRANULAR FILL
- (N) EXISTING CURB TO BE REMOVED
- (O) BITUMINOUS CONCRETE BIKE PATH
- (Q) 6" BITUMINOUS CONCRETE LIP CURB (BCLC)
- (R) BRICK PAVERS
- (S) CONCRETE SIDEWALK

NOTES:

- (1) IN AREAS ADJACENT TO PAVED PARKING, ADJUST SLOPE TO MEET CUT/FILL LINE AS SHOWN ON THE PLANS.
- (2) INSTALL 6" BCLC AT BACK OF BIKE PATH STA. 102+40 ± TO 103+25 ±.
- (3) BRICK PAVERS (R) SHALL BE USED INSTEAD OF TOPSOIL AND TURF (K) WHEN DISTANCE FROM FACE OF CURB TO FRONT OF SIDEWALK IS LESS THAN 3 FEET.
- (4) AT DRIVEWAYS, REDUCE BIKE PATH TO 6.5' TO ACCOMMODATE APRON.



TOWN OF BROOKFIELD, CT

PROJECT NAME: **TOWN DISTRICT SIDEWALK AND ACCESS MANAGEMENT PLAN**

SHEET TITLE: **FEDERAL ROAD, TYPICAL SECTIONS**

FILE NAME:----

PLOT DATE: 4/20/2016

DRAWING NO.: **TY-01**

PROJECT LEADER: SM

DRAWN BY: AG





DESIGNED BY: AG

CHECKED BY: PG

SHEET NO.: **5**



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TYPICAL SECTION LEGEND:

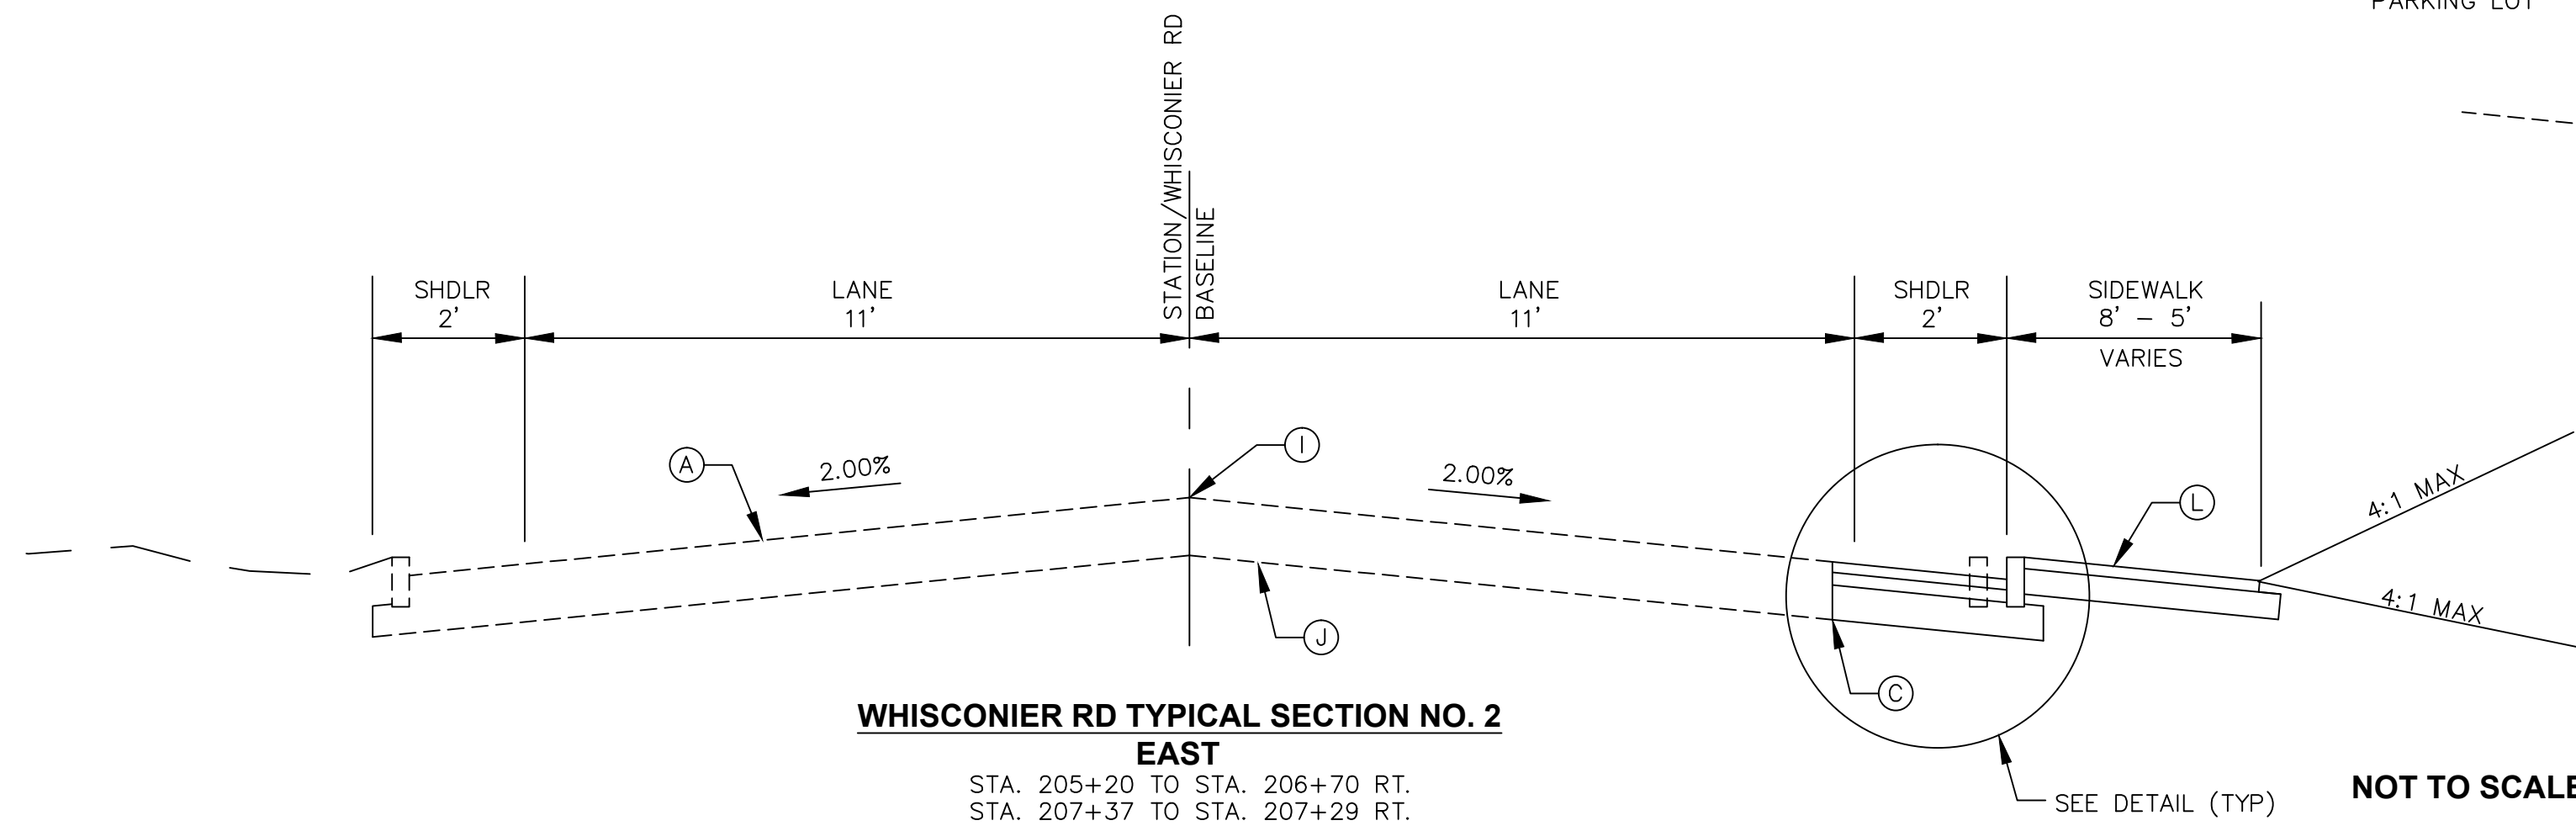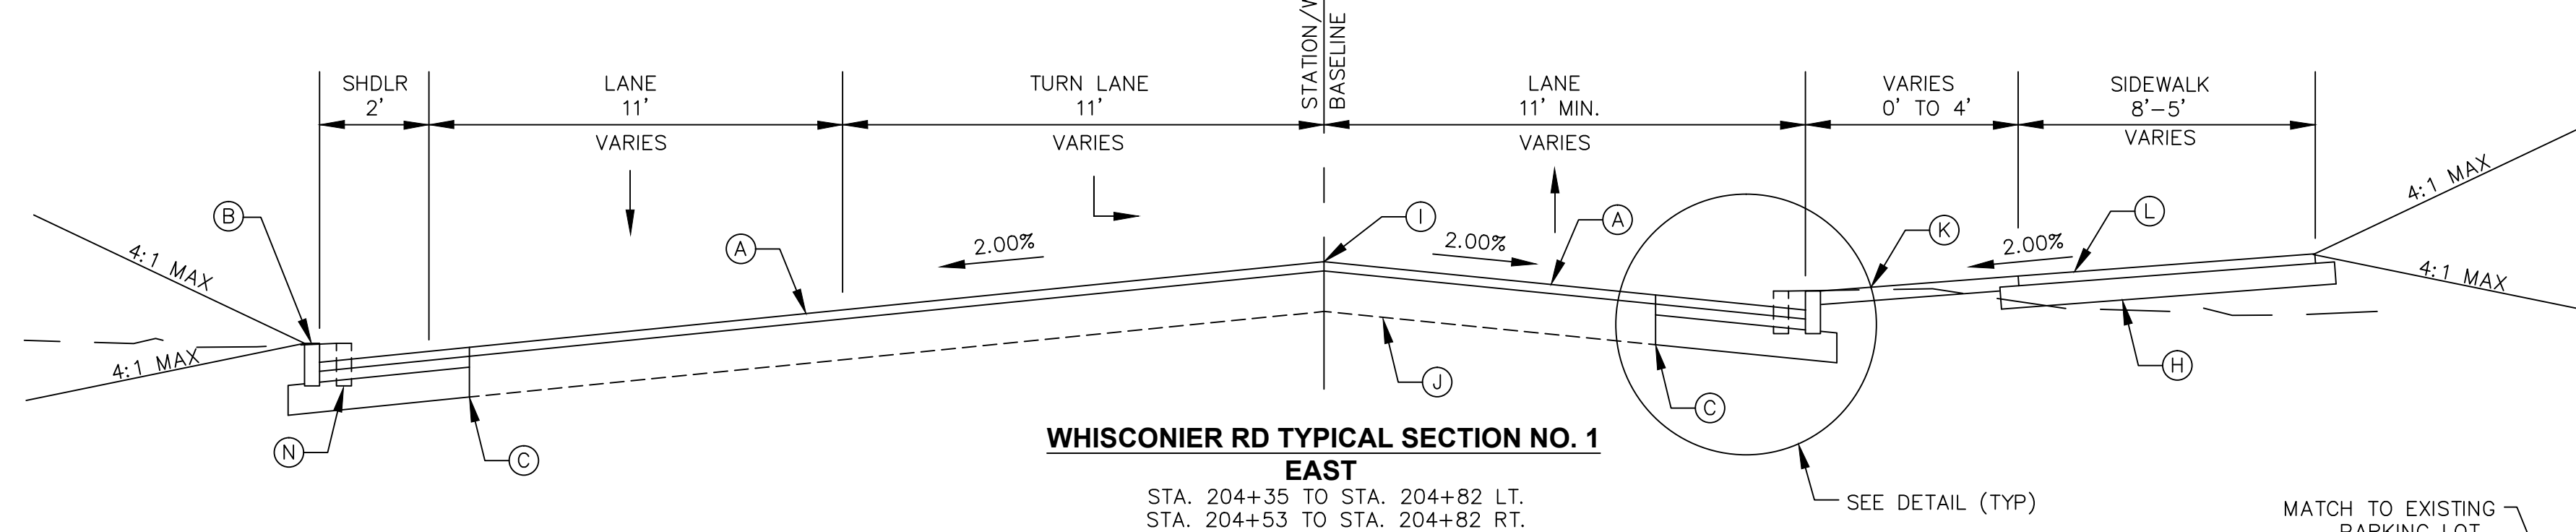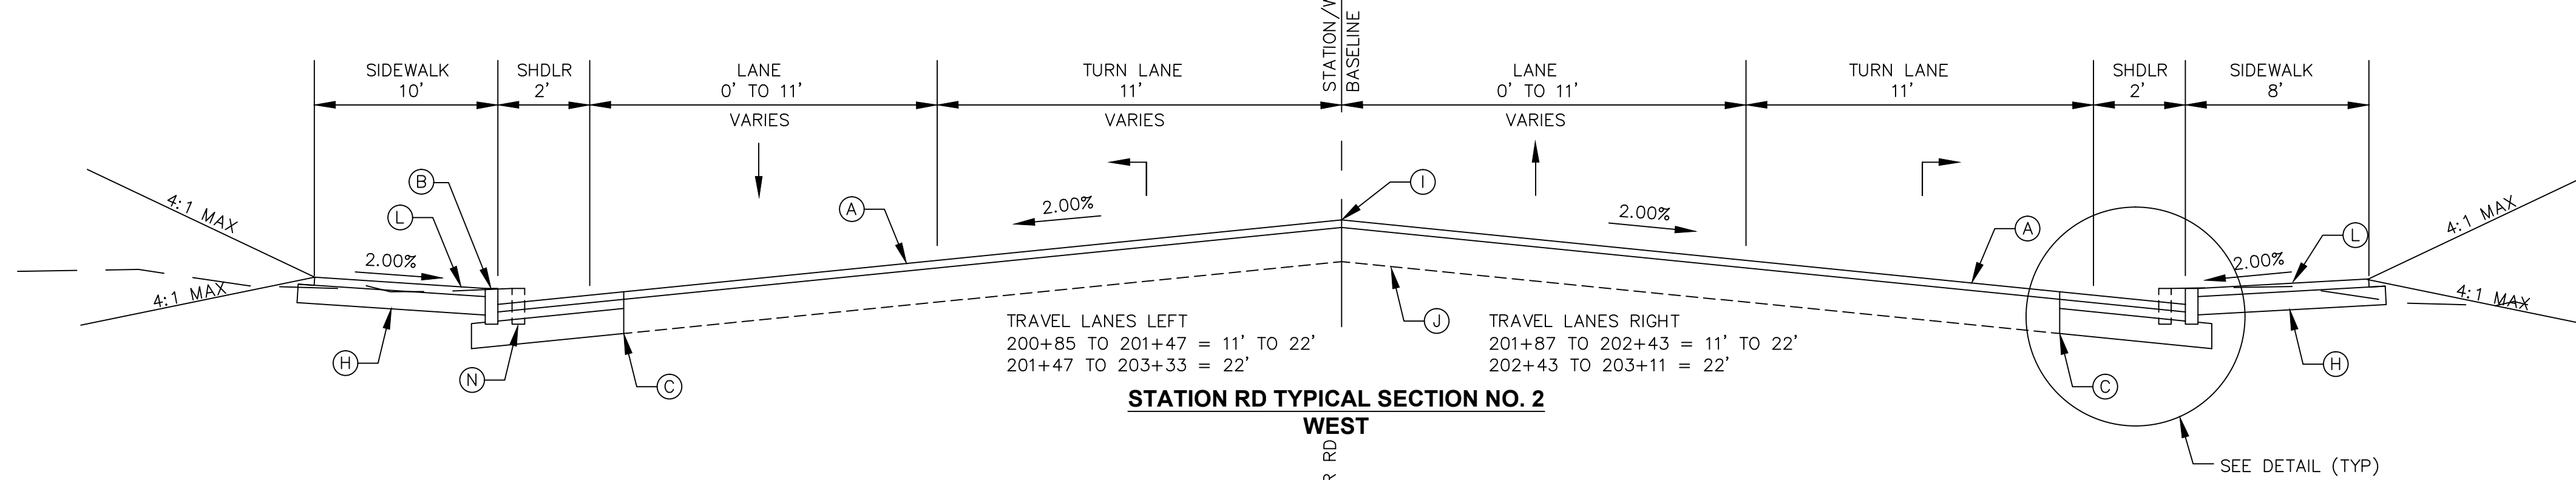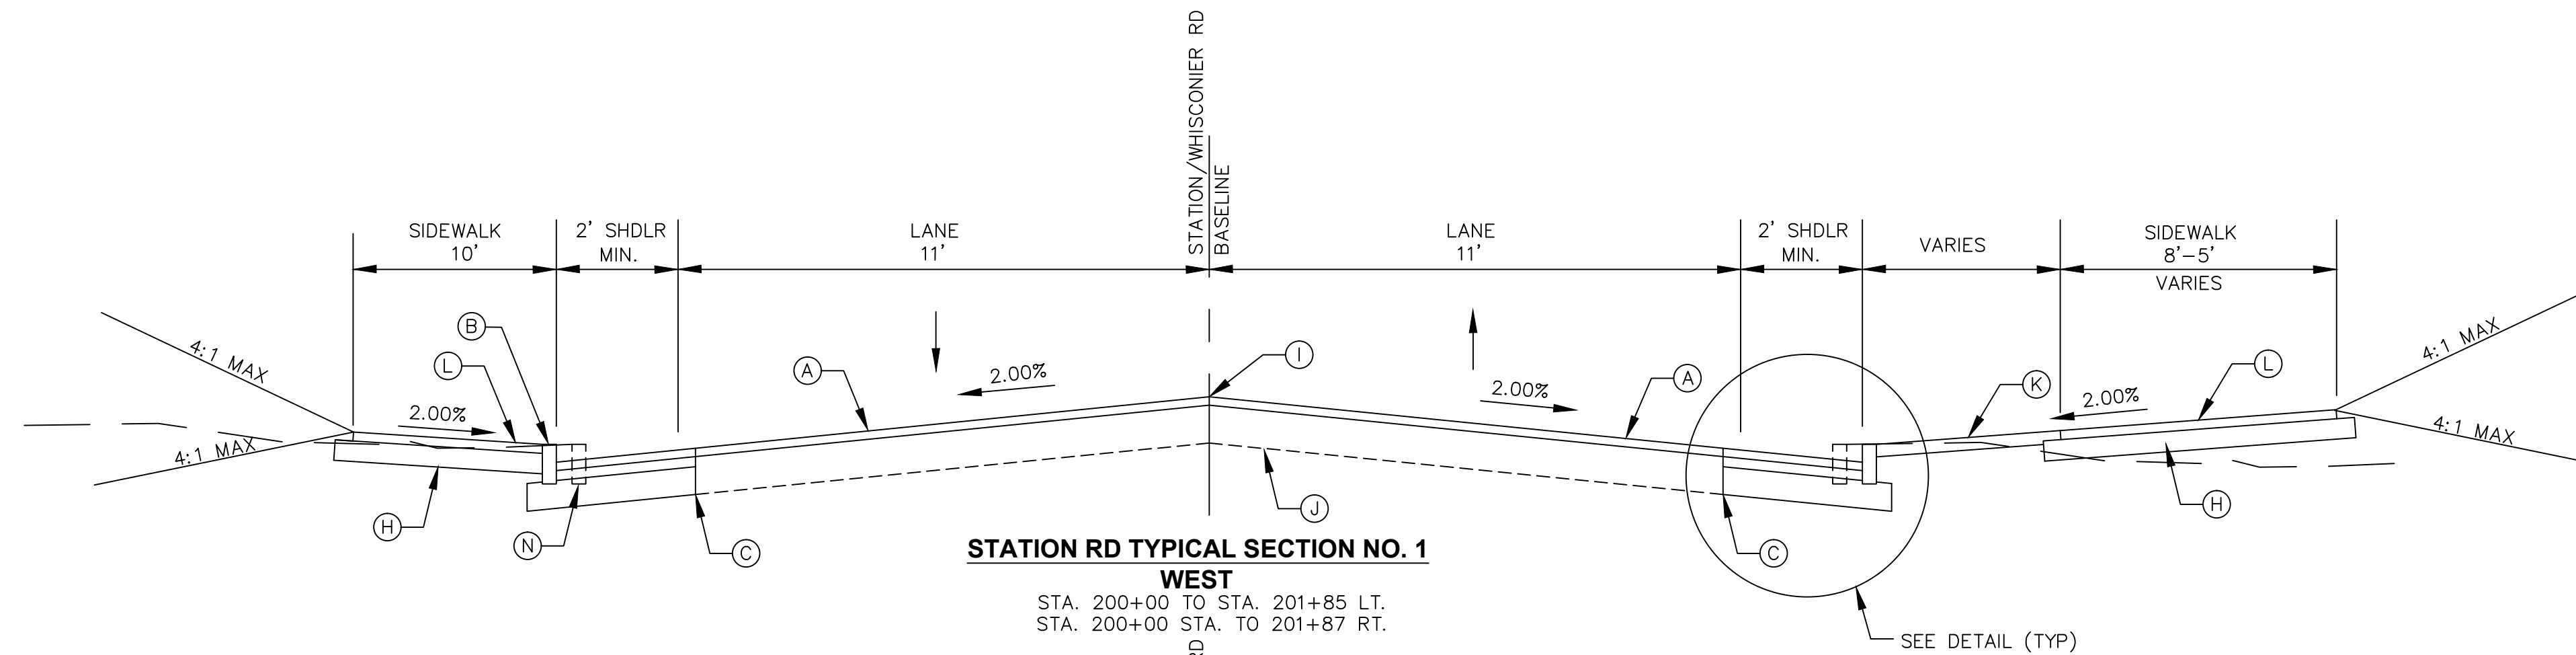- (A) 1-1/2" MILL & 1-1/2" BITUMINOUS OVERLAY
- (B) GRANITE CURB (RESET OR NEW - SEE PLANS FOR LOCATIONS AND APPLICABLE DETAILS)
- (C) SAW CUT PAVEMENT
- (D) 3" HMA S0.375
- (E) 6" HMA S1
- (F) 10" SUBBASE
- (G) FORMATION OF SUBGRADE
- (H) 8" GRANULAR FILL
- (I) POINT OF APPLICATION OF GRADE
- (J) EXISTING ROADWAY STRUCTURE
- (K) 4" TOPSOIL AND TURF ESTABLISHMENT
- (L) CONCRETE SIDEWALK WITH BRICK PAVERS
- (M) 6" GRANULAR FILL
- (N) EXISTING CURB TO BE REMOVED
- (O) BITUMINOUS CONCRETE BIKE PATH




TOWN OF BROOKFIELD, CT

PROJECT NAME: TOWN DISTRICT SIDEWALK AND ACCESS MANAGEMENT PLAN		DRAWING NO.: TY-02	
SHEET TITLE: STATION RD / WHISCONIER RD, TYPICAL SECTIONS		SHEET NO.: 6	
FILE NAME:----		PLOT DATE: 4/20/2016	DRAWN BY: AG
PROJECT LEADER: SM		CHECKED BY: PG	
DESIGNED BY: AG			

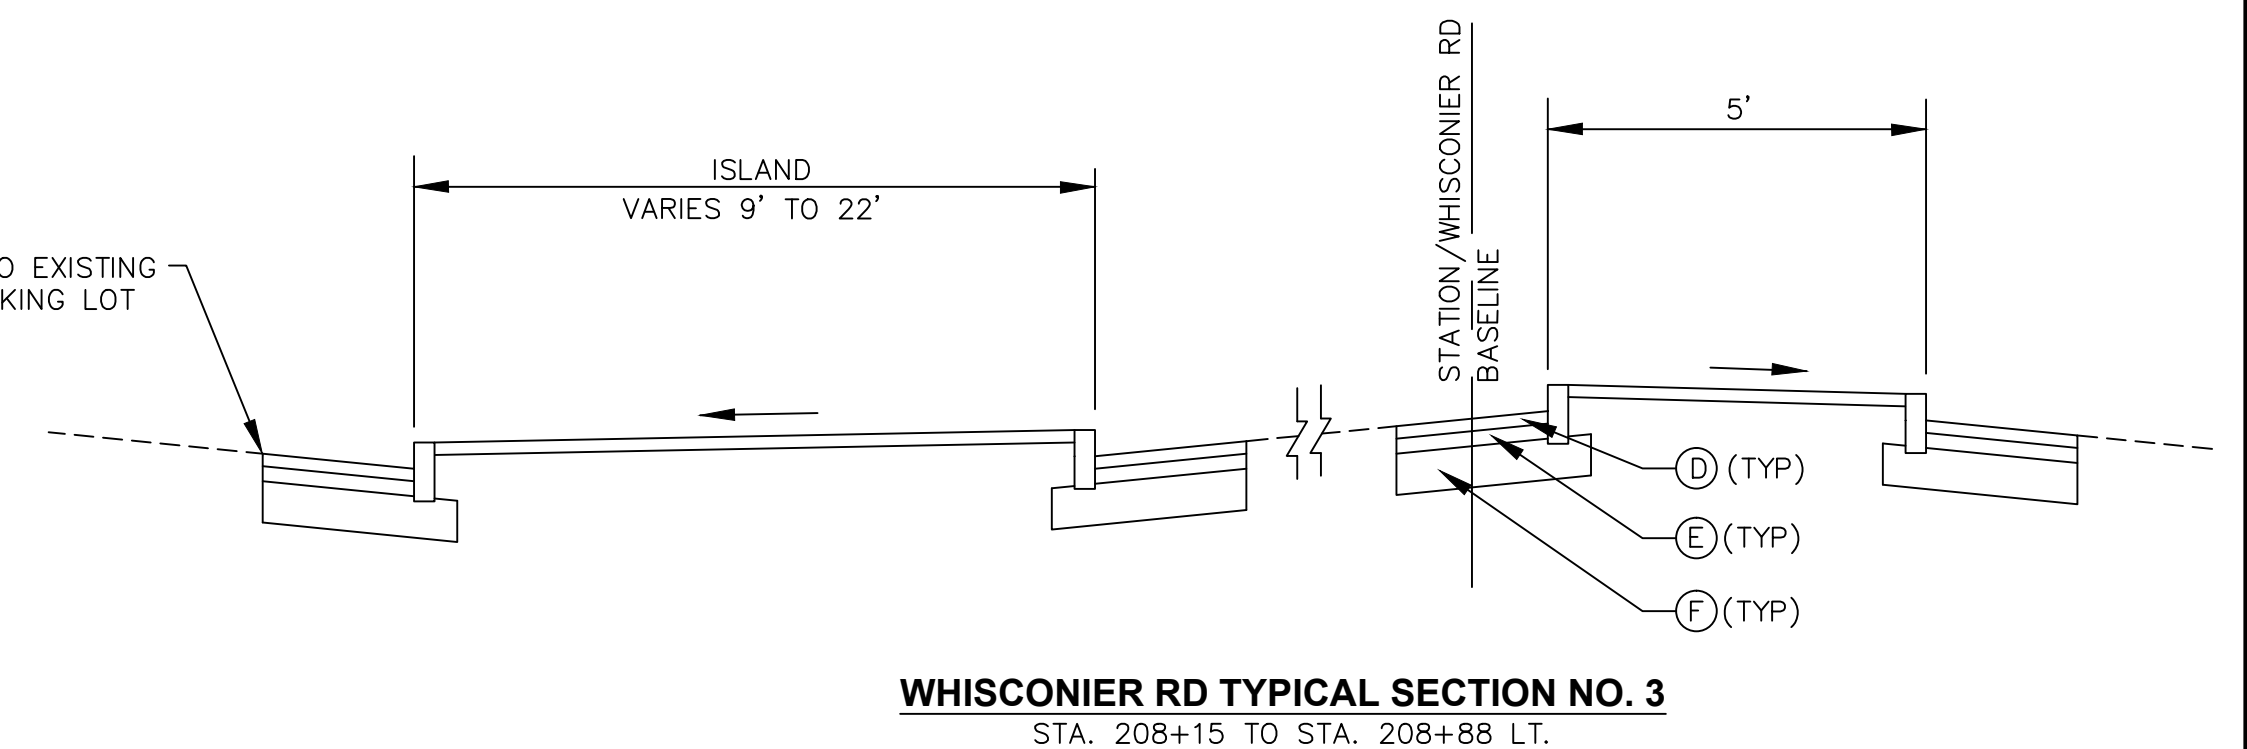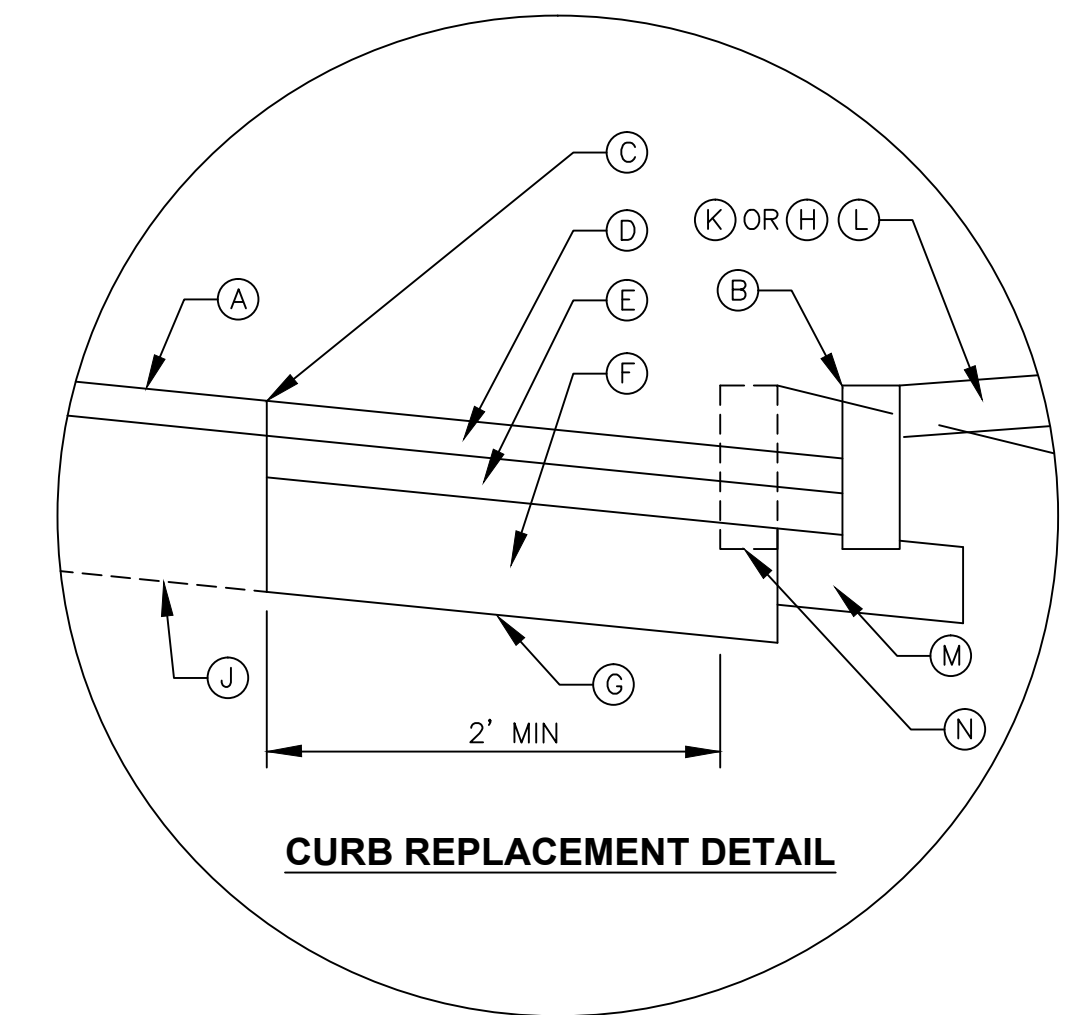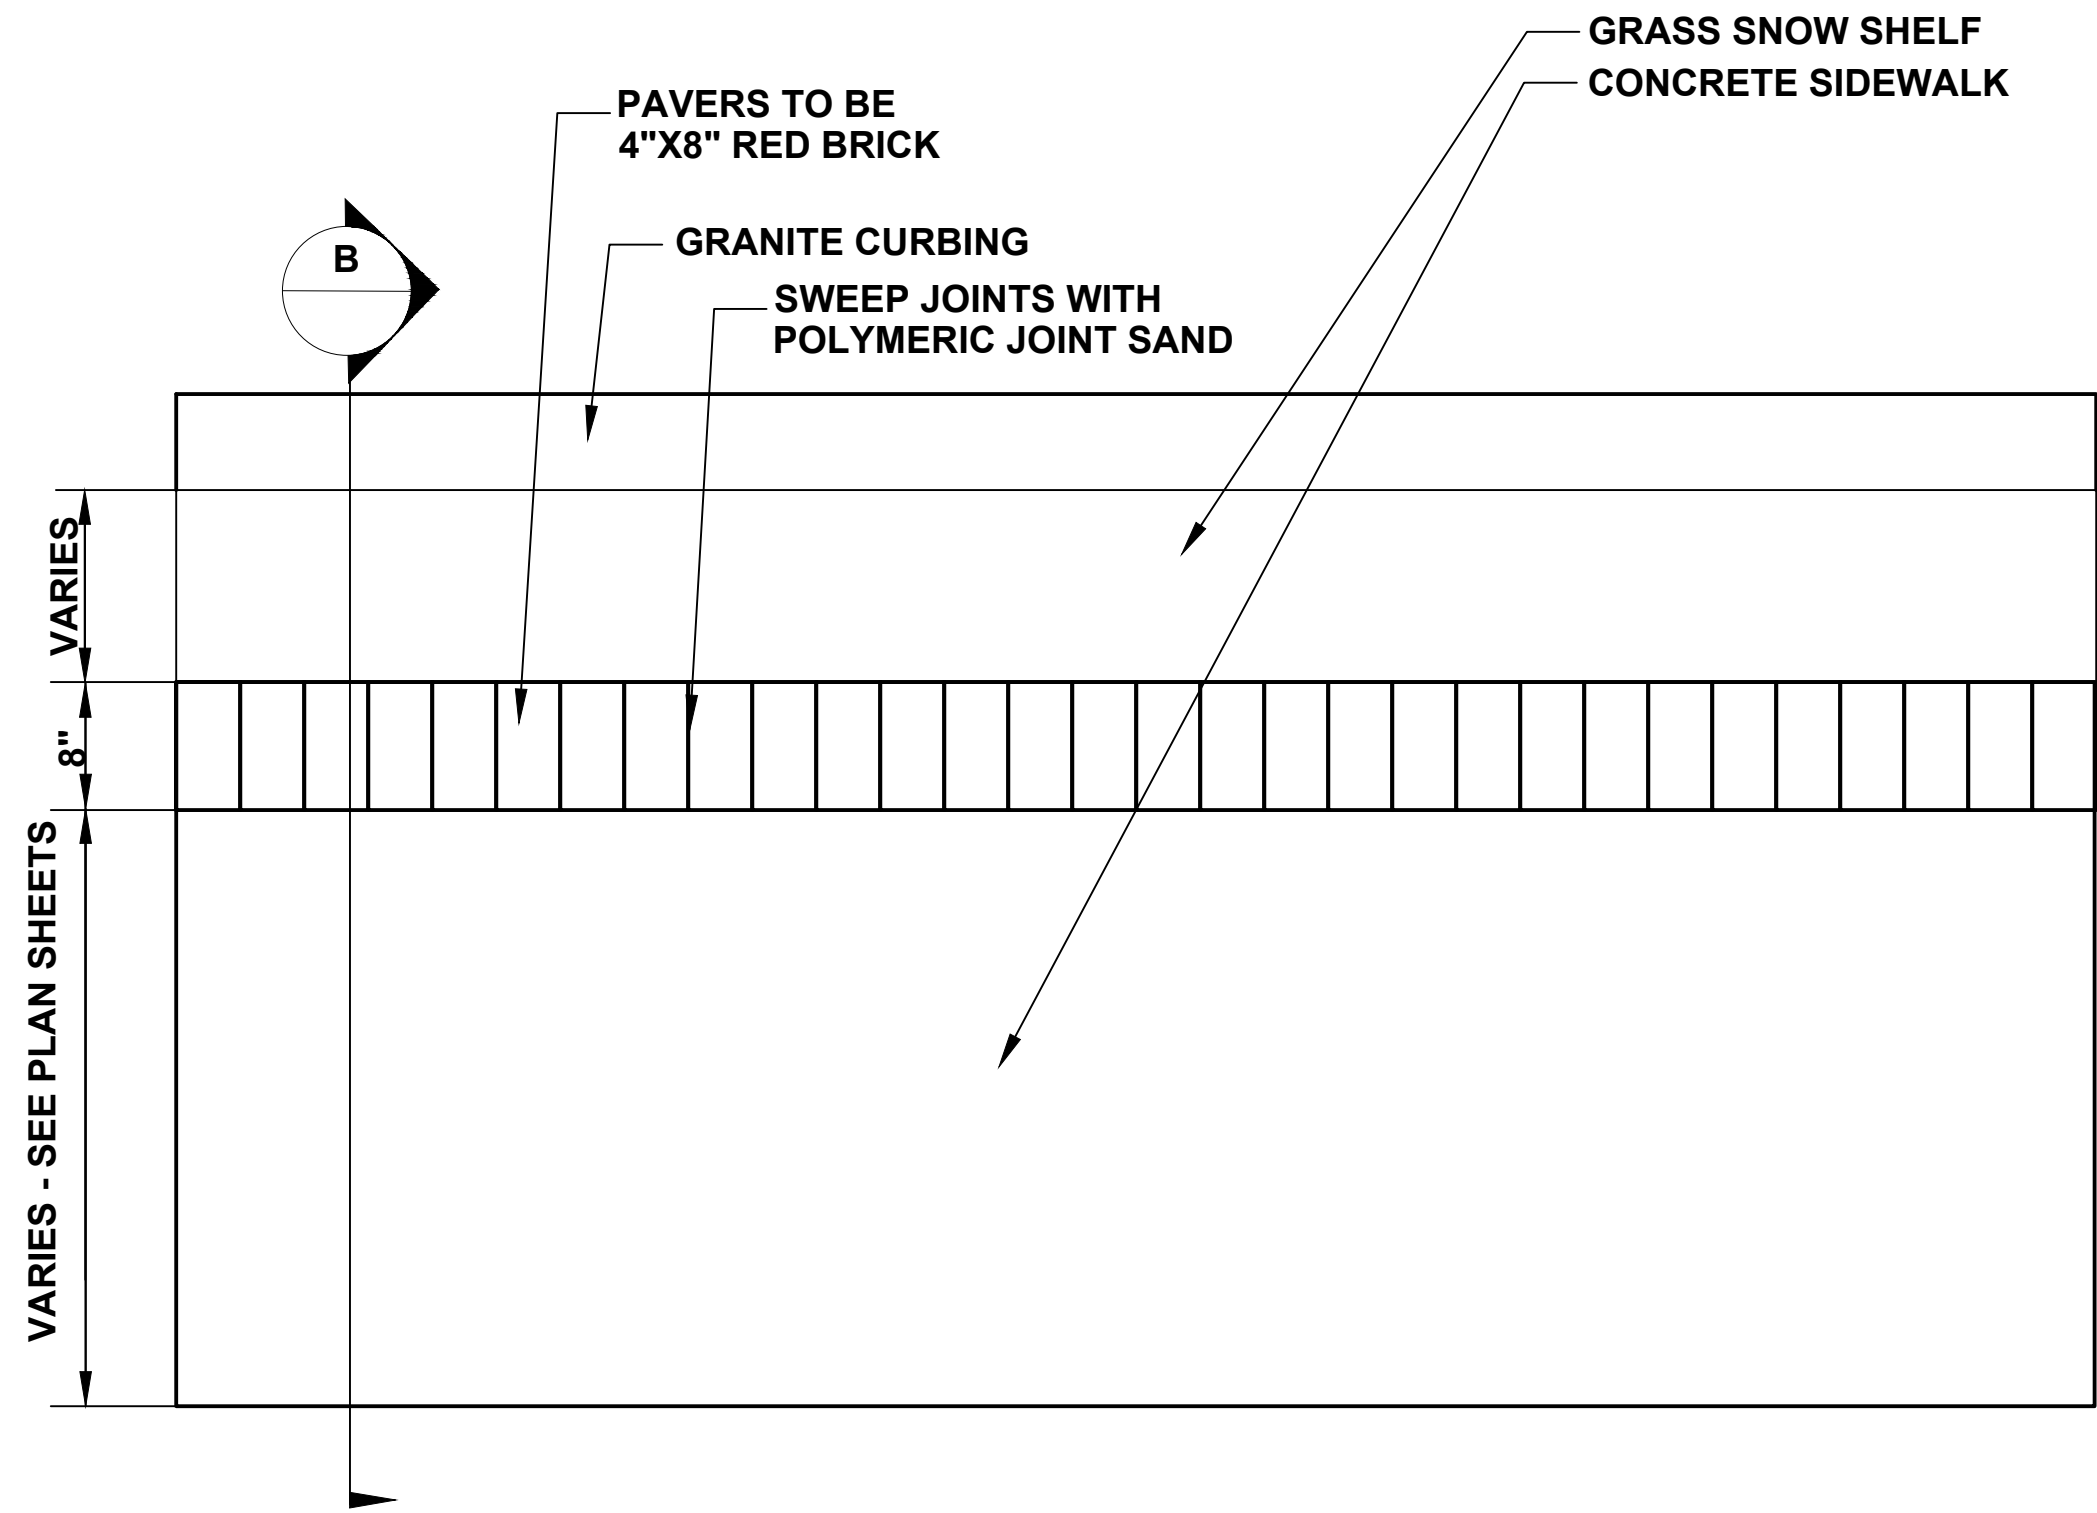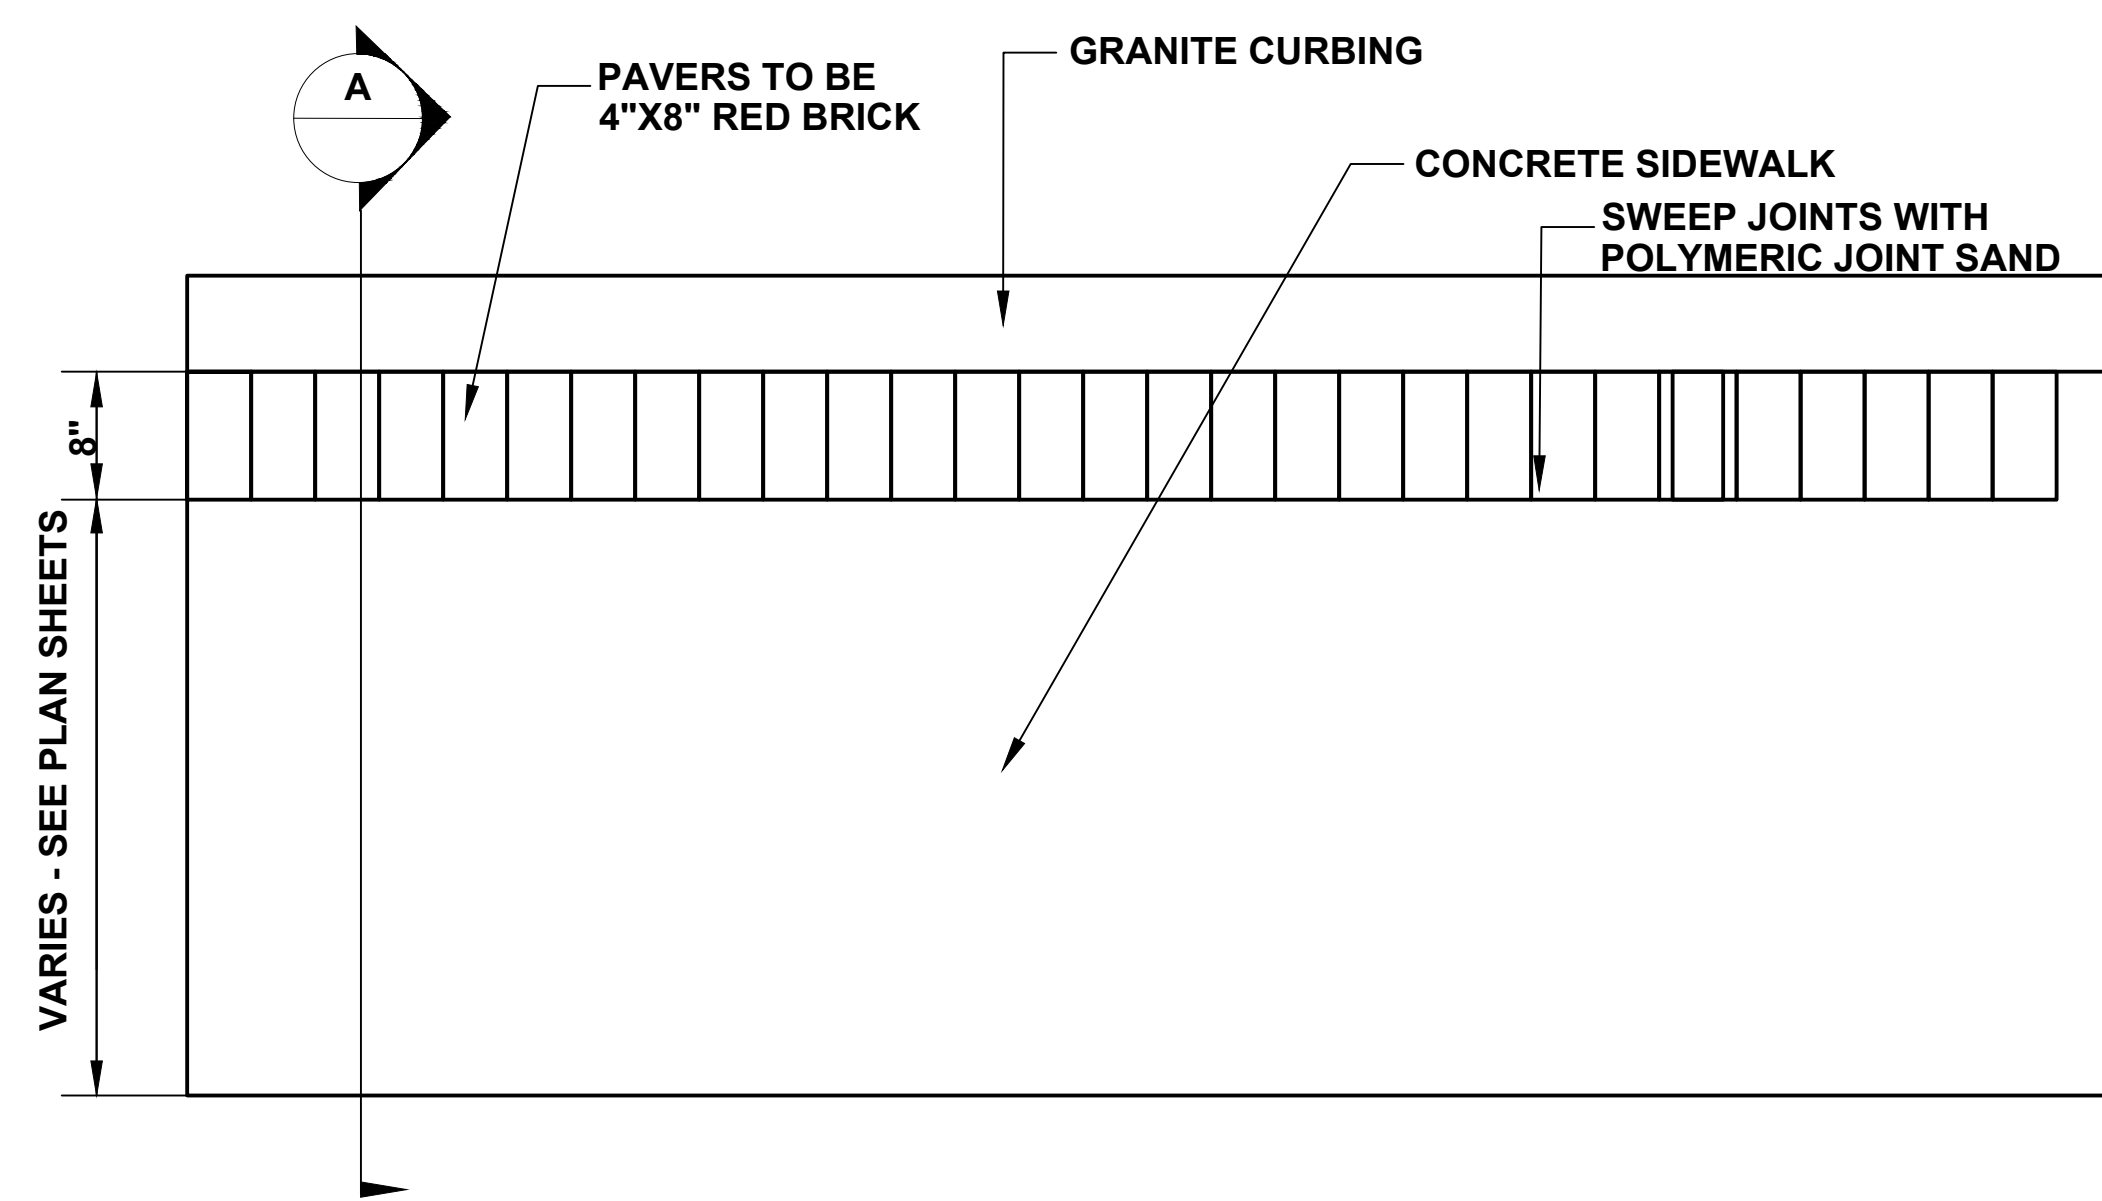
URS CORPORATION
500 ENTERPRISE DRIVE, SUITE 3B
ROCKY HILL, CT 06067
(860) 529-8882

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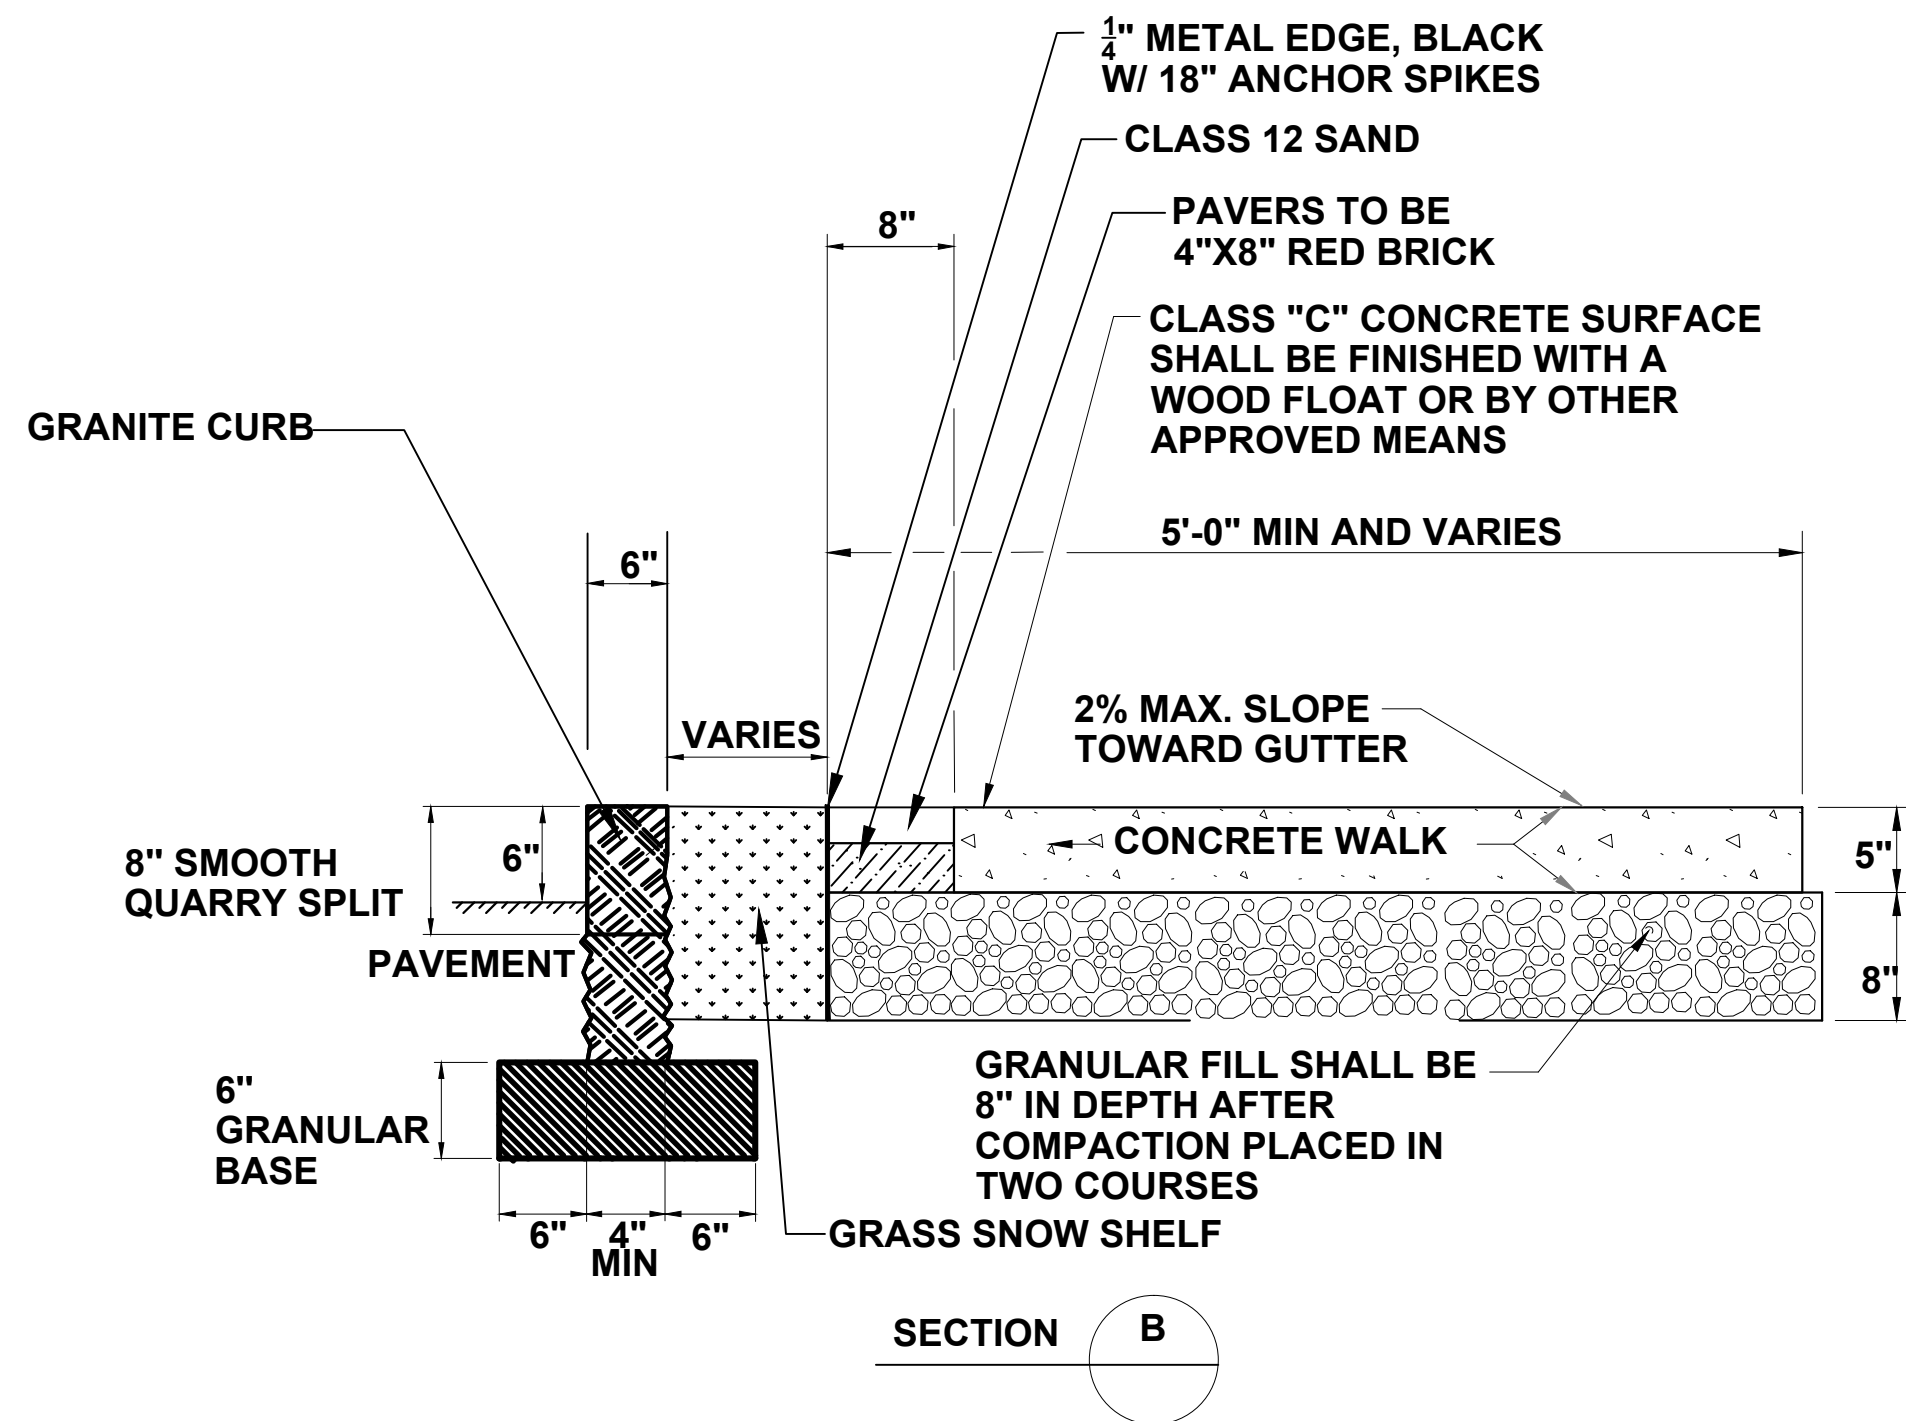
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SIDEWALK PAVEMENT TYPICAL WITH GRASS SNOW SHELF - PLAN VIEW
SCALE: 1" = 1'-0"




SIDEWALK PAVEMENT ADJACENT TO CURB TYPICAL - PLAN VIEW
SCALE: 1" = 1'-0"




SIDEWALK PAVEMENT WITH GRASS SNOW SHELF SECTION AND BRICK PAVERS
SCALE: 1" = 1'-0"

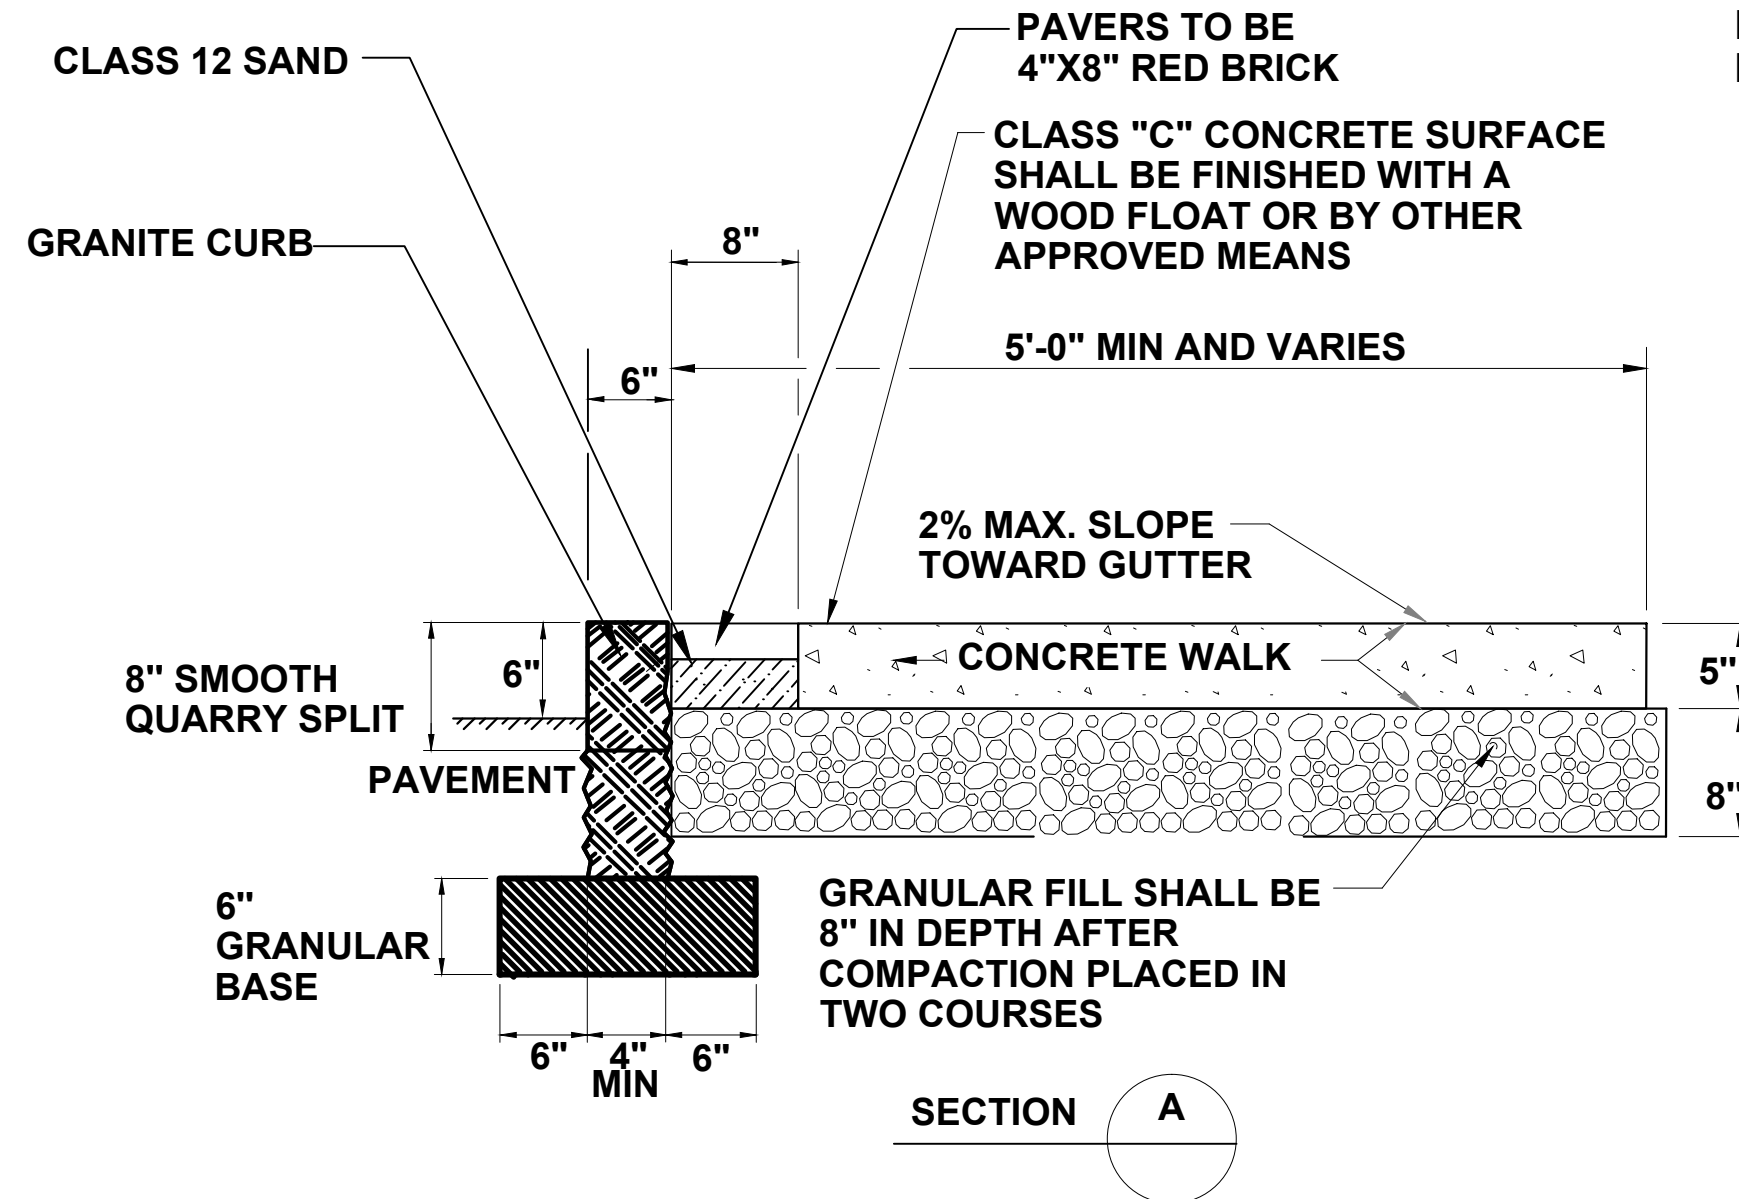NOTE:
1" PREMOLDED EXPANSION JOINT MATERIAL AT ALL HARD JOINTS (BETWEEN SECTION OF SIDEWALK, BUILDINGS, POLE FOUNDATION) EVERY 15'.



SIDEWALK PAVEMENT SECTION WITH BRICK PAVERS
SCALE: 1" = 1'-0"

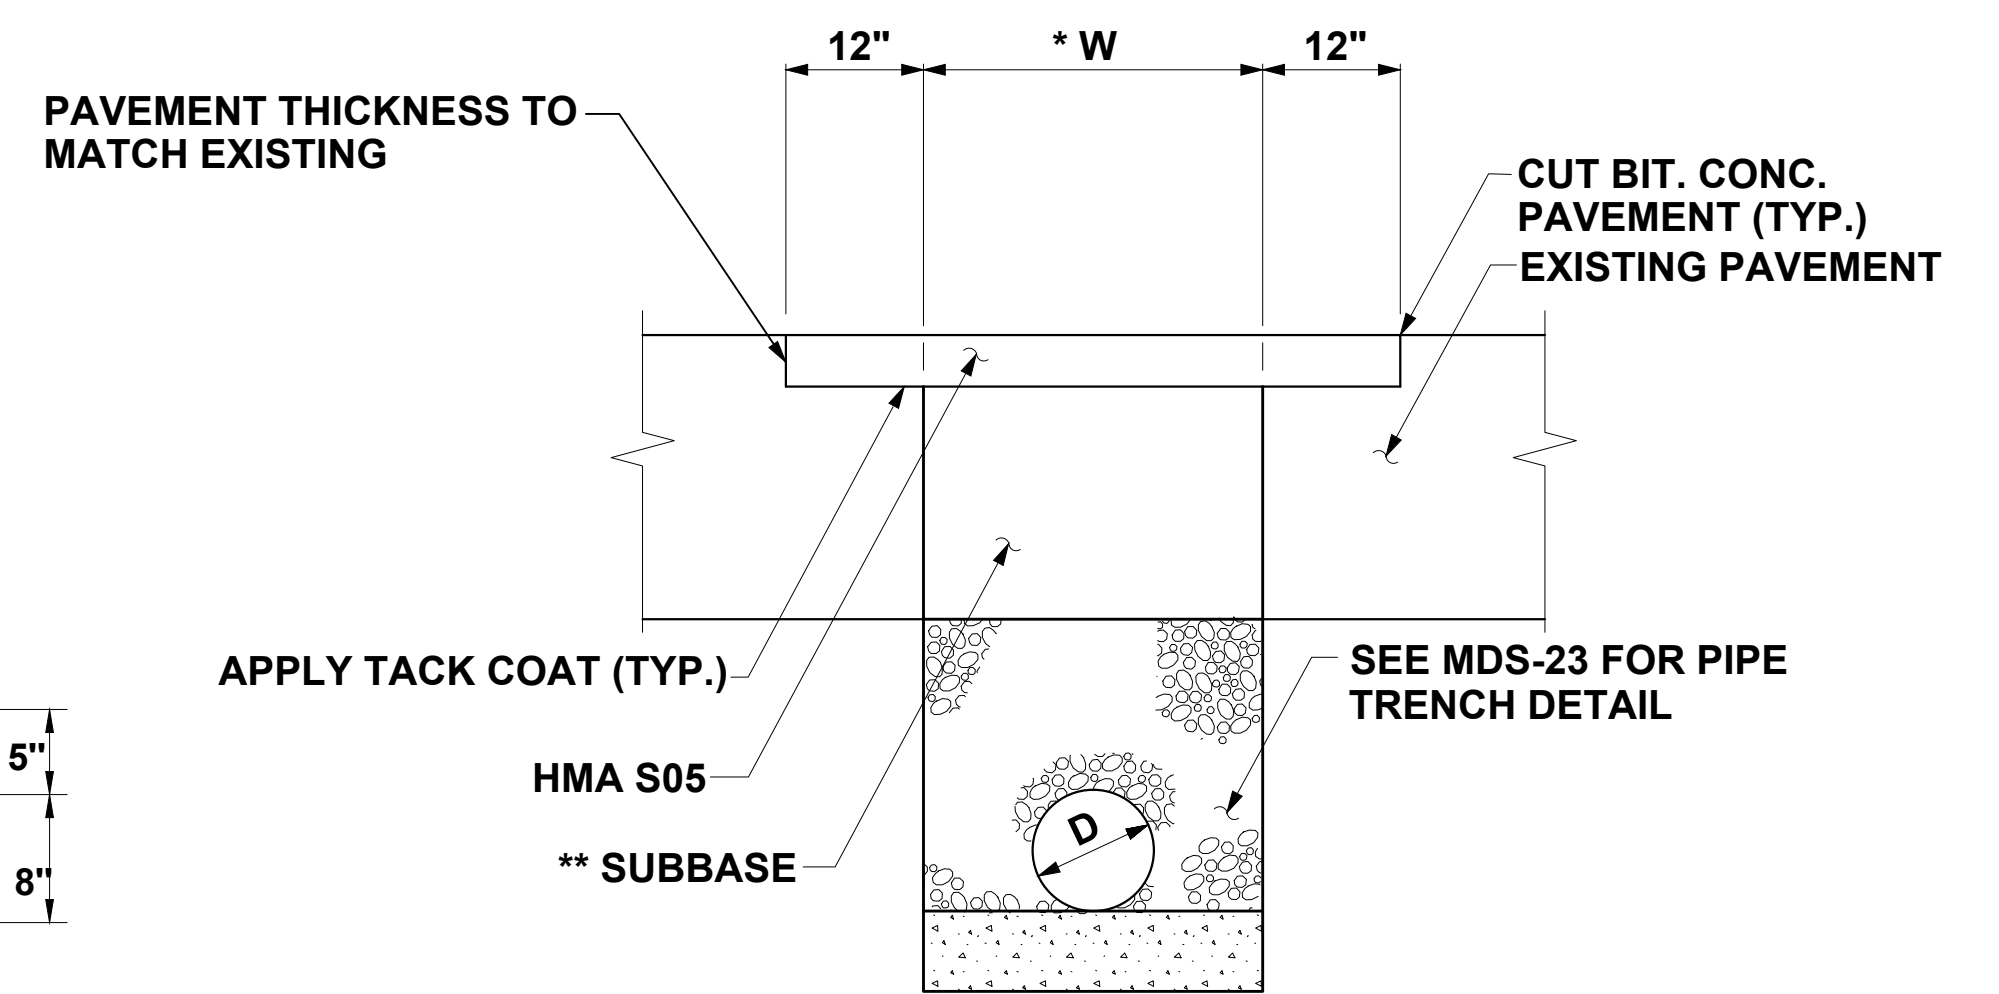NOTE:
1" PREMOLDED EXPANSION JOINT MATERIAL AT ALL HARD JOINTS (BETWEEN SECTION OF SIDEWALK, BUILDINGS, POLE FOUNDATION).




PAVEMENT REPAIR FOR TRENCH EXCAVATION
SCALE: NTS

* FOR $D < 30"$, $W = D + 24"$
FOR $D > 30"$, $W = D + 36"$
** AS REQUIRED TO MEET BOTTOM OF EXIST. SUBBASE


TOWN OF BROOKFIELD, CT

AECOM 500 ENTERPRISE DRIVE, SUITE 3B ROCKY HILL, CT 06067 (860) 529-8882	PROJECT NAME: TOWN DISTRICT SIDEWALK AND ACCESS MANAGEMENT PLAN	
	SHEET TITLE: MISCELLANEOUS DETAILS	
	FILE NAME: ----	PLOT DATE: 4/20/2016
PROJECT LEADER: SM DESIGNED BY: AG	DRAWN BY: AG CHECKED BY: PG	DRAWING NO.: MDS-01
		SHEET NO.: 7

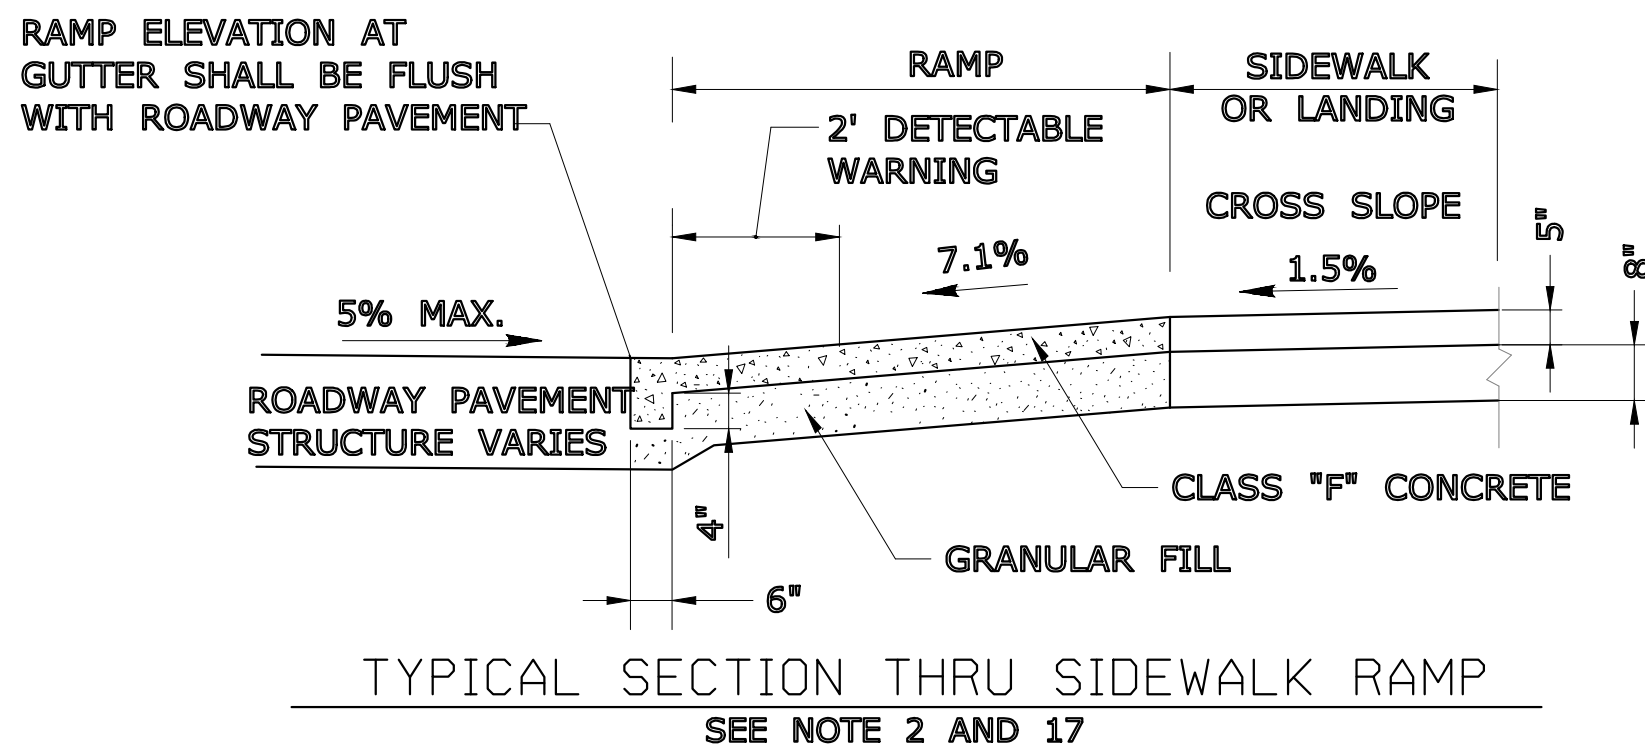1. MAXIMUM SLOPES OF ADJOINING GUTTERS AND ROAD SURFACES IMMEDIATELY ADJACENT TO THE SIDEWALK RAMP SHALL NOT EXCEED 5%. THE MAXIMUM GRADE DIFFERENCE BETWEEN THE GUTTER AND CURB RAMP SHALL NOT EXCEED 13%.
2. RAMP GRADE SHALL BE UNIFORM, FREE OF SAGS AND ABRUPT GRADE CHANGES. RUNNING SLOPES OF RAMPS SHALL NOT EXCEED 8.3%.
3. ALL RAMPS SHALL BE CONSTRUCTED OF CLASS "F" CONCRETE IN ACCORDANCE WITH CONNECTICUT STANDARD SPECIFICATIONS.
4. SIDEWALK RAMPS SHALL HAVE A COARSE BROOM FINISH TRANSVERSE TO THE SLOPE OF THE RAMP. THE SURFACE OF ALL SIDEWALK RAMPS SHALL BE STABLE, FIRM AND SLIP RESISTANT. SURFACE DISCONTINUITIES SHALL NOT EXCEED 1/2" MAX. VERTICAL DISCONTINUITIES BETWEEN 1/4" AND 1/2" MAX. SHALL BE BEVELED 1:2 MINIMUM APPLIED ACROSS THE ENTIRE LEVEL CHANGE.
5. DIAGONAL SIDEWALK RAMPS AT MARKED CROSSINGS SHALL BE WHOLLY CONTAINED WITHIN THE MARKINGS, EXCLUDING ANY FLARED SIDES. DIAGONAL AND PERPENDICULAR RAMPS SHALL HAVE THE RAMP CUT PERPENDICULAR TO THE TANGENT OF THE CURB RADIUS FOR THE DESIGNATED ACCESSIBLE ROUTE. BOTH LONGITUDINAL SIDES OF THE RAMP SHOULD BE THE SAME LENGTH. SKEWED RAMPS SHOULD BE AVOIDED. FLARES ARE NOT CONSIDERED PART OF PEDESTRIAN ACCESS ROUTE. DIAGONAL RAMPS SHOULD NOT BE INSTALLED WHERE CURB RADII IS LESS THAN 20'(6096).
6. REMOVAL OF EXISTING SIDEWALK FOR NEW RAMP INSTALLATIONS SHALL BE TO THE NEAREST EXPANSION OR CONTRACTION JOINT. 8.3% MAXIMUM SLOPE MAY NOT BE ACHIEVABLE DUE TO EXISTING SIDEWALK GRADE. IN RECOGNITION OF THIS, A LIMIT OF 15' FOR REMOVAL SHALL BE USED UNLESS OTHERWISE SHOWN ON THE PLANS OR DIRECTED BY THE ENGINEER. SAW CUT REQUIRED FOR DUMMY JOINTS SHALL BE INCLUDED IN THE COST OF "CONCRETE SIDEWALK RAMP" OR "CONCRETE SIDEWALK".
7. EXPANSION JOINTS IN CONCRETE SHALL MATCH THOSE IN ADJACENT SIDEWALKS BUT IN NO CASE SHALL THE SPACING BETWEEN EXPANSION JOINTS EXCEED 12' UNLESS OTHERWISE NOTED.
8. CONCRETE SIDEWALK RAMPS, SHALL BE PAID FOR UNDER THE ITEM "CONCRETE SIDEWALK RAMP", AS DEFINED BY THE CONSTRUCTION LIMITS ON THE PLANS AND SHALL BE FIELD VERIFIED.
9. SIDEWALK RAMPS SHALL BE CONSTRUCTED WITH THE TOE AT THE GUTTER CAST INTEGRALLY WITH RAMP UNLESS DIRECTED OTHERWISE BY THE ENGINEER (SEE TYPICAL SECTION ON THIS SHEET). CURB REMOVAL AND CAST IN PLACE CURBING REQUIRED FOR THE RAMP, SHALL BE INCLUDED WITH PAY ITEM "CONCRETE SIDEWALK RAMP". CURBING OUTSIDE LIMITS OF RAMP OR LANDING SHALL BE CONSTRUCTED AND PAID FOR IN ACCORDANCE WITH CONNECTICUT STANDARD SPECIFICATIONS.
10. PREFERRED LOCATION TO INSTALL DETECTABLE WARNING STRIP SHALL BE 6" FROM THE EDGE OF ROAD ALONG THE FULL WIDTH OF THE RAMP.
11. TO PERMIT WHEELCHAIR WHEELS TO ROLL BETWEEN DOMES, ALIGN DOMES ON A SQUARE GRID IN THE DIRECTION OF RUNNING SLOPE (PERPENDICULAR TO CURB OR SLOPE BREAK). THE TRANSITION FROM RAMP TO GUTTER SHALL BE FLUSH WITHOUT A LIP.
12. WHERE COMMERCIAL DRIVEWAYS ARE PROVIDED WITH TRAFFIC SIGNALS AND THE SIDEWALK IS CONTINUOUS THROUGH DRIVEWAY, DETECTABLE WARNINGS ARE REQUIRED AT THE JUNCTION BETWEEN THE PEDESTRIAN ROUTE AND DRIVEWAY.
13. RESTRICT TO SIDEWALK CURB WHEN THERE IS INSUFFICIENT BUFFER AVAILABLE TO GRADE OR WHEN CALLED FOR IN PLANS. PAID FOR WITH SIDEWALK RAMP WHEN REQUIRED FOR RAMP.
14. THE TOP AND BOTTOM OF RAMPS SHOULD BE PROVIDED WITH A 4' x 4' MINIMUM LEVEL LANDING AREA WITH A CROSS SLOPE LESS THAN OR EQUAL TO 2% IN ANY DIRECTION.
15. UTILITY POLES, LUMINAIRE, PEDESTRIAN OR SIGNAL POLES, GRATES, ACCESS COVERS, AND OTHER APPURTENANCES SHALL NOT BE LOCATED ON RAMPS, LANDINGS, BLENDED TRANSITIONS, AND @ GUTTERS WITHIN THE PEDESTRIAN ACCESS ROUTE.
16. APPROACH SIDEWALK WIDTHS, GRASS STRIP OR UTILITY STRIP WIDTHS MAY VARY.
17. APPROACH SIDEWALK AND LANDING CROSS SLOPE SHOULD NOT EXCEED 2%.
18. THE RUNNING OR CROSS SLOPES ON LANDINGS AT MID BLOCK CROSSING MAY BE WARPED TO MEET STREET OR HIGHWAY GRADE.
19. FOR PERPENDICULAR CURB RAMPS A MIN. 4' x 4' LEVEL LANDING SHALL BE PROVIDED AT THE TOP OF CURB RAMP. WHERE THE LEVEL LANDING IS RESTRICTED AT THE BACK OF SIDEWALK THE LEVEL LANDING SHALL BE 4' x 5' WITH THE 5' DIMENSION PROVIDED IN THE DIRECTION OF THE RAMP RUN.
20. FOR PARALLEL CURB RAMPS, A MIN. 4' x 4' LEVEL LANDING SHALL BE PROVIDED AT THE BOTTOM OF CURB RAMP. IF THE LEVEL LANDING IS RESTRICTED ON 2 OR MORE SIDES, THE LEVEL LANDING SHALL BE 4' x 5' WITH THE 5' DIMENSION PROVIDED IN THE DIRECTION OF THE PEDESTRIAN STREET CROSSING.
21. WHEN WIDTH OF SIDEWALK IS >48" AND A PERPENDICULAR SIDEWALK RAMP IS INSTALLED, THE FLARED SIDES SHALL BE 10% MAX. IF WIDTH OF SIDEWALK IS <48" THE FLARED SIDES MUST NOT EXCEED 8.33% (12:1).
22. SHADED AREAS ARE TYPICAL PAY LIMITS FOR CONCRETE SIDEWALK RAMP BUT, MAY VARY AS DIRECTED BY THE ENGINEER.
23. OPTIONAL RAMP, WHEN REQUIRED, SHALL BE PAID FOR AS PART OF CONCRETE SIDEWALK RAMP.
24. ALL PAVERS ARE TO BE PERPENDICULAR TO THE CURB. ONLY WHOLE RED BRICK PAVERS ARE TO BE USED.




DETECTABLE WARNING PLACEMENT

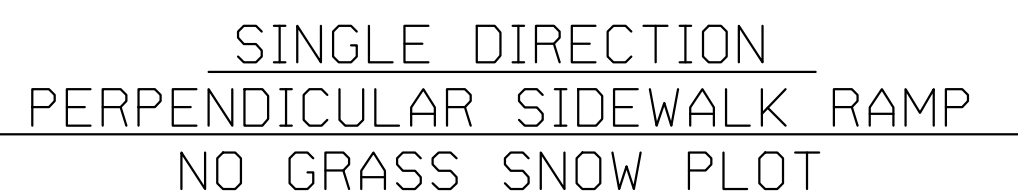

TYPE 4a



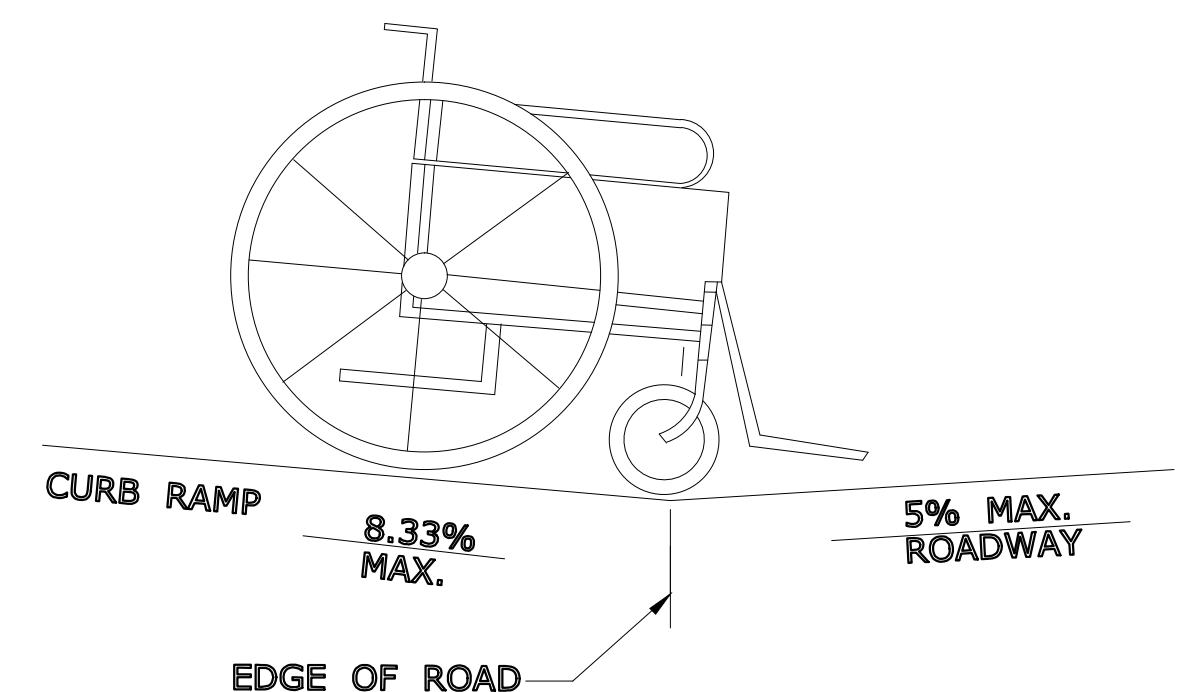TYPE 2



DETAIL 1
SEE GRADE CHANGE AT ROADWAY INTERFACE


TOWN OF BROOKFIELD, CT

SHEET NO.:

URS CORPORATION
500 ENTERPRISE DRIVE, SUITE 3B
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(860) 529-8882




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INTERCONNECT TYPICAL CURB CROSSING

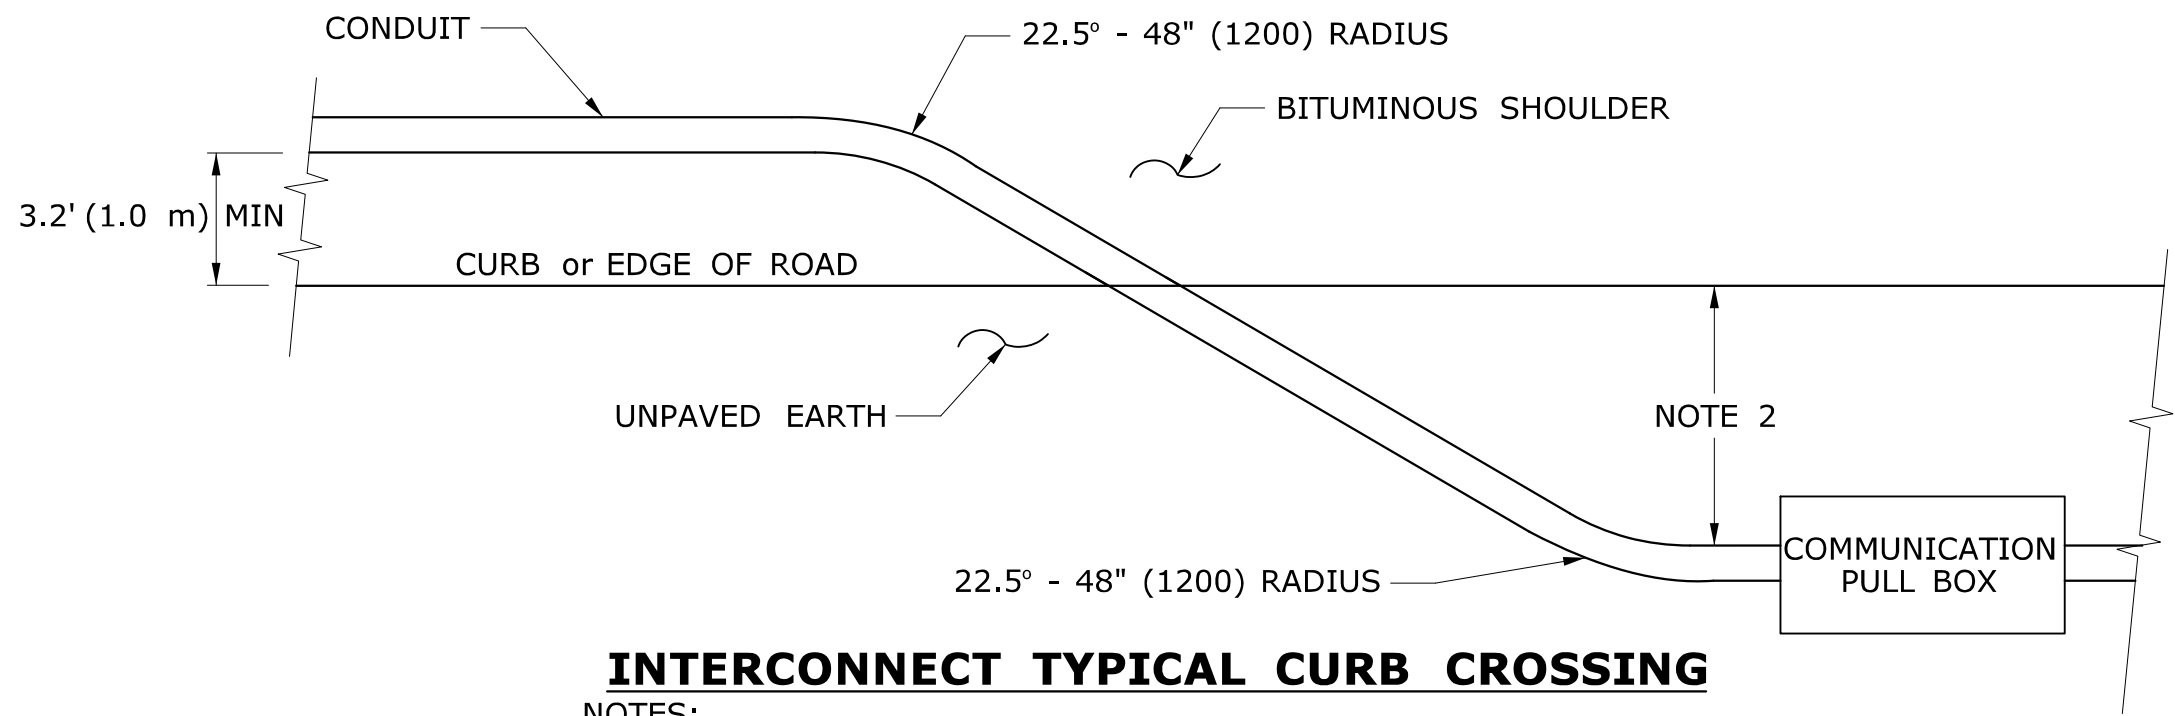NOTES:


1. RESTORE AREAS DISTURBED BY TRENCH TO ORIGINAL CONDITION.
2. INSTALL PULL BOX A MINIMUM OF 10' (3.0 m) FROM CURB UNLESS OTHERWISE SHOWN ON PLANS OR DIRECTED BY ENGINEER.



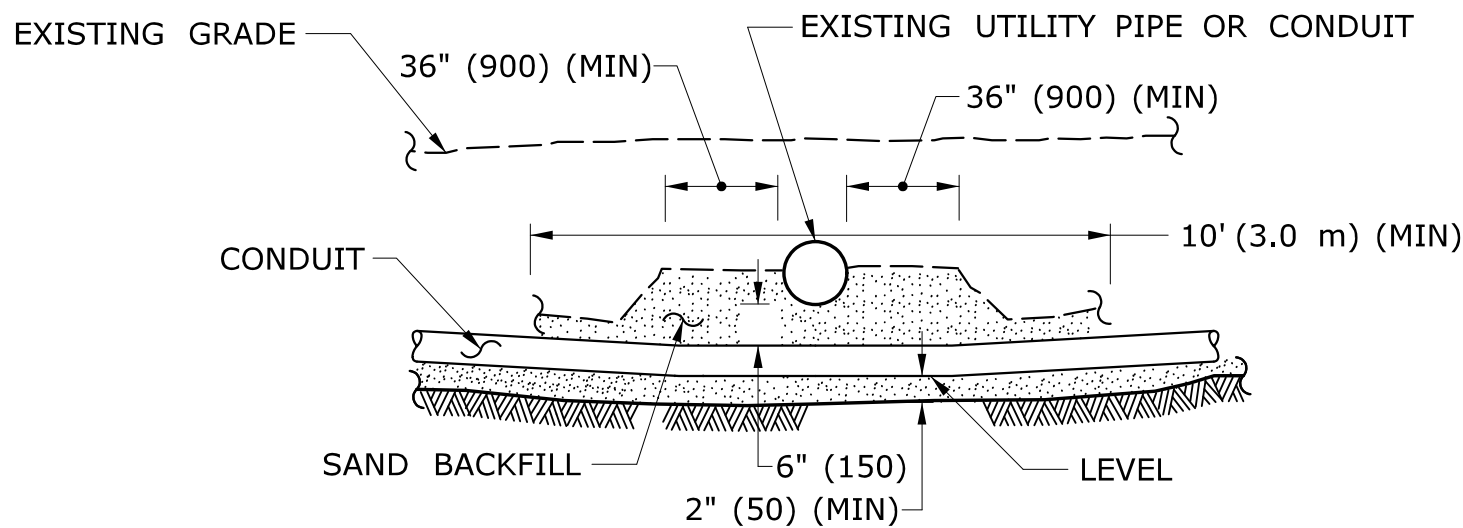CROSSING UNDER EXISTING UTILITY

NOTES:

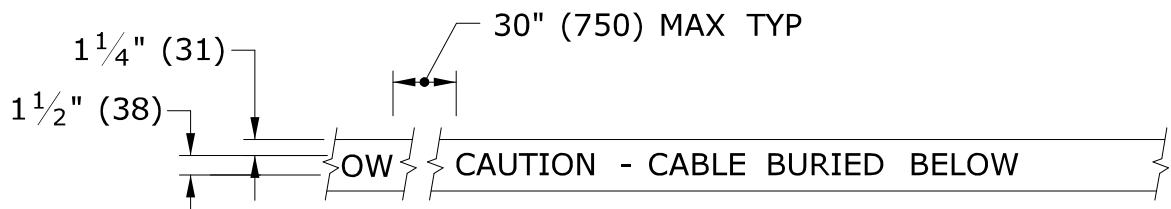1. WHEN ENCOUNTERED AT APPROXIMATELY THE SAME DEPTH, CROSS BENEATH.
2. PROTECT & SUPPORT EXPOSED EXISTING UTILITY.
3. USE SAND OR OTHER MATERIAL FOR BACKFILL AS REQUIRED BY UTILITY COMPANY.




DETECTABLE WARNING TAPE

NOTE:

STANDARD SPECIFICATIONS, ARTICLE: 1.05.15

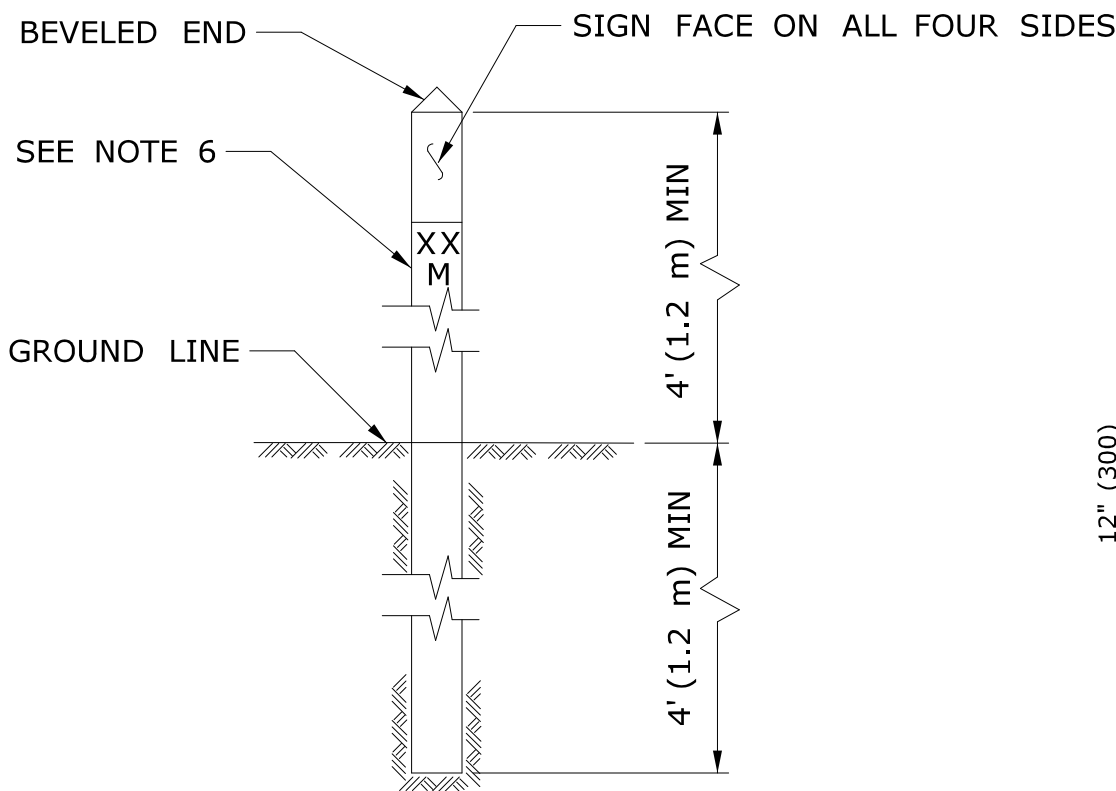1. TAPE COLORS:
COMMUNICATION - ORANGE BACKGROUND / BLACK LEGEND
POWER - RED BACKGROUND / BLACK LEGEND




INTERCONNECT CONDUIT IDENTIFICATION POST

NOTES:

1. 4" x 4" (100 x 100) NOMINAL, PRESSURE TREATED WOOD POST.
2. ATTACH SIGN TO POST WITH 1/4" x 1 1/4" (6 x 31) STAINLESS STEEL LAG SCREW WITH NYLON WASHER ON FACE OF SIGN.
3. SIGN COLORS: BACKGROUND - ORANGE (RETROREFLECTIVE) LEGEND - BLACK (OPAQUE).
4. INSTALL POST APPROX 24" (600) FROM RMC IN VICINITY OF EACH PULL BOX.
5. INSTALL POSTS BETWEEN PULL BOXES, APPROX 10' (3.0 m) OFF CURB. SPACE POSTS 1500'± (460 m±) APART.
6. PERMANENTLY ATTACH STAINLESS STEEL NUMBERS INDICATING DISTANCE TO TRENCH IN FEET (METERS) CONTAINING COMMUNICATION CABLE. ATTACH NUMBERS TO SIDE OF POST FACING CONDUIT. INCLUDE "M" SUFFIX IF METERS.

SIGN FACE DETAIL

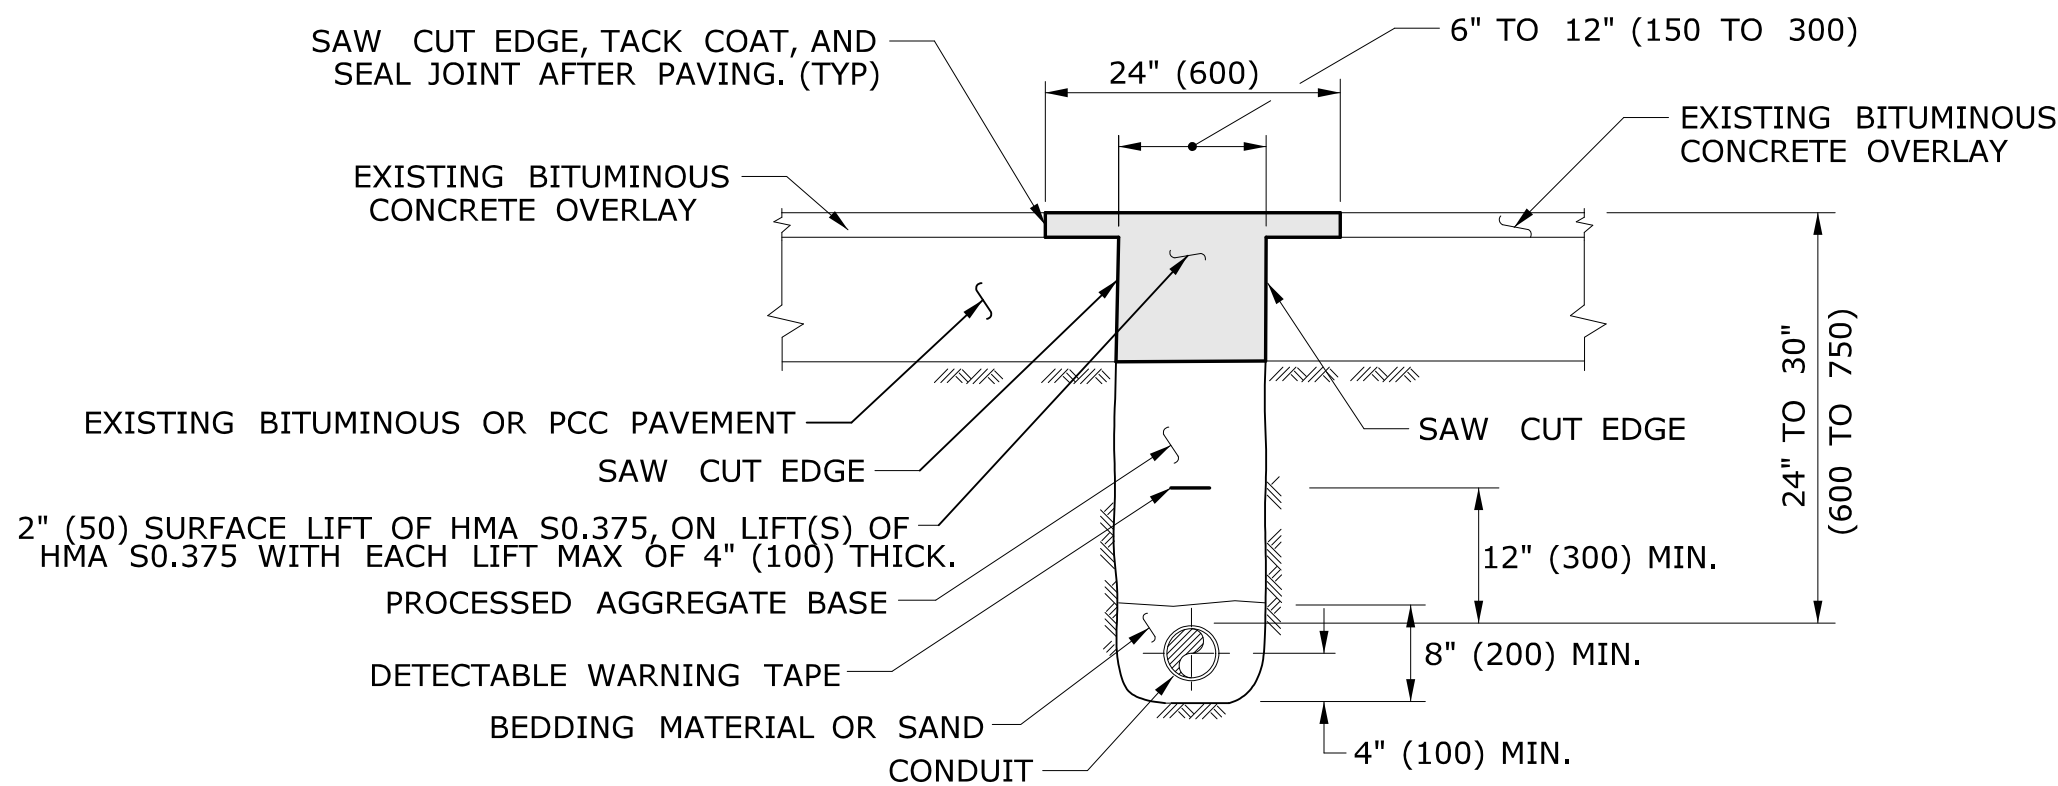SIGN # 41-4669




PAVEMENT - BITUMINOUS CONCRETE OR OVERLAYED PORTLAND CEMENT CONCRETE

NOTES:

STANDARD SPECIFICATIONS, ARTICLE: 3.04 & 4.06.03

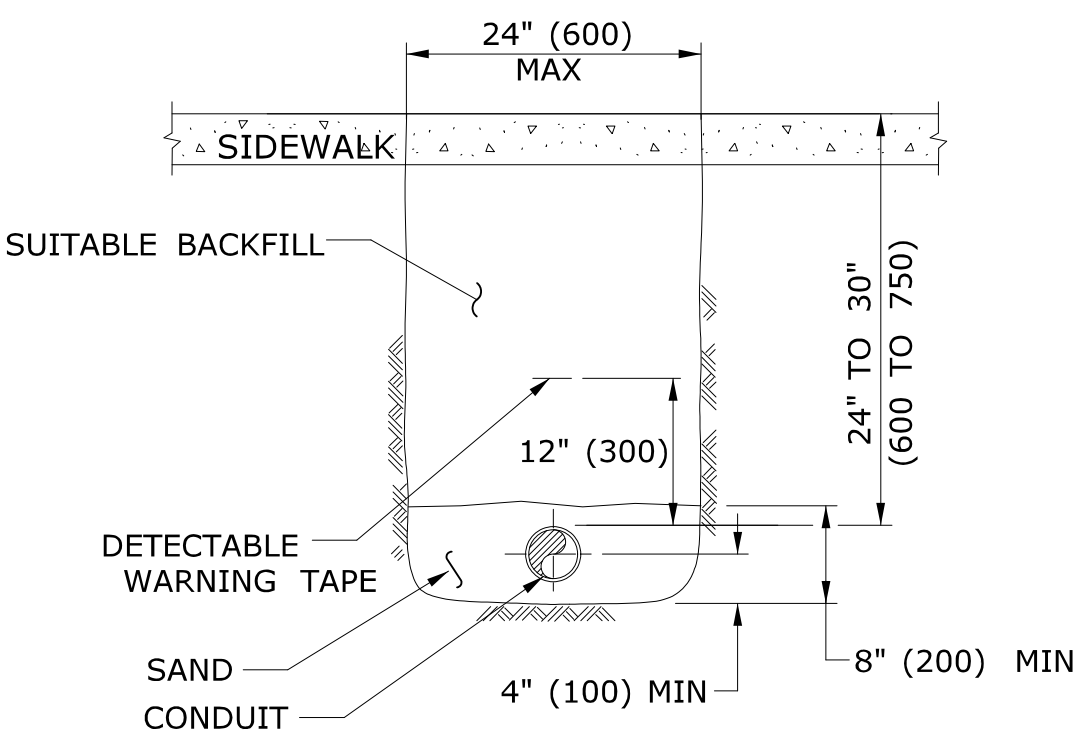1. TOTAL HOT MIX ASPHALT (HMA) THICKNESS TO MATCH EXISTING BITUMINOUS CONCRETE AND PORTLAND CEMENT CONCRETE (PCC) THICKNESS.
2. WHEN ALLOWED BY ENGINEER, USE CONTROLLED LOW STRENGTH MATERIAL (CLSM) AS BEDDING MATERIAL. TOP OF CLSM AT LEAST 20" (500) BELOW SURFACE.




SIDEWALK

NOTES:

STANDARD SPECIFICATIONS, ARTICLE: 9.21 & 9.22

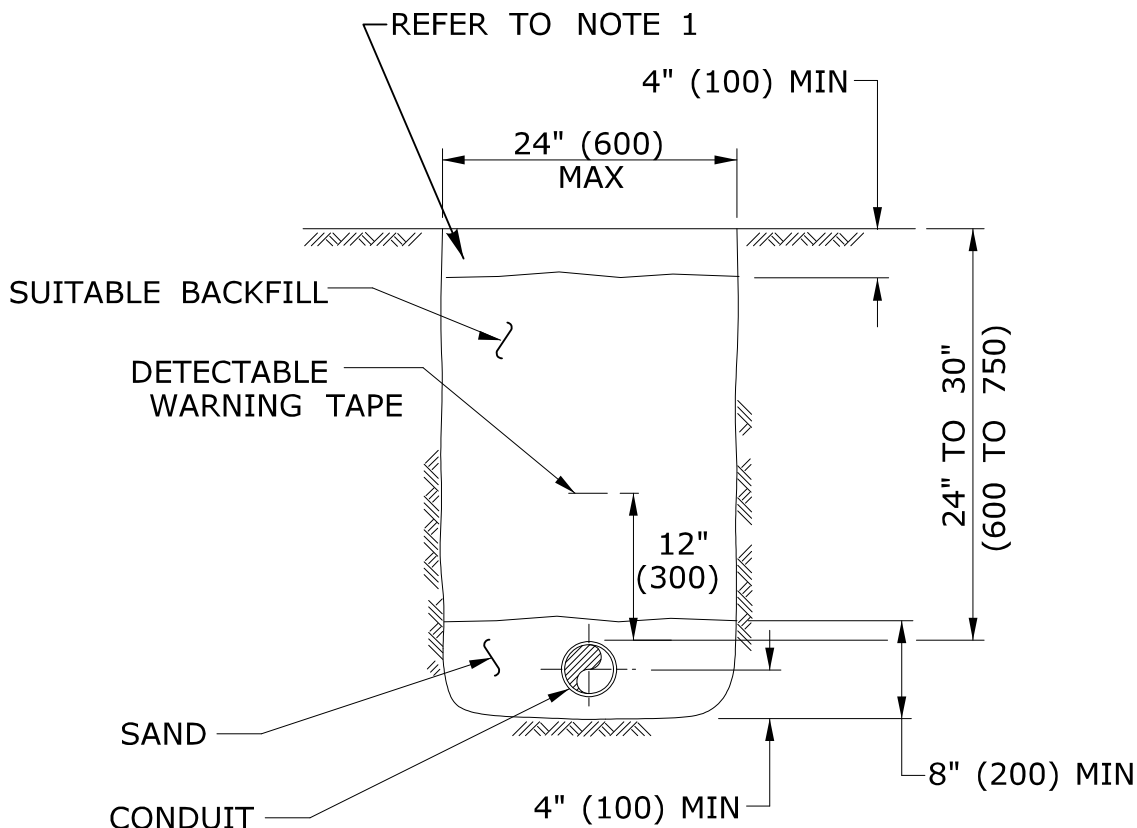1. WHERE CONCRETE SIDEWALK DAMAGED OR CUT, REPLACE THE ENTIRE SECTION BETWEEN JOINTS. REPLACEMENT SIDEWALK IS PAID FOR AT THE CONTRACT UNIT PRICE FOR "CONCRETE SIDEWALK".



EARTH

NOTES:

STANDARD SPECIFICATIONS, ARTICLE: 9.50

1. IN MOWED AREAS: PLACE TOPSOIL, FERTILIZER, SEED, & MULCH.

GENERAL NOTES:

1. TOP OF CONDUIT NO LESS THAN 24" (600) DEEP.
2. COMPACT BACKFILL IN ≤ 6" (150) LIFTS. HAND COMPACTION NOT PERMITTED.

LEGEND AS SHOWN ON TRAFFIC CONTROL SIGNAL PLAN:
--- RMC (RIGID METAL CONDUIT)

TOWN OF BROOKFIELD, CT

PROJECT NAME: **TOWN DISTRICT SIDEWALK AND ACCESS MANAGEMENT PLAN**

SHEET TITLE: TRENCHING & BACKFILLING ELECTRICAL CONDUIT

FILE NAME:

PLOT DATE: 4/20/2016

DRAWING NO.:

MDS-04

PROJECT LEADER: SM

DRAWN BY: AG

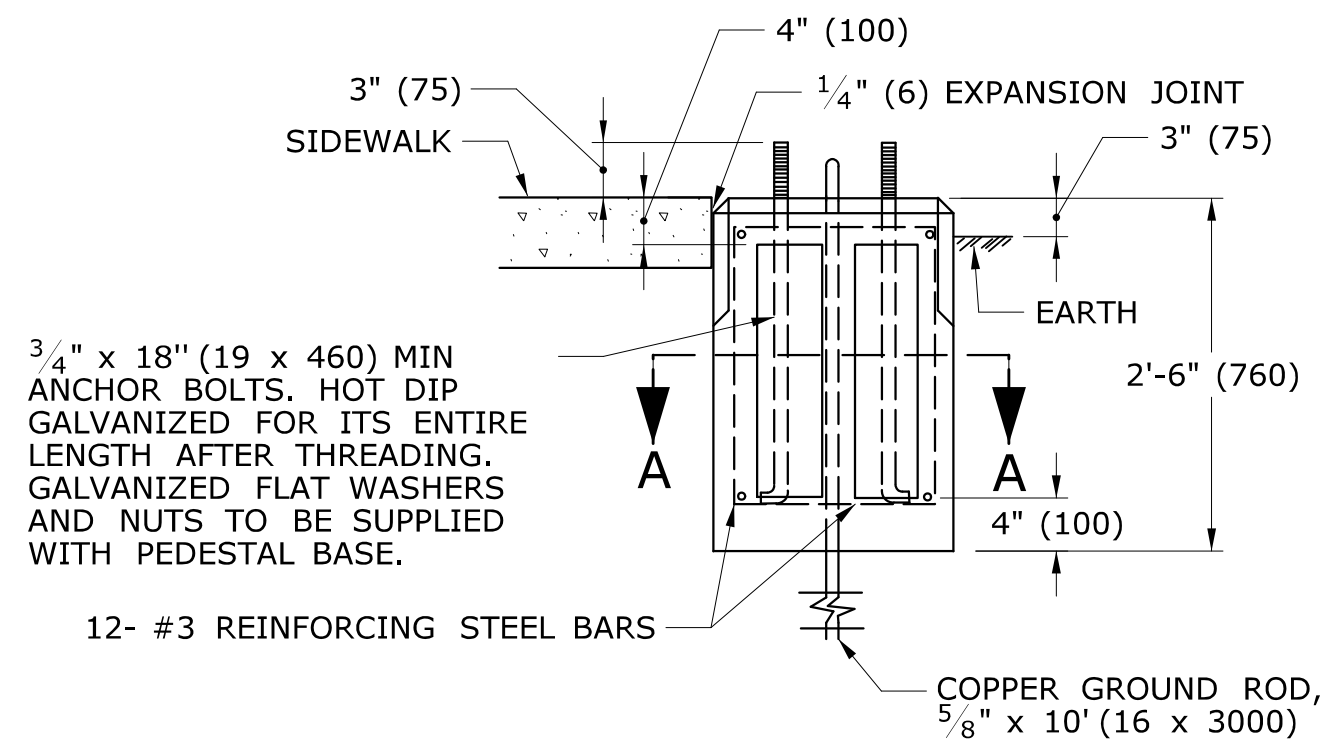
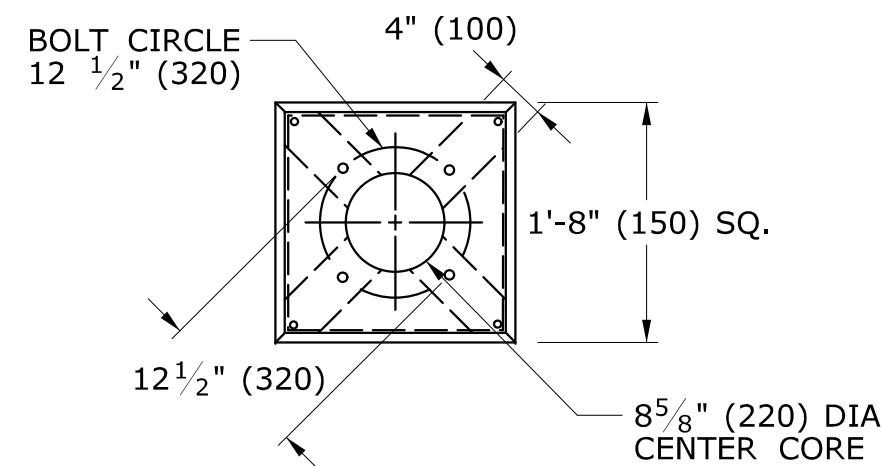
SHEET NO.:

10

DESIGNED BY: AG

CHECKED BY: PG


URS CORPORATION
500 ENTERPRISE DRIVE, SUITE 3B
ROCKY HILL, CT 06067
(860) 529-8882



TRAFFIC CONTROL FOUNDATION
PEDESTAL - TYPE I - PRECAST

NOTES:

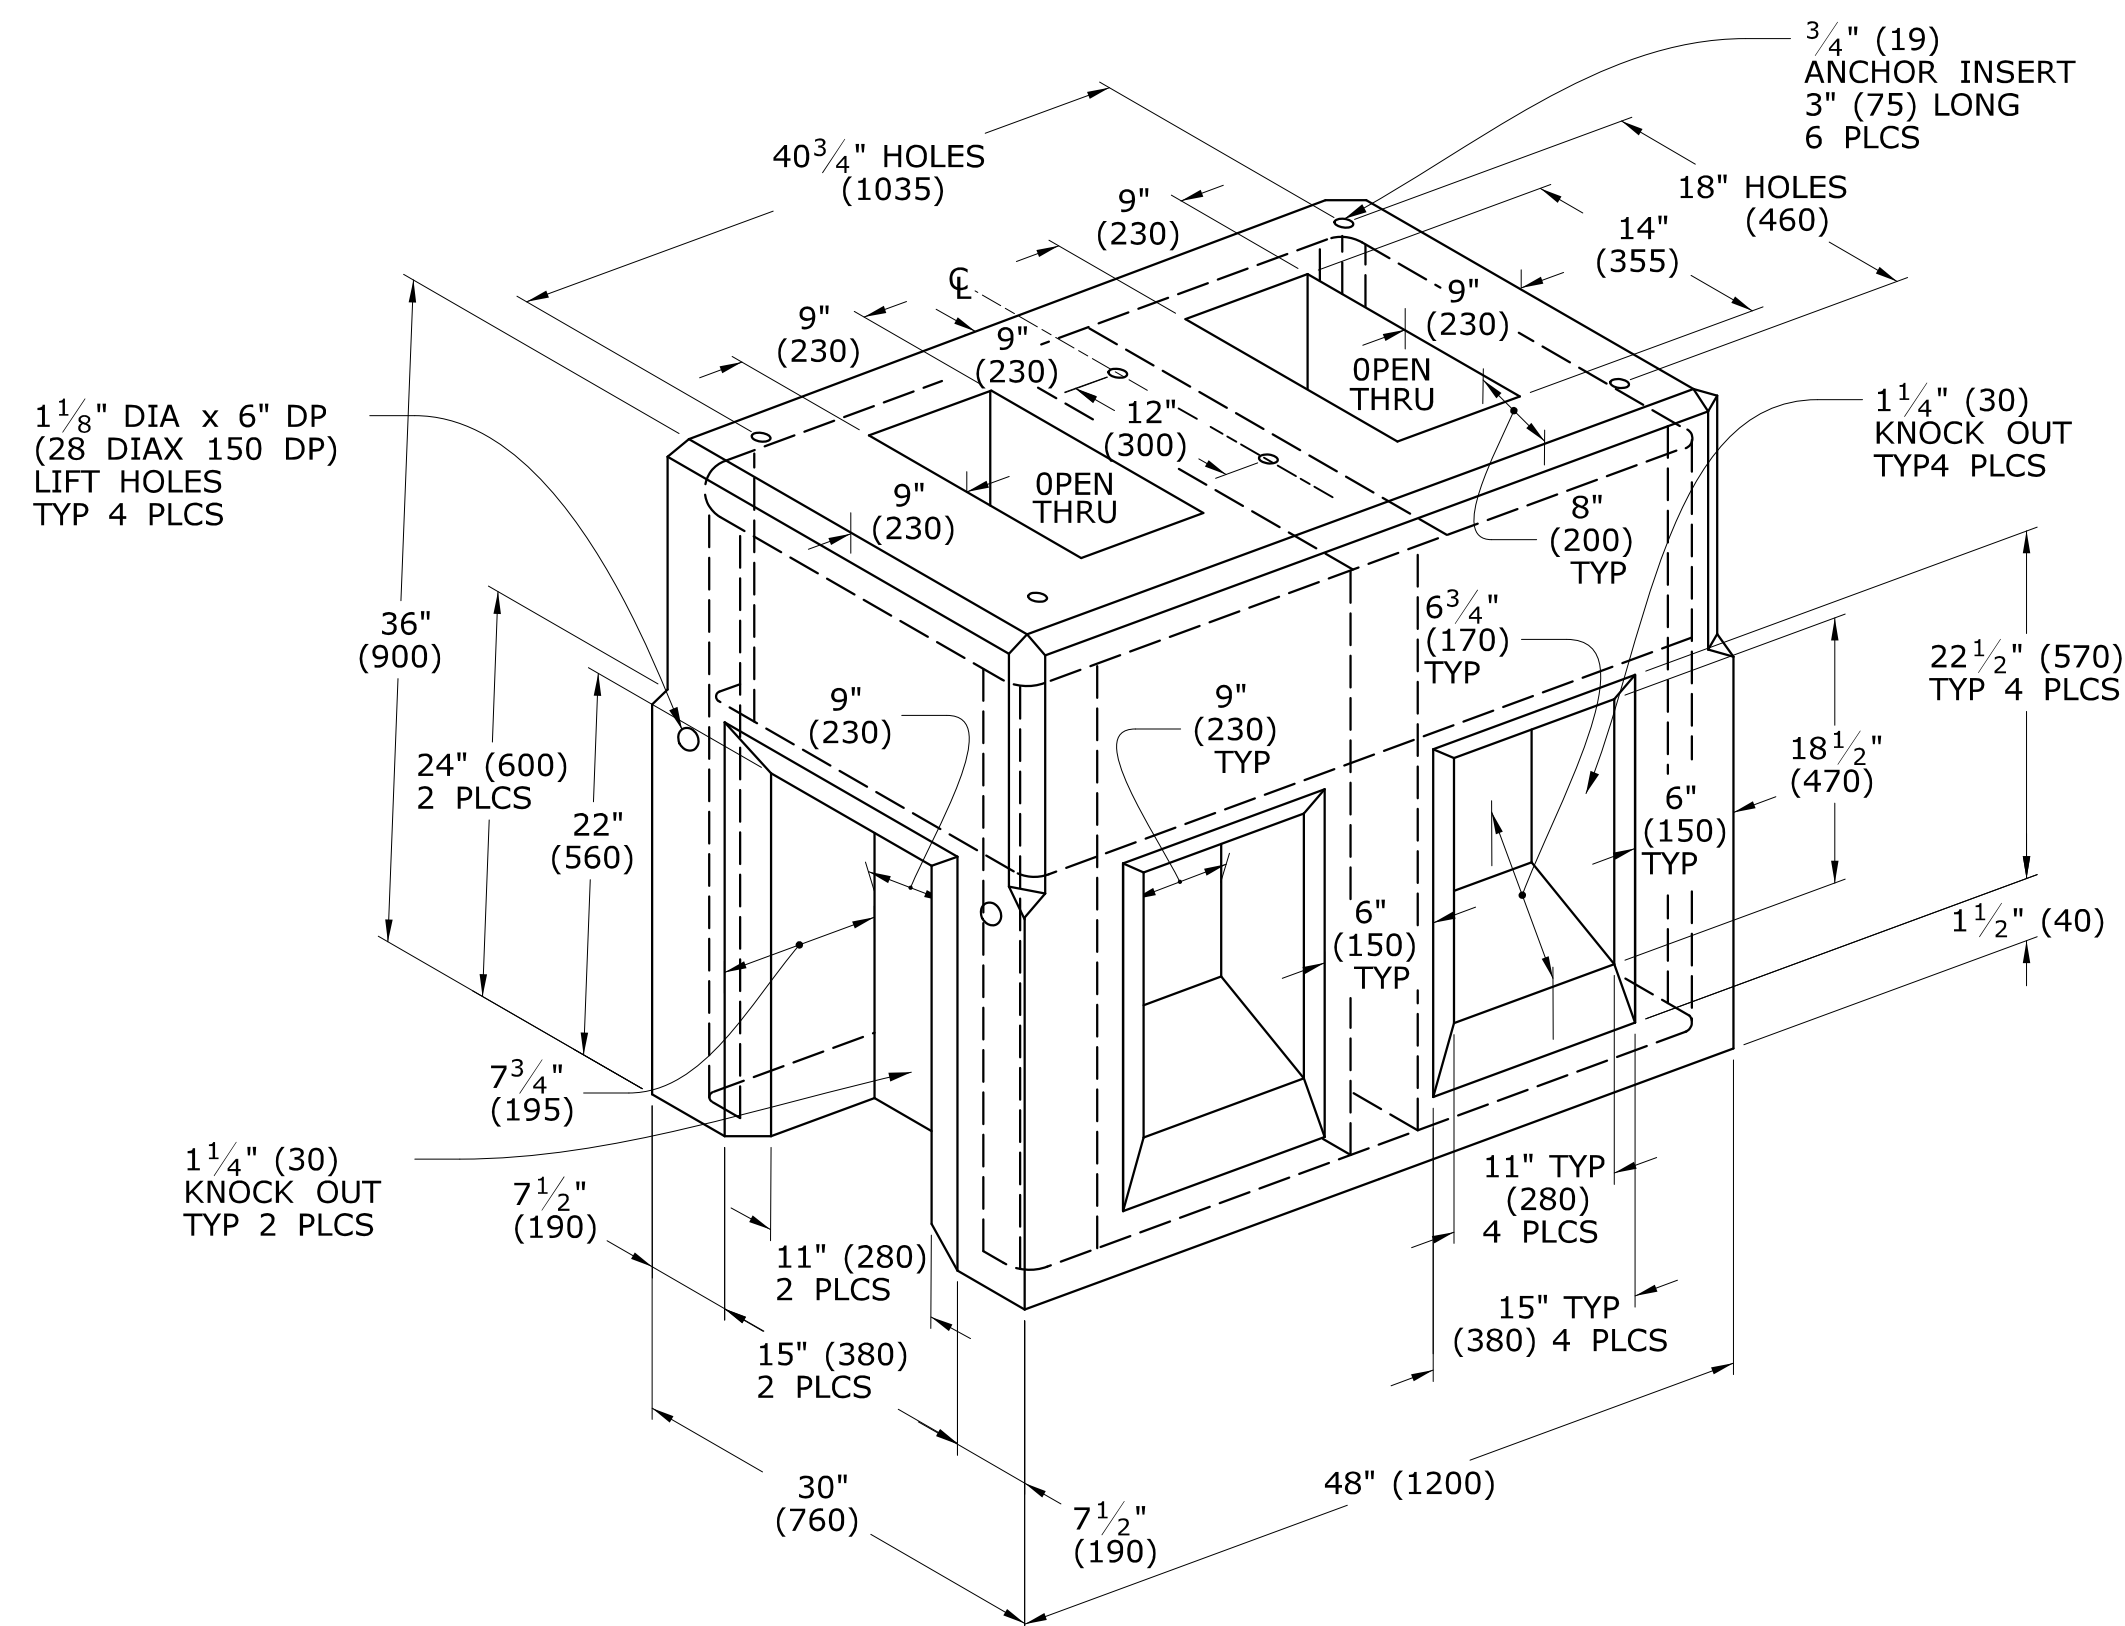
PLACE NO. 6 CRUSHED STONE IN CENTER OPENING AFTER
CONDUITS AND GROUND ROD HAVE BEEN INSTALLED.



TRAFFIC CONTROL FOUNDATION
CONTROLLER - TYPE IV - PRECAST

NOTES:

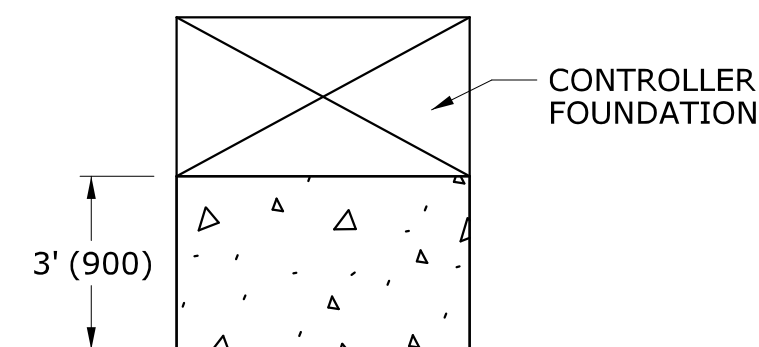INSTALL FOUNDATION ON 6" (150) OF COMPACTED GRAVEL IN ACCORDANCE WITH SECTION 2.14.
LEVEL FOUNDATION WITH A PROJECTION OF 4" (100) ABOVE FINISHED GRADE.
INSTALL COPPER GROUND ROD; $\frac{5}{8}$ " x 10 (16 x 3000).
PLACE NO. 6 CRUSHED STONE IN THE CENTER OPENINGS AFTER THE CONDUITS AND GROUND ROD
HAVE BEEN INSTALLED. THE OPENINGS SHALL BE CAPPED WITH A 2" (50) GROUT LEVEL WITH THE
TOP OF THE FOUNDATION AND NEATLY FINISHED. THE GROUT SHALL CONFORM WITH THE
REQUIREMENTS OF ARTICLE M.3.01-12.
CONCRETE: CLASS "A" CONFORMING TO ARTICLE M.03.01.
#4 REBAR 2" (50) MIN COVER AROUND ALL OPENINGS, 3-#4 REBARS IN EACH CORNER.
CONDUITS SHALL NOT PROJECT MORE THAN 2" (50) ABOVE FOUNDATION.





INSTALL PRECAST OR CAST IN PLACE CONCRETE SIDEWALK ON CABINET
DOOR SIDE OF CONTROLLER FOUNDATION.

PITCH SIDEWALK $\frac{1}{4}$ " PER FOOT (20 PER METER) AWAY FROM THE
CONTROLLER FOUNDATION.

REFER TO HIGHWAY STANDARD SHEET HW-921-01 FOR SIDEWALK CONSTRUCTION.

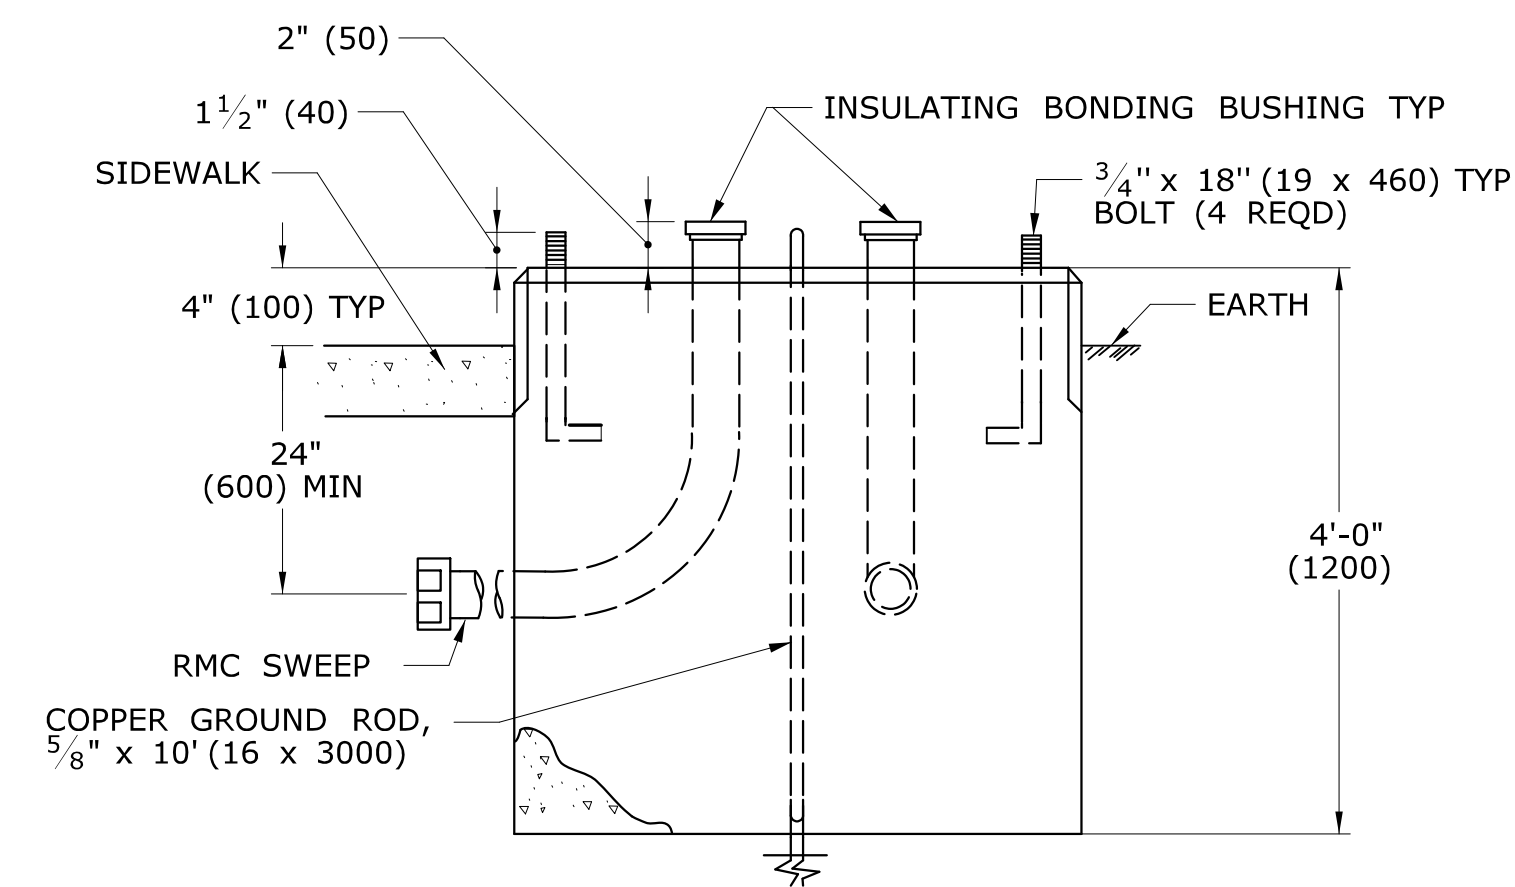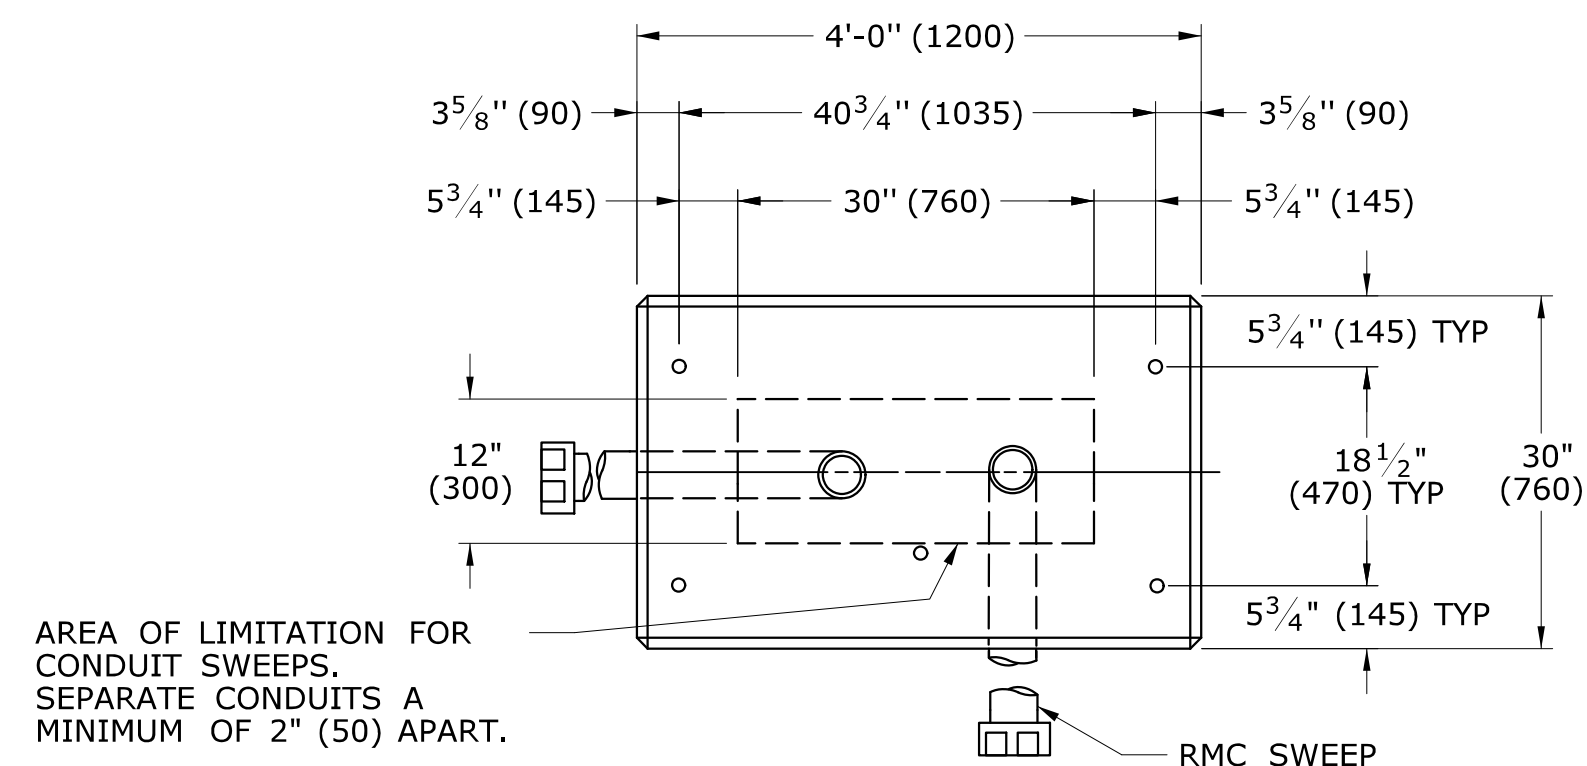TYPICAL CONCRETE SIDEWALK AT CONTROLLER FOUNDATION



TRAFFIC CONTROL FOUNDATION
CONTROLLER - TYPE IV - CAST IN PLACE

LEGEND AS SHOWN ON TRAFFIC CONTROL SIGNAL PLAN:

	PROPOSED CONTROLLER
	EXISTING CONTROLLER
	PROPOSED STEEL SPAN POLE
	EXISTING STEEL SPAN POLE

PROJECT NAME: **TOWN DISTRICT SIDEWALK AND ACCESS
MANAGEMENT PLAN**

SHEET TITLE: TRAFFIC CONTROL FOUNDATIONS

FILE NAME:

PROJECT LEADER: SM

DESIGNED BY: AG

PLOT DATE: 4/20/20
DRAWN BY: AG
CHECKED BY: PG

DRAWING NO.:	MDS-05
SHEET NO.:	1

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-

30" (750) SQ

23 1/2" (585) SQ

RECESS

20" (500) SQ

TRAFFIC

TRAFFIC

RMC SWEEP

REINFORCING BARS


THREADED CONCRETE INSERT 21 1/2" (545) O.C.

3 1/4" (80)

Diagram illustrating the cross-section of a handhole assembly, showing various components and dimensions:


- INSERT, SEE DETAIL**: Points to the top edge of the concrete structure.
- 1/2" (13) RECESS FOR HANDHOLE COVER**: Dimension for the recess at the top.
- INSULATING BONDING BUSHING**: Component used for sealing the handhole opening.
- 1 1/2" (38)**: Dimension for the thickness of the insulating bonding bushing.
- EARTH**: Label for the ground level.
- 24" (600) MIN.**: Minimum depth dimension for the insulating bonding bushing.
- 26" (650) MIN.**: Minimum total depth dimension for the handhole assembly.
- 5" (125)**: Dimension for the thickness of the concrete structure.
- 3" (75) TYP.**: Typical dimension for the concrete structure.
- 12" (300)**: Dimension for the height of the concrete structure.
- 12" (300) (TYP ALL HANDHOLES)**: Typical dimension for all handholes.
- 3/4" (19) CRUSHED STONE (TYP ALL HANDHOLES)**: Material used for the base of the handhole.
- REINFORCING BARS**: Labels for the bars within the concrete structure.
- 3/4" (19) CHAMFER**: Dimension for the chamfer on the concrete structure.
- SIDEWALK**: Label for the area adjacent to the handhole.
- UNED DRAIN WHERE D FOR ON PLAN OR TED BY ENGINEER.**: Label for the drainage system.

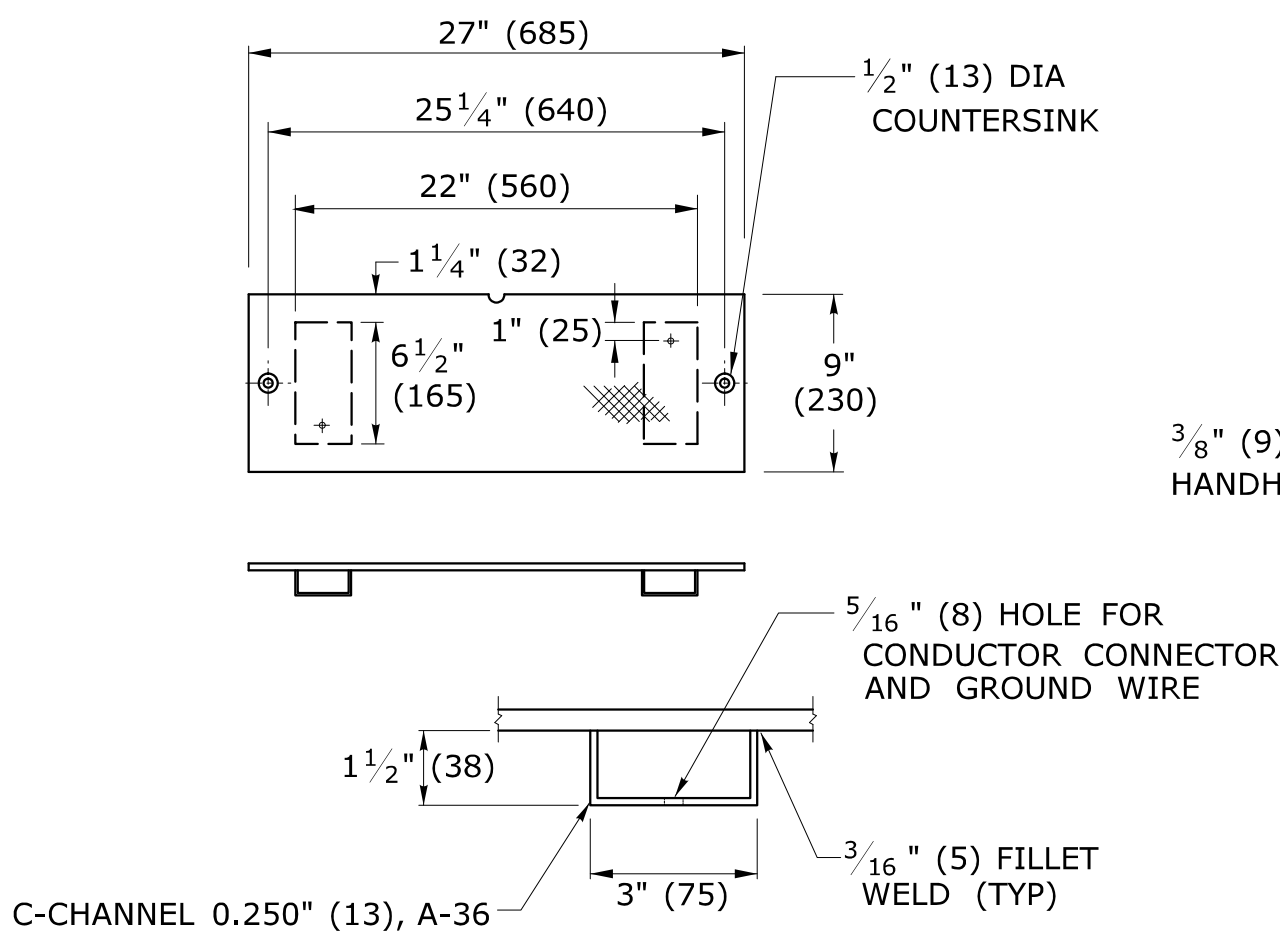1. MINIMUM CLASS "C" CONCRETE.
2. COMPLETE TYPE II HANDHOLE:
IN EARTH AREAS, CONSISTS OF A BASE SECTION WITH 4" (100) HANDHOLE EXTENSION,
IN SIDEWALK AREAS, CONSISTS OF A BASE SECTION WITH 4" (100) CAST IRON COVER.
3. PLAN VIEW DIMENSIONS, SECTION VIEW, & DETAILS, SAME FOR BASE SECTION,
EXTENSIONS & BANK ADAPTER.
4. GROUT AROUND ALL CONDUITS.



30"
(760 SQ.)

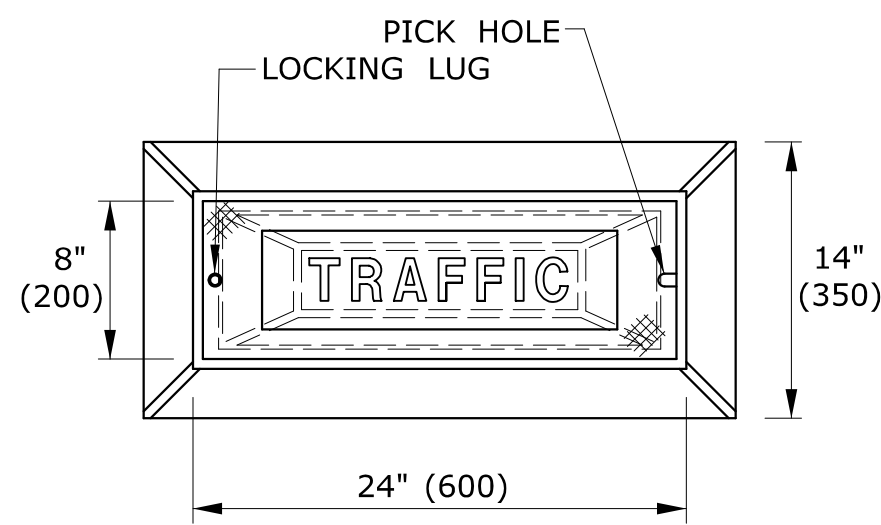TRAFFIC

[illegible]

4" (100)
STANDARD,
6" (150) OR
12" (300)

TONGUE TO MATCH
HANDHOLE COVER

3 1/8" (9)

CONCRETE INSERTS

TOP VIEW

12" (300)

4" (100)

3 1/2" (90)

3/8" (9) TO FIT INTO HANDHOLE COVER OPENING

#3 REINFORCING BARS

[illegible]

The diagram illustrates a cross-section of a handhole extension. Key dimensions and components include:

- Overall Length:** 23 1/2" (595)
- Extension Length:** 3 1/4" (85) TYP.
- Top Width:** 1 3/8" (35)
- Top Flange Width:** 1 1/2" (38)
- Bottom Width:** 1 1/2" (38)
- Internal Spacing:** 1/2" (13)
- Bottom Flange Width:** 3/8" (9) TO FIT INTO HANDHOLE
- Labels:** EARTH, ADJACENT SIDEWALK, and **HANDHOLE EXTENSION**.

1" (25)

13/8" (35)

23 1/2" (595)

3 1/4" (85) TYP

1/2" (13)

12" (300) TYP

14" (350) TYP

KNOCK-OUT, TYP SIDES & ENDS

1" (25)± TYP

6" (150) TYP

8" (200) TYP

24" (600)

3" (75) TYP

3" (75) TYP

8" (200)

3/4" (19) HOLES FOR LIFTING & FOR J-HOOK

1 1/2" (38) TYP

REINFORCING BARS

2" (50)

7 1/2" (190)

24" (600)

7" (175)

Diagram illustrating the dimensions for a cleanout beneath an insert:

- Top width of insert: $1\frac{3}{4}"$ (45)
- Distance from center of insert to right edge of pipe: $\frac{3}{4}"$ (19)
- Height of insert: $1\frac{1}{2}"$ (38)
- Total width of pipe: $1"$ (25)
- Area below insert: CLEANOUT BENEATH INSERT

1 1/2" (38)

8" (200)

1/2" (13) INSERT WITH "J" HOOK

TYP IN TWO PLACES FOR
ALL HANDHOLES

TOWN OF BROOKFIELD, CT			
URS CORPORATION 500 ENTERPRISE DRIVE, SUITE 3B ROCKY HILL, CT 06067 (860) 529-8882	PROJECT NAME: TOWN DISTRICT SIDEWALK AND ACCESS MANAGEMENT PLAN		
	SHEET TITLE: HANDHOLE DETAIL		
	FILE NAME:	PLOT DATE:4/20/2016	DRAWING NO.: MDS-06
	PROJECT LEADER: SM DESIGNED BY: AG	DRAWN BY: AG CHECKED BY: PG	SHEET NO.: 12

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1 1/2" (38) SSIDE
OUTLET TEE, IRON, TYP

1 1/2" (38) NIPPLE, STEEL, TYP

SERRATED ELL, IRON, TYP

B TYP

POST TOP MOUNTED
ADAPTER WITH TERMINAL
COMPARTMENT, IRON

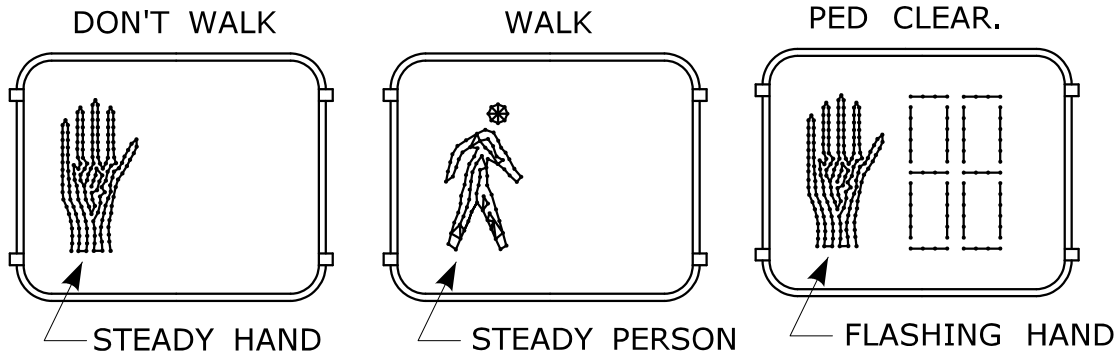
POST TOP MOUNTED
ADAPTER WITH TERMINAL
COMPARTMENT, IRON

POST TOP MOUNTED
ADAPTER, IRON

FILL TOP OF PEDESTAL WITH
EXPANSION AEROSOL FOAM
AFTER WIRES HAVE BEEN
INSTALLED.



POST TOP MOUNTED
ADAPTER, IRON

NOTE:
PEDESTAL MOUNTED ONE WAY VEHICLE
SIGNAL SHALL BE MOUNTED SAME AS
ONE WAY WALK SIGNAL.




TYPICAL INDICATION WHEN LIT

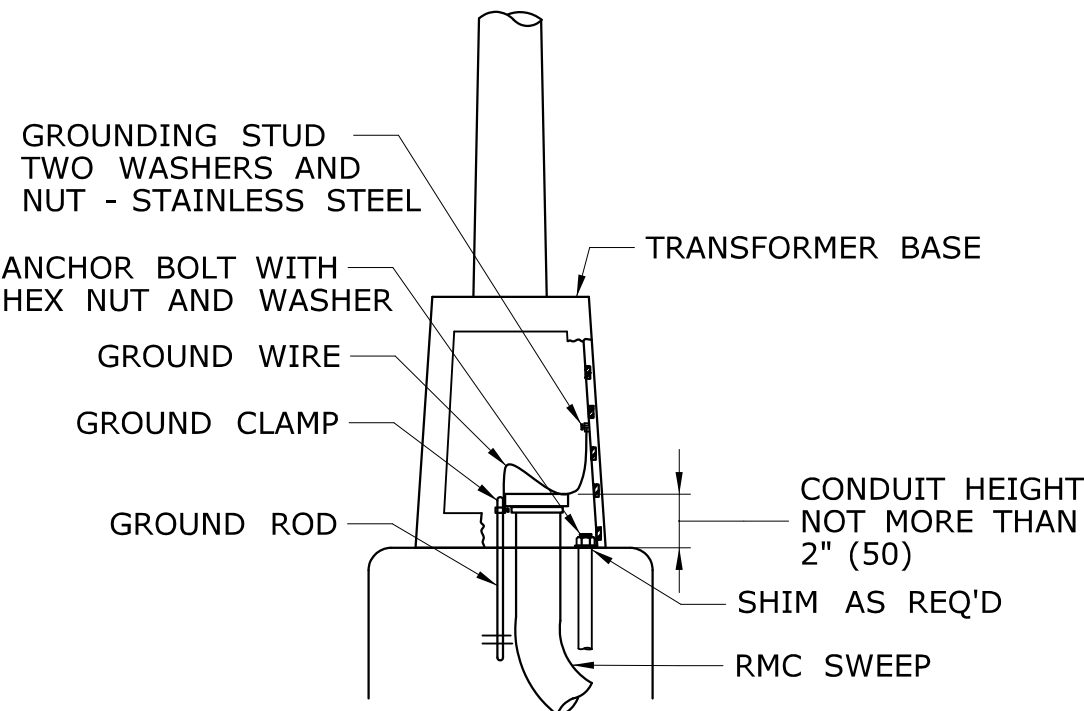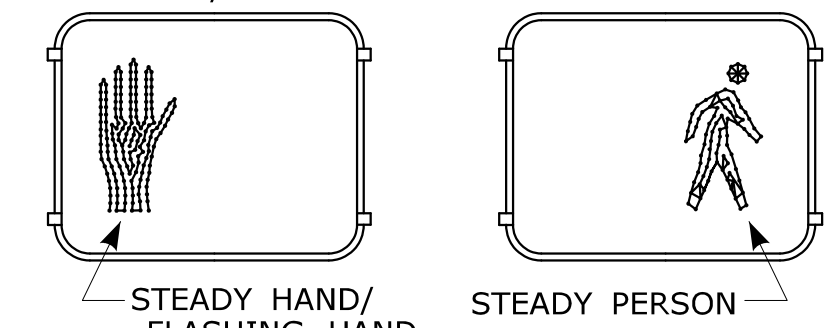NON-COUNTDOWN DISPLAY, ONLY WHEN SHOWN ON PLAN.
DON'T WALK/PED CLEAR.




ALUMINUM PEDESTAL INSTALLATION DETAIL

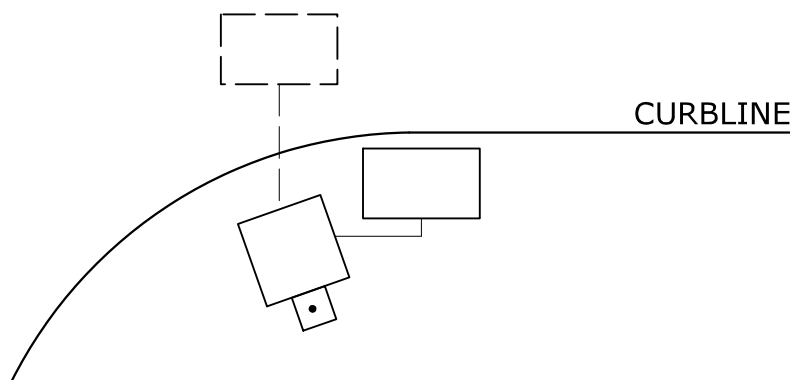

WHEN PEDESTALS OR SPAN POLES ARE INSTALLED CLOSE TO THE CURB,
SIDE MOUNT PEDESTRIAN OR TRAFFIC SIGNALS TO AVOID VISOR DAMAGE
FROM TURNING VEHICLES.


ONE WAY TRAFFIC SIGNAL PEDESTAL MOUNTED

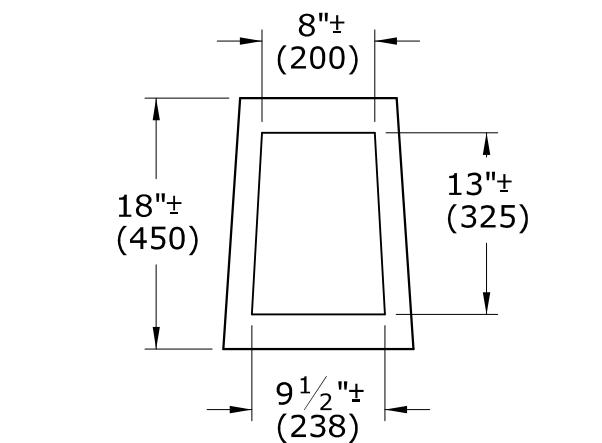ONE WAY WALK SIGNAL PEDESTAL MOUNTED



ALUMINUM PEDESTAL DOOR OPENING DETAIL

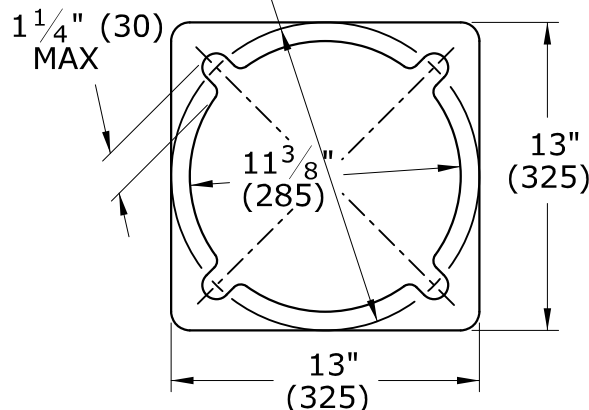BOLT CIRCLE
11 1/2" - 12 3/4" (288 - 319)



PEDESTAL BASE PLAN

NOTES:

- A SECURE LOWER HUB PLATE WITH STAINLESS STEEL SET SCREW OR PIN PRIOR TO BANDING TO PREVENT MOVEMENT. INSTALL CABLE THROUGH BOTTOM OF HUB PLATE.
- B REFER TO CTDOT TRAFFIC STANDARD SHEET, TR-1105-01, TRAFFIC SIGNALS & CABLE ASSIGNMENTS.
- C IF THREADED, MIN 1" (25) THREADED INTO BASE, SECURED WITH STAINLESS STEEL SET SCREWS.
- D BASE DESIGNED AS BREAK-AWAY.

INCANDESCENT WALK SIGNAL LAMPS ARE 67 WATTS, RATED AT 8000 HOURS LAMP LIFE.
LED WALK SIGNAL LAMPS ARE MAXIMUM 15 WATTS, WARRANTEED AT 5 YEAR LIFE.

ONE WAY TRAFFIC SIGNAL POLE MOUNTED

TOWN OF BROOKFIELD, CT

PROJECT NAME: **TOWN DISTRICT SIDEWALK AND ACCESS
MANAGEMENT PLAN**

SHEET TITLE: PEDESTRIANS, PEDESTRIAN SIGNALS

FILE NAME:
PROJECT LEADER: SM
DESIGNED BY: AG

PLOT DATE: 4/20/2016
DRAWN BY: AG
CHECKED BY: PG

DRAWING NO.:

MDS-07


SHEET NO.:

13

LEGEND AS SHOWN ON TRAFFIC CONTROL SIGNAL PLAN:

- STEEL SPAN POLE, MAST ARM ASSEMBLY SHAFT
- ALUMINUM PEDESTAL
- TRAFFIC SIGNAL
- PEDESTRIAN SIGNAL
- PEDESTAL MOUNTED, TRAFFIC & PEDESTRIAN SIGNALS
- POLE MOUNTED, TRAFFIC & PEDESTRIAN SIGNALS

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WHEN SHOWN ON PLANS
INSTALL STAND-OFFS IN
ACCORDANCE WITH PURA
STANDARDS. MINIMUM 3.
LOWEST STAND-OFF NOT
LOWER THAN 7' (2100)
ABOVE GROUND

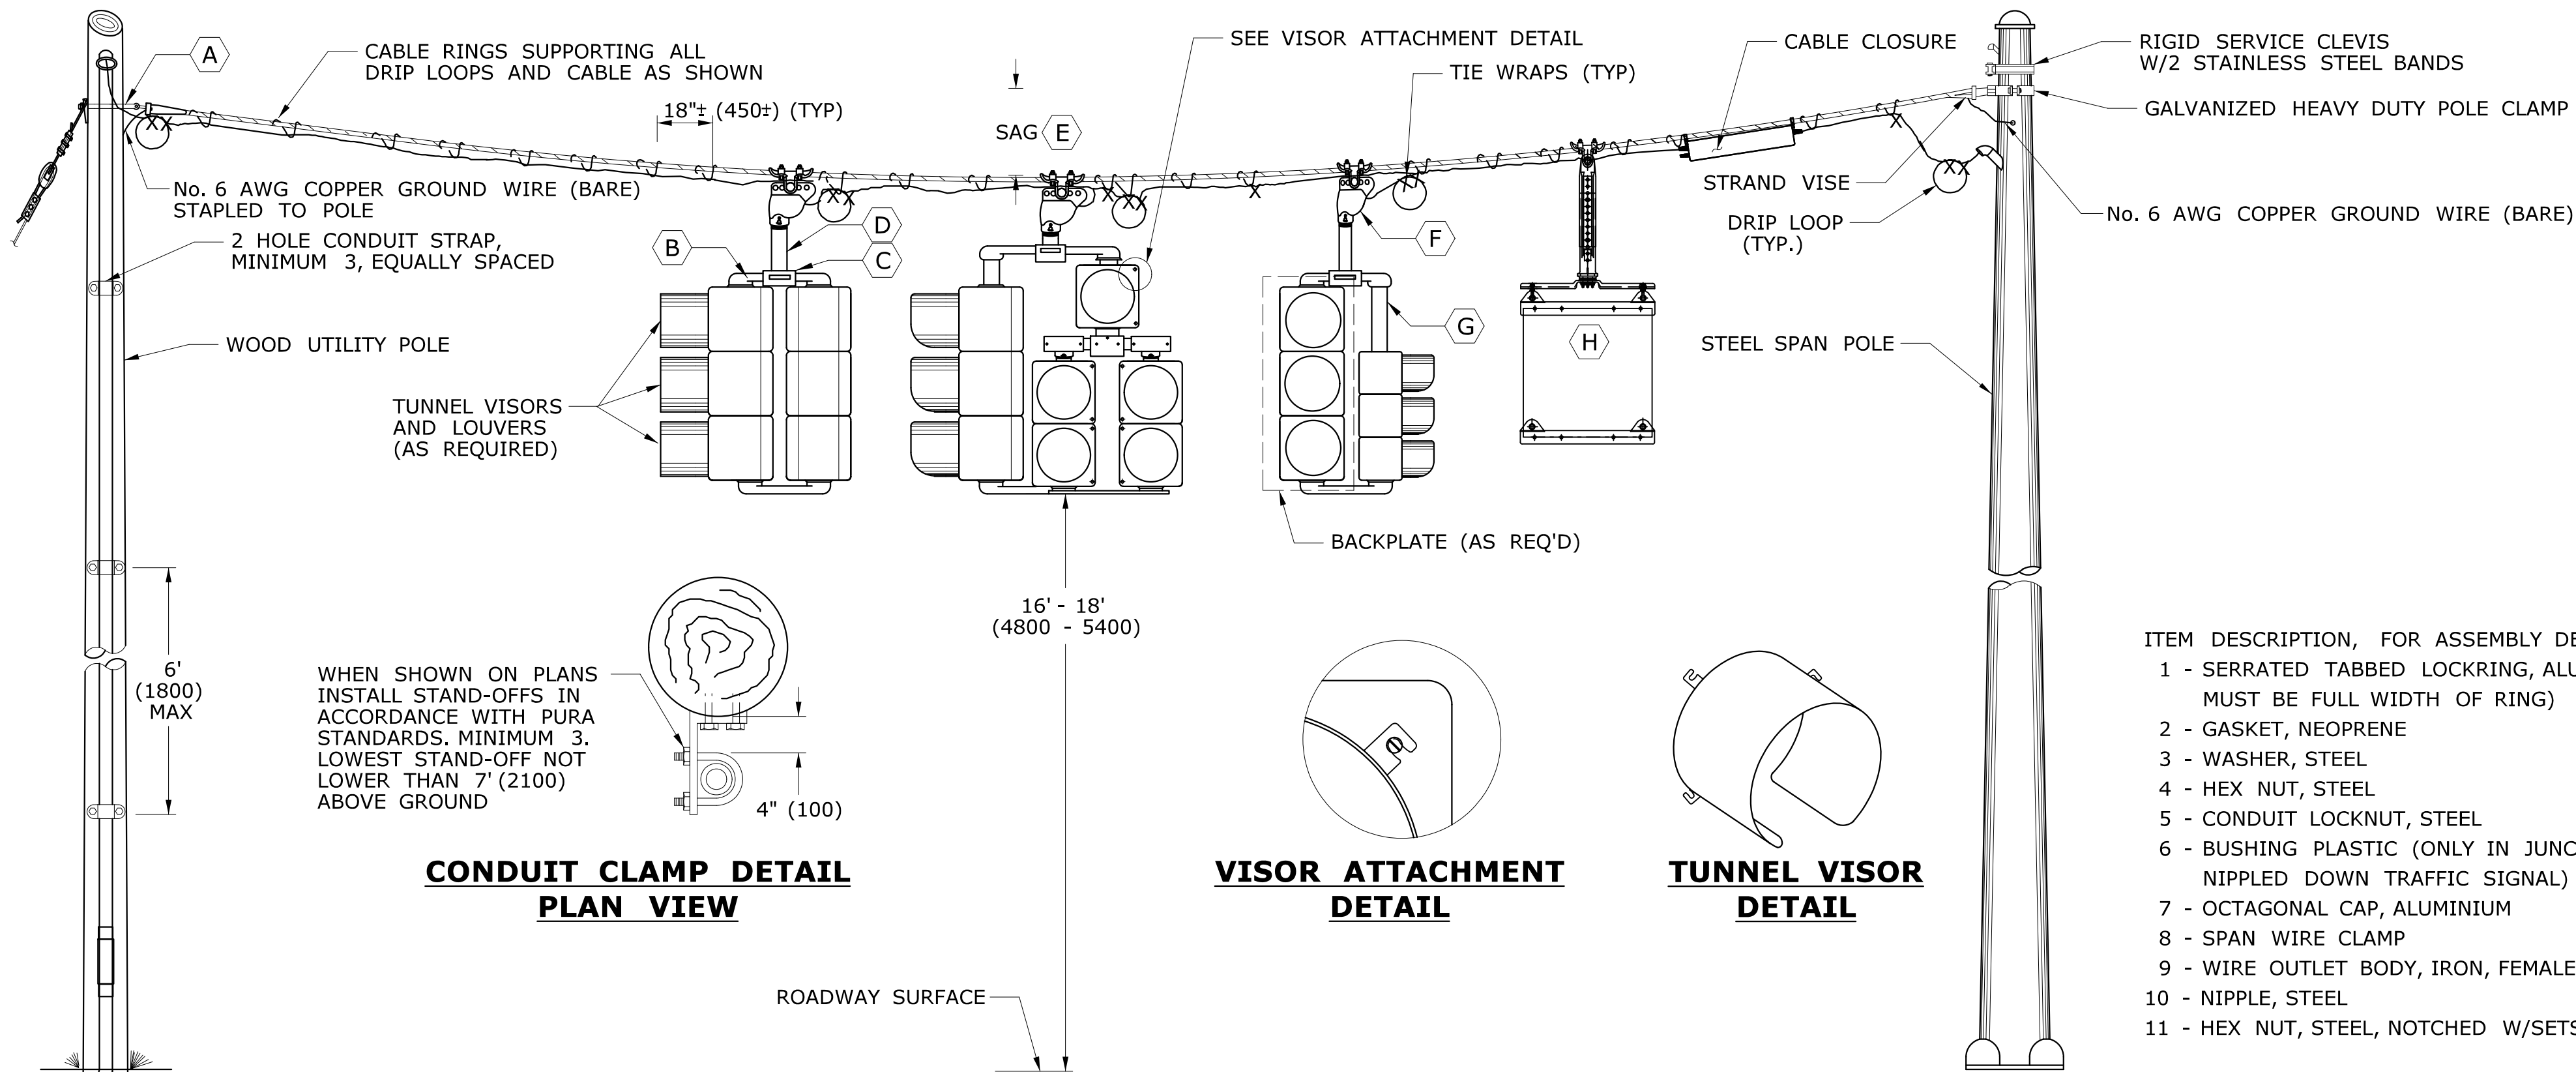**CONDUIT CLAMP DETAIL
PLAN VIEW**

**VISOR ATTACHMENT
DETAIL**

**TUNNEL VISOR
DETAIL**

**TRAFFIC SIGNALS
SPAN WIRE SUSPENDED**

**SPAN WIRE HANGER
ASSEMBLY DETAIL**

**TWO WAY, THREE WAY
& FOUR WAY NIPPLE DOWN
ASSEMBLY DETAIL**

**UPPER CENTER
SUPPORT DETAIL**

DIRECT ASSEMBLY DETAIL

**3 BOLT
BRACKET ASSEMBLY**

- ITEM DESCRIPTION, FOR ASSEMBLY DETAILS
- 1 - SERRATED TABBED LOCKRING, ALUMINUM (TAB MUST BE FULL WIDTH OF RING)
 - 2 - GASKET, NEOPRENE
 - 3 - WASHER, STEEL
 - 4 - HEX NUT, STEEL
 - 5 - CONDUIT LOCKNUT, STEEL
 - 6 - BUSHING PLASTIC (ONLY IN JUNCTION BOX OR NIPPLED DOWN TRAFFIC SIGNAL)
 - 7 - OCTAGONAL CAP, ALUMINIUM
 - 8 - SPAN WIRE CLAMP
 - 9 - WIRE OUTLET BODY, IRON, FEMALE ONLY
 - 10 - NIPPLE, STEEL
 - 11 - HEX NUT, STEEL, NOTCHED W/SETSCREWS

- NOTES: FOR ASSEMBLY DETAILS
- (J) APPLY SILICONE CAULK BETWEEN OR AROUND SERRATED LOCKRING AND HOUSING.
 - (K) OPTIONAL USE IF NIPPLE THREADS TOO FAR INTO ELBOW.
 - (L) DRILL HOLE IN CENTER OF 2 WAY BOTTOM BRACKET - INSTALL 3 BOLT BRACKET (SEE DETAIL).
 - (M) DO NOT INSERT ORNAMENTAL CAP PAST DOTTED LINE.
 - (N) ALL THREAD.
 - (P) SETSCREW (SQUARE OR ALLEN) ON ALL FITTINGS.
 - (R) CHASE NIPPLE CAN BE SUBSTITUTED FOR THE COMBINATION OF ITEMS 6, 5 AND 10.
 - (S) INSTALL STAINLESS STEEL WASHER ON INSIDE OF COTTER PIN. COTTER PIN AND WASHER SHALL BE ON SIDE OF HANGER AWAY FROM SIGNAL CABLES.
 - (T) CHASE NIPPLE CAN BE SUBSTITUTED FOR COMBINATION 4, 5, 10 AND 11.
 - (U) CENTER HUB SAME AS (C) EXCEPT TOP OPENING MAY BE THREADED.
 - (V) DOOR HINGE ON OUTSIDE OF SIDE BY SIDE ASSEMBLY.
 - (W) USE BALANCE ADJUSTER TO PLUMB SIGNAL ASSEMBLIES AS REQUIRED.

TRAFFIC SIGNAL CABLE COLOR ASSIGNMENTS

SIGNAL ASSEMBLY & CABLE USED	SIGNAL FUNCTION	ARTERY 1	ARTERY 2	SIDE STREET 1	SIDE STREET 2
2 - WAY 9 CONDUCTOR	RED	RED		BLACK	
	YELLOW	ORANGE		WHITE \ BLACK	
	GREEN	GREEN		BLUE	
	SPARE	GREEN\BLACK		RED \ BLACK	
	NEUTRAL	WHITE			
3 - WAY 12 CONDUCTOR	RED	RED	RED \ BLACK	BLACK	
	YELLOW	ORANGE	ORANGE \ BLACK	WHITE \ BLACK	
	GREEN	GREEN	GREEN \ BLACK	BLUE	
	SPARE	BLUE\BLACK	BLACK \ WHITE		
	NEUTRAL	WHITE			
4 - WAY 15 CONDUCTOR	RED	RED	RED \ BLACK	BLACK	RED \ WHITE
	YELLOW	ORANGE	ORANGE \ BLACK	WHITE \ BLACK	BLACK \ WHITE
	GREEN	GREEN	GREEN \ BLACK	BLUE	GREEN \ WHITE
	SPARE	BLUE\BLACK		BLUE \ WHITE	
	NEUTRAL	WHITE			

PEDESTRIAN SIGNAL CABLE COLOR ASSIGNMENTS

SIGNAL ASSEMBLY & CABLE USED	SIGNAL FUNCTION	WIRE COLOR
WALK SIGNAL W/ PUSHBUTTON 7 CONDUCTOR	DON'T WALK	RED
	WALK	GREEN
	NEUTRAL FOR WALK SIGNAL	WHITE
	PEDESTRIAN PUSHBUTTON	BLACK
	NEUTRAL FOR PUSHBUTTON	ORANGE
WALK SIGNAL W/ PUSHBUTTON 7 CONDUCTOR	SPARE CONDUCTOR	WHITE \ BLACK
	SPARE CONDUCTOR *	BLUE \ BLACK
	RED	RED
	YELLOW	ORANGE
	GREEN	GREEN
WALK SIGNAL W/ PUSHBUTTON 7 CONDUCTOR	NEUTRAL FOR TRAFFIC SIGNAL	WHITE
	PEDESTRIAN PUSHBUTTON	BLACK
	NEUTRAL FOR PUSHBUTTON	WHITE \ BLACK
	SPARE CONDUCTOR *	BLUE \ BLACK

* IF 14/7 FEEDS MORE THAN ONE BUTTON, SPLIT THE BUTTONS AND USE BLUE WITH BLACK TRACER FOR THE ADDITIONAL BUTTON.

TABLE NOTES:

- INSTALL SEPARATE CABLE BETWEEN CLOSURE AND EACH TRAFFIC SIGNAL ASSEMBLY. WIRE EACH TRAFFIC SIGNAL SECTION SEPARATELY BACK TO CABLE CLOSURE. JUMPERS BETWEEN TERMINALS ARE NOT ALLOWED EXCEPT ON NEUTRAL CONDUCTORS.
- WIRE ALL SIGNALS, SAME DIRECTION FROM CONTROLLER, SEPARATELY WITH CONDUCTORS IN 21 CONDUCTOR CABLE, EVEN IF INDICATIONS ARE IDENTICAL.
- CABLES THAT FEED PEDESTRIAN INDICATIONS, PUSH BUTTONS, AND DETECTORS BYPASS CABLE CLOSURE.
- REFER TO STANDARD SHEET TR-1113.01 FOR CABLE CLOSURE - TYPE A.

NOTES:

SERVICE CONDUCTORS: THW, THWN OR XHHW. INDIVIDUAL WIRES MAY BE USED IN LIEU OF MULTI-CONDUCTOR CABLE.

ALL WORK ON UTILITY POLES MUST COMPLY WITH CURRENT PURA REGULATIONS AND NESC RULES.

- (A) ATTACH SPAN AT LEAST 12" (300) BELOW LOWEST POWER COMPANY ATTACHMENT, AND AT LEAST 40" (1000) ABOVE HIGHEST COMMUNICATIONS ATTACHMENT, UNLESS OTHERWISE DIRECTED ON PLANS.
- (B) ELBOW OR "T" FITTING MUST HAVE NOTCH FOR SERRATED TABBED LOCKRING.
- (C) TOP BRACKET CENTER HUB SHALL BE MIN 4" (100) ROUND AND 3" (75) DEEP OR EQUAL VOLUME. SERRATION CAST IN HUB OR TABBED OR SERRATED LOCKRING, TOP OPENING NOT THREADED.
- (D) NIPPLE LENGTH DEPENDS ON SPAN HEIGHT.
- (E) SAG OF SPAN TO BE 5%+ LENGTH, UNLESS OTHERWISE ALLOWED BY ENGINEER.
- (F) FACE ALL ENTRANCE FITTINGS TOWARD CABLE CLOSURE UNLESS SIGNAL ASSEMBLY IS UNBALANCED AND A BALANCE ADJUSTER IS USED.
- (G) INSTALL EXTENSION NIPPLE ON TOP OF SIGNAL HOUSING SO BOTTOM OF ALL SIGNALS ARE EVEN.
- (H) REFER TO TYPICAL "SIGN FACE SHEET ALUMINUM, R-SERIES SIGNS", AND TO TR-1208.03 FOR SIGN HANGER ASSEMBLY. MAXIMUM SIGN SIZE 24" X 24" (600 X 600). ALL STAINLESS STEEL HARDWARE.
- (I) SECURE LOUVERS TO TUNNEL VISORS WITH 3 STAINLESS STEEL SCREWS.

TOWN OF BROOKFIELD, CT

PROJECT NAME: **TOWN DISTRICT SIDEWALK AND ACCESS
MANAGEMENT PLAN**

SHEET TITLE: TRAFFIC SIGNALS AND CABLE ASSIGNMENTS

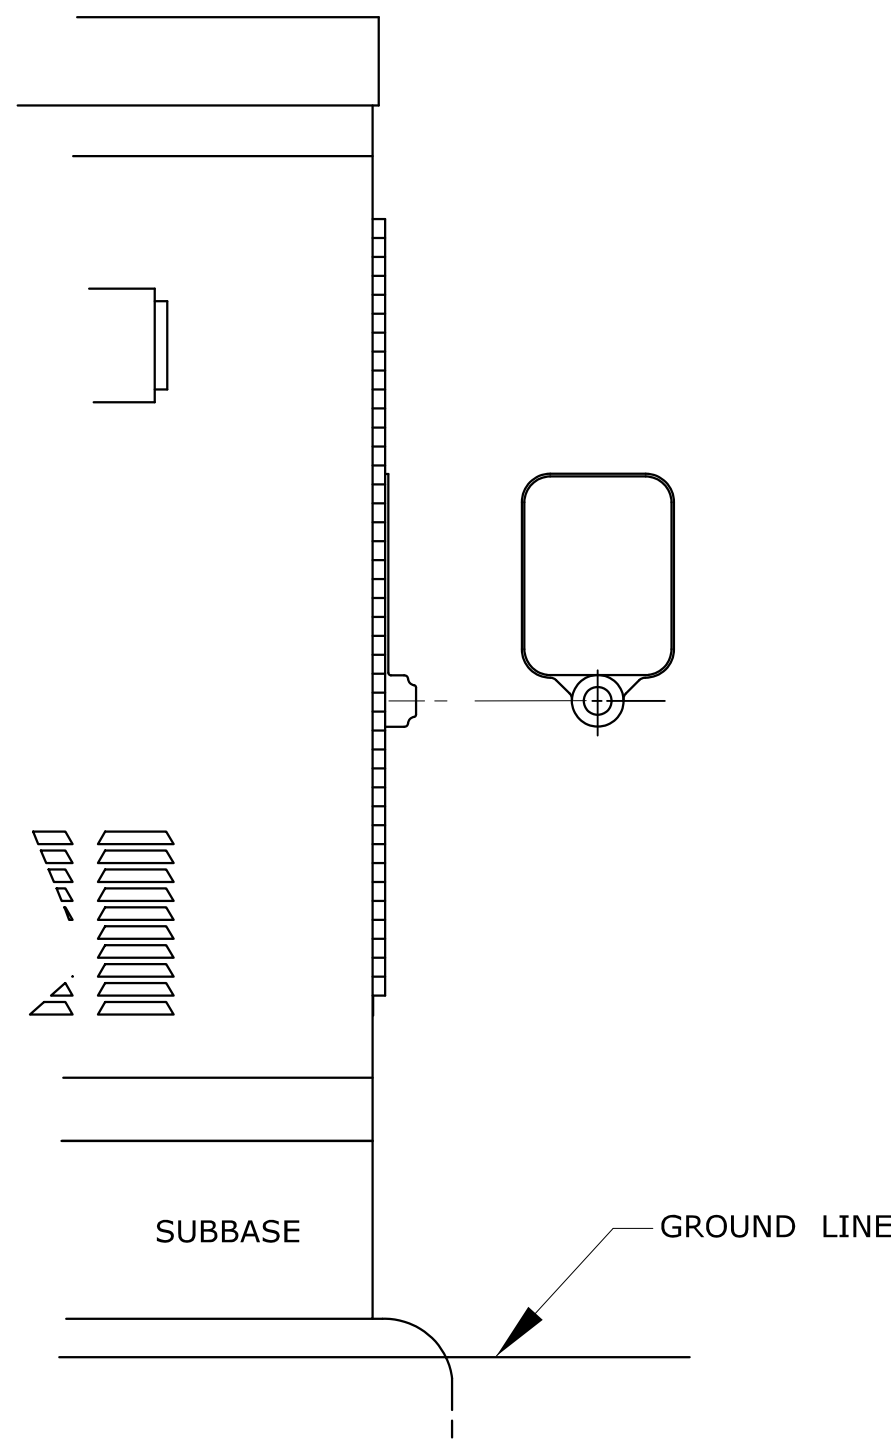
URS CORPORATION
500 ENTERPRISE DRIVE, SUITE 3B
ROCKY HILL, CT 06067
(860) 529-8882

FILE NAME:
PROJECT LEADER: SM
DESIGNED BY: AG

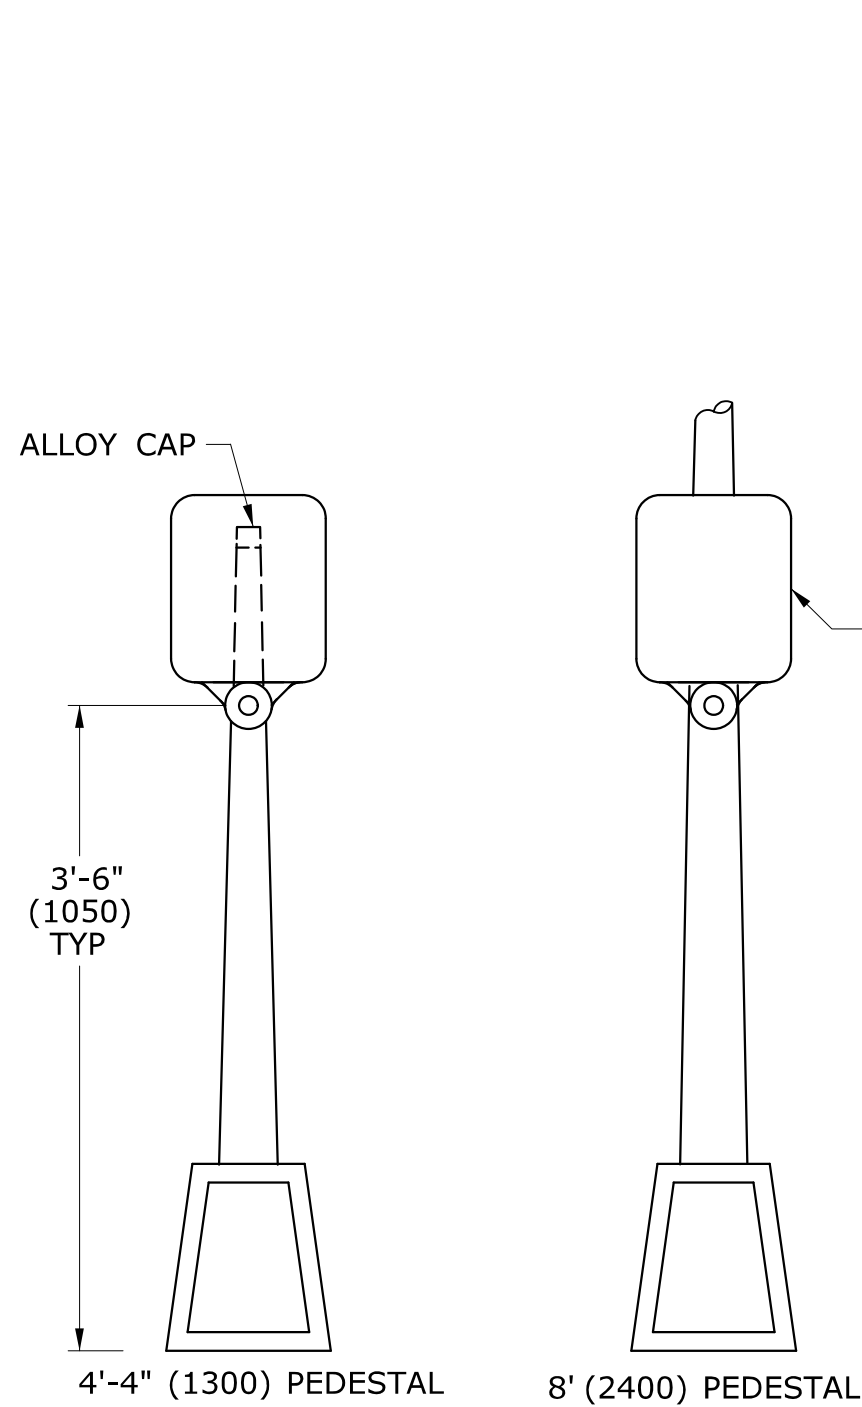
PLOT DATE: 4/20/2016
DRAWN BY: AG
CHECKED BY: PG

DRAWING NO.:
MDS-08
SHEET NO.:
14

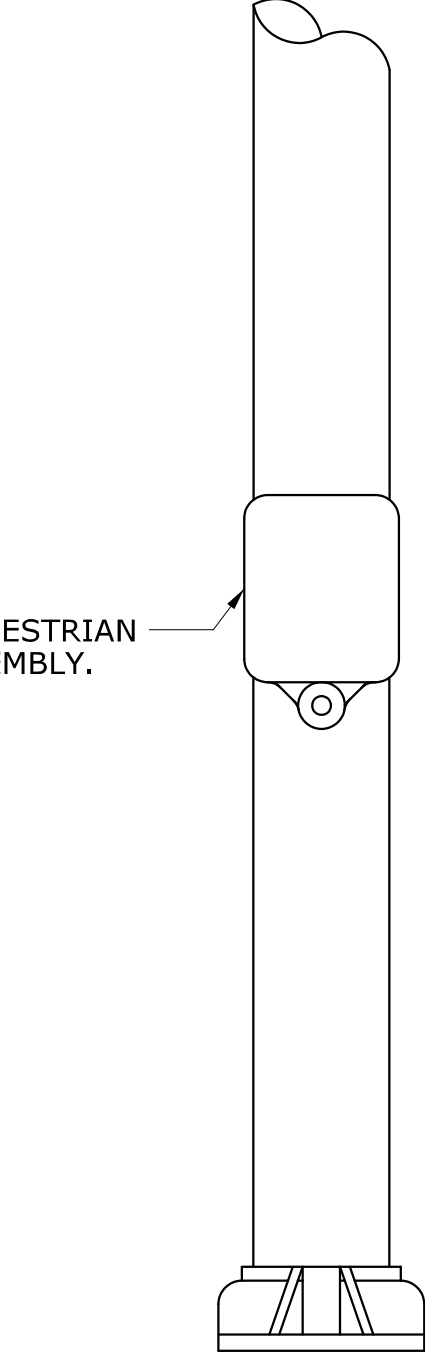
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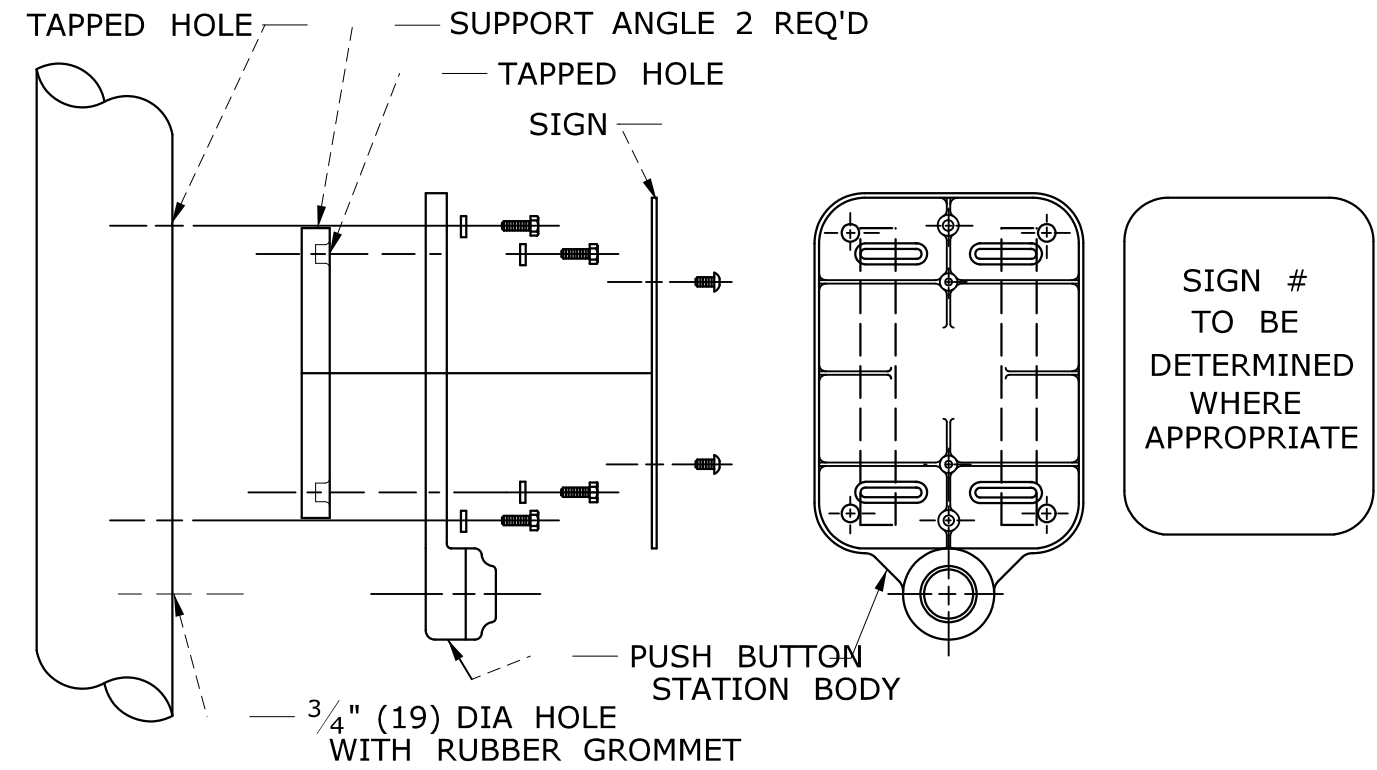
SURFACE MOUNTED



PEDESTAL MOUNTED



SPAN POLE/MAST ARM MOUNTED



DETAIL A



SIGN # 31-0833
* USE APPROPRIATE ARROW UNLESS OTHERWISE NOTED ON PLAN.

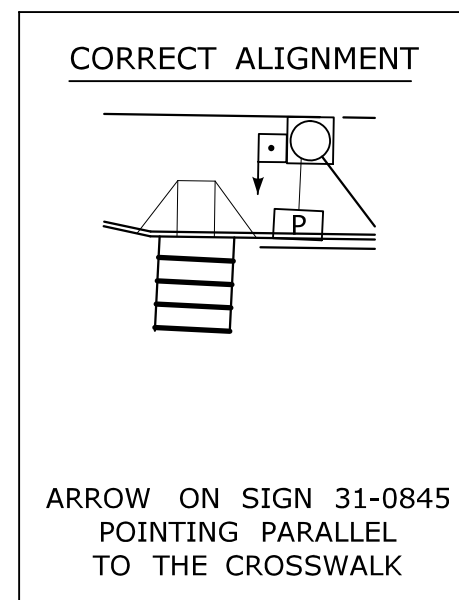


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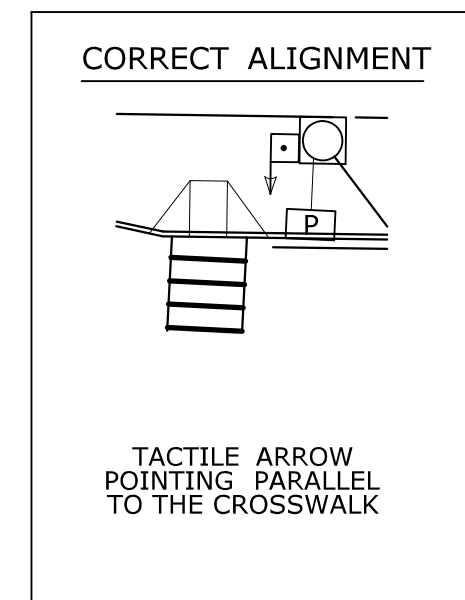
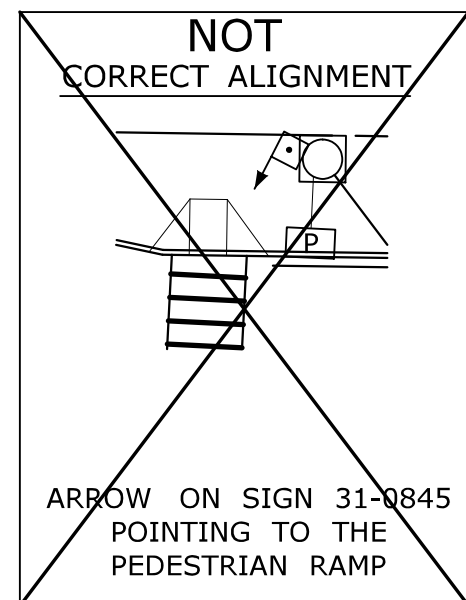
FOR CROSSING WITH SIDE STREET GREEN

GENERAL NOTES:

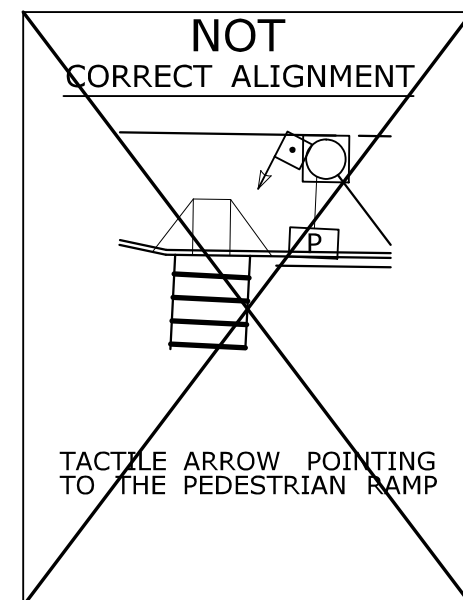
3'-6" (1050) FROM FINISHED GRADE SUCH AS SIDEWALK TO CENTER OF PUSH BUTTON.
PUSH BUTTON INSTALLATIONS SHALL CONFORM TO THE REQUIREMENTS OF THE AMERICANS WITH DISABILITIES ACT (ADA) STANDARDS FOR ACCESSIBLE DESIGN, CURRENT EDITION GOVERNS.
4'-4" (1300) PEDESTAL TO INCLUDE ALLOY CAP SECURED WITH STAINLESS STEEL SET SCREW.




PEDESTRIAN PUSH BUTTON ALIGNMENT



ACCESSIBLE PEDESTRIAN SIGNAL AND DETECTOR



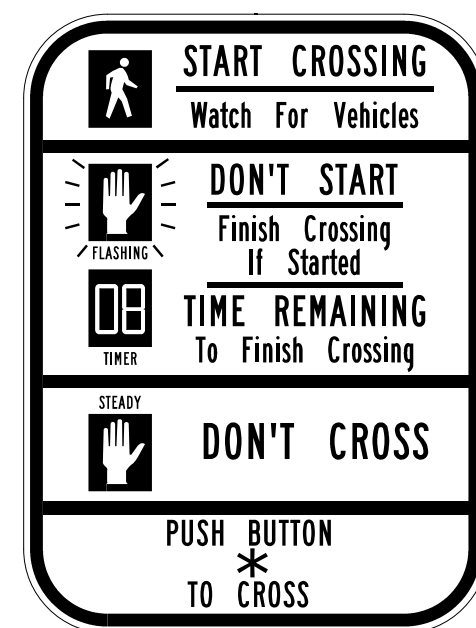EXAMPLE ALIGNMENTS FOR EXCLUSIVE PEDESTRIAN PHASE



SIGN # 31-0845
* USE APPROPRIATE ARROW UNLESS OTHERWISE NOTED ON PLAN.

LEGEND AS SHOWN ON TRAFFIC CONTROL SIGNAL PLAN:
[Symbol] PEDESTRIAN PUSH BUTTON
[Symbol] PEDESTRIAN PUSH BUTTON, PEDESTAL MOUNTED
[Symbol] PEDESTRIAN PUSH BUTTON, POLE MOUNTED

TOWN OF BROOKFIELD, CT

PROJECT NAME: **TOWN DISTRICT SIDEWALK AND ACCESS MANAGEMENT PLAN**

SHEET TITLE: PEDESTRIAN PUSH BUTTON

FILE NAME:

PLOT DATE: 4/20/2016

DRAWING NO.:

MDS-09

PROJECT LEADER:

SM

DRAWN BY:

AG

DESIGNED BY:

AG

CHECKED BY:



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SHEET NO.:


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(860) 529-8882

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GUIDE RAIL PLACEMENT FOR SIGN SUPPORTS

NOTES:

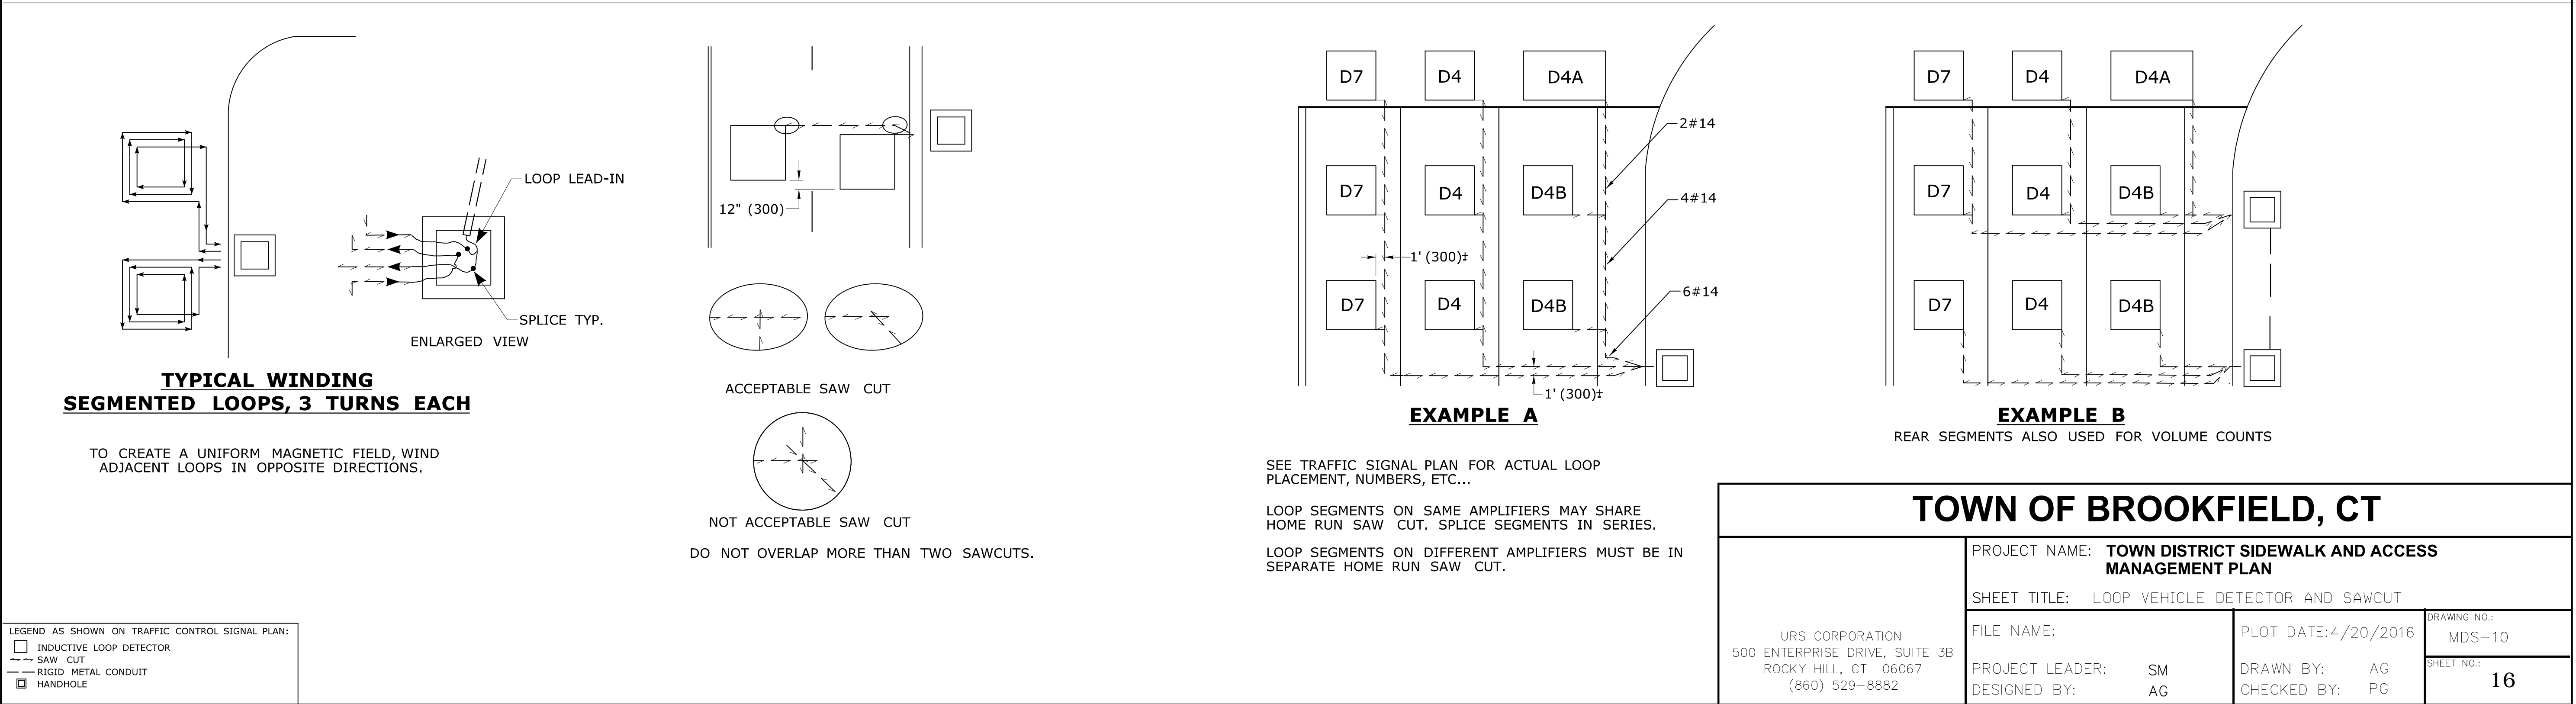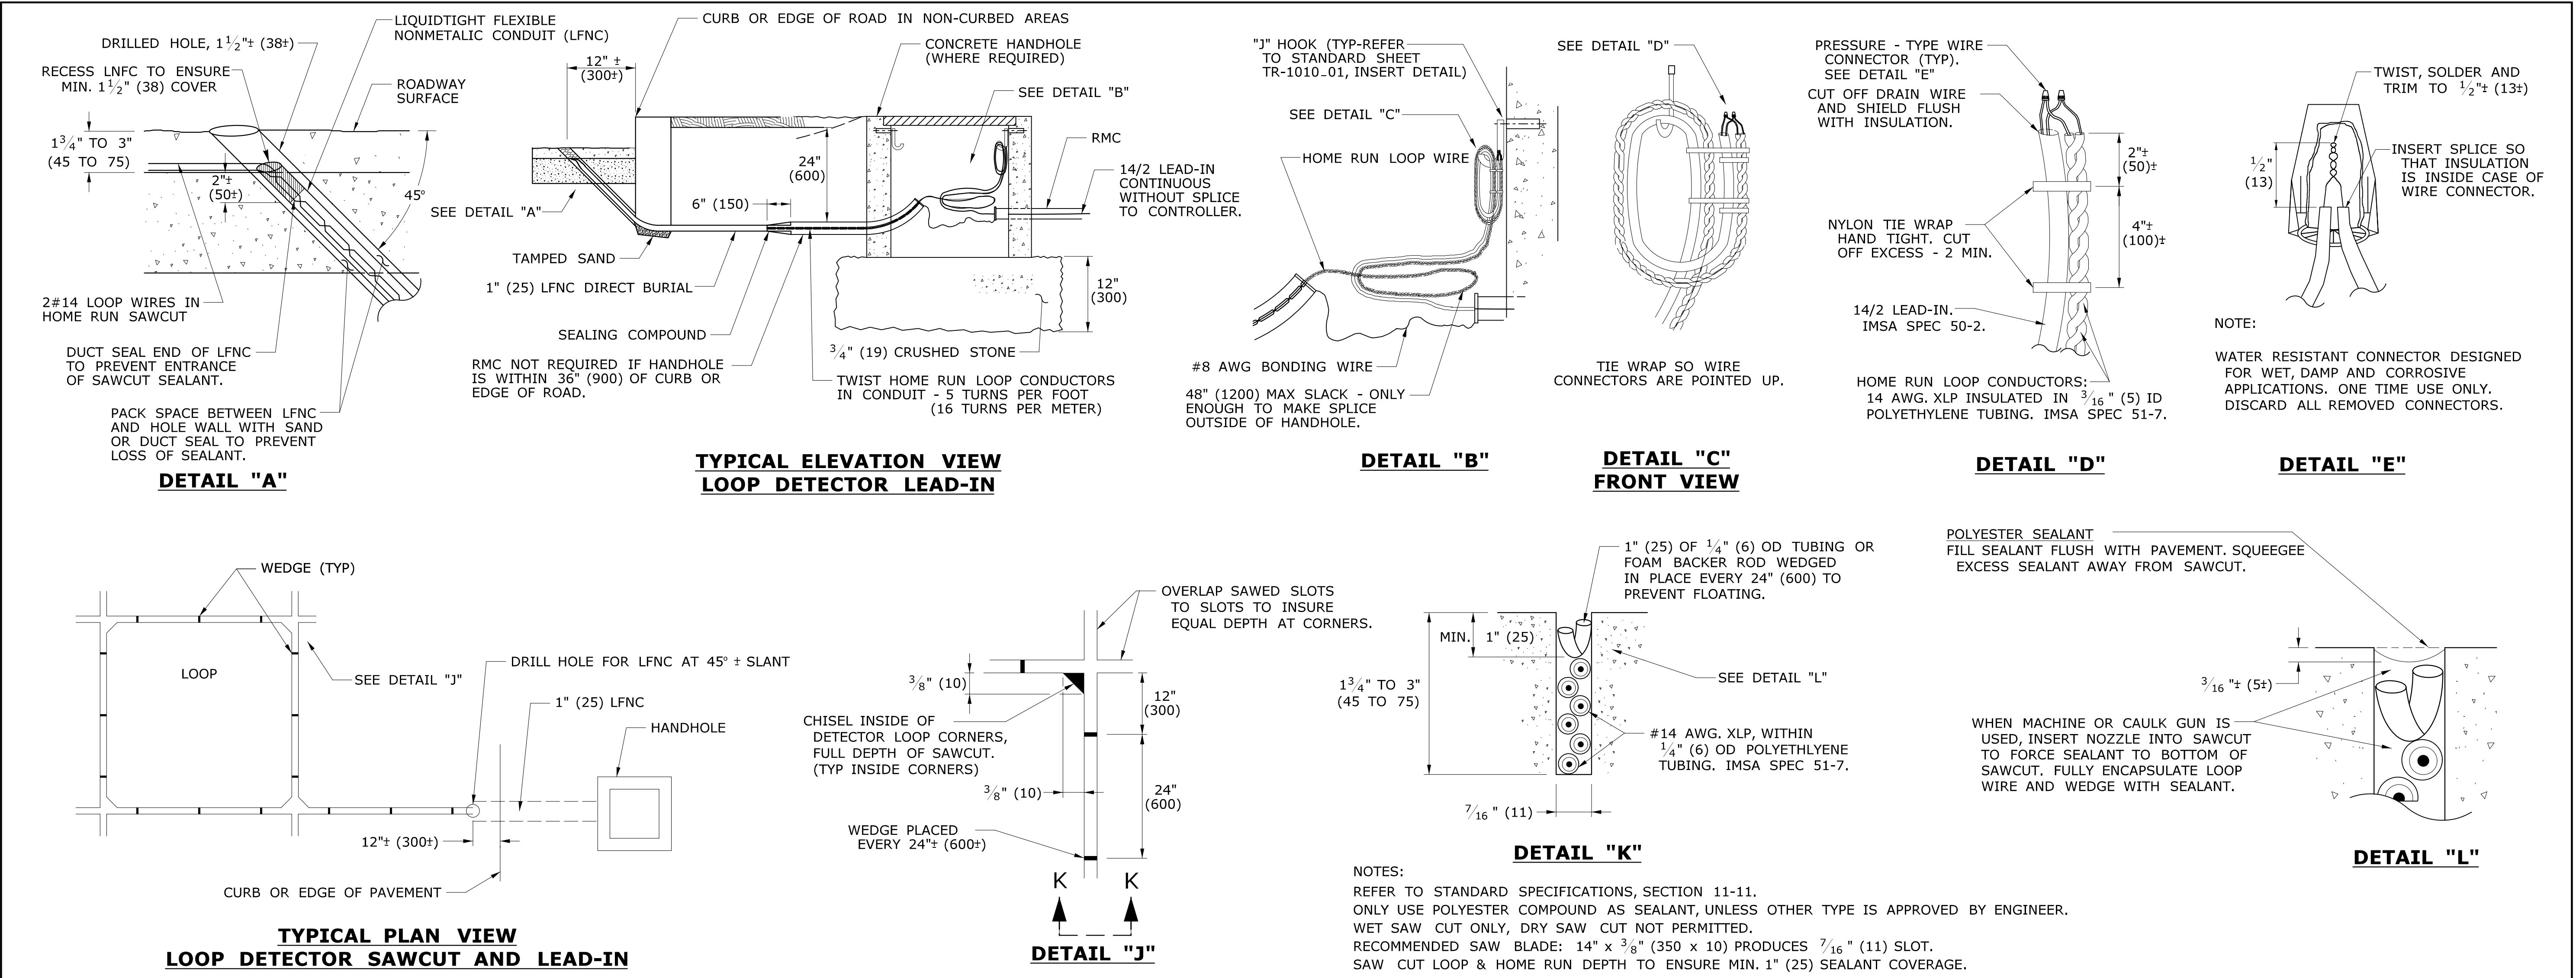- 1) FOR PLACEMENT OF CANTILEVER SIGN SUPPORT USE APPLICABLE PORTION OF ABOVE DETAIL.
- 2) BARRIER SYSTEM IS REQUIRED FOR BOTH SIDES OF MEDIAN SUPPORTS IN NARROW MEDIANS.
- 3) AT LOCATIONS WHERE IMPACT PROTECTION IS NOT REQUIRED FOR ROADSIDE ELEMENTS, FACE OF GUIDE RAIL SHALL BE PLACED 30' (9.1m) FROM EDGE OF TRAVELWAY.
- 4) OFFSETS OF FOUNDATIONS FROM BARRIER SYSTEMS SHALL BE AS SHOWN ELSEWHERE ON THE CONTRACT PLANS.
- 5) ALL SIGNS ARE TO BE HORIZONTAL, REGARDLESS OF CAMBER IN SUPPORT.

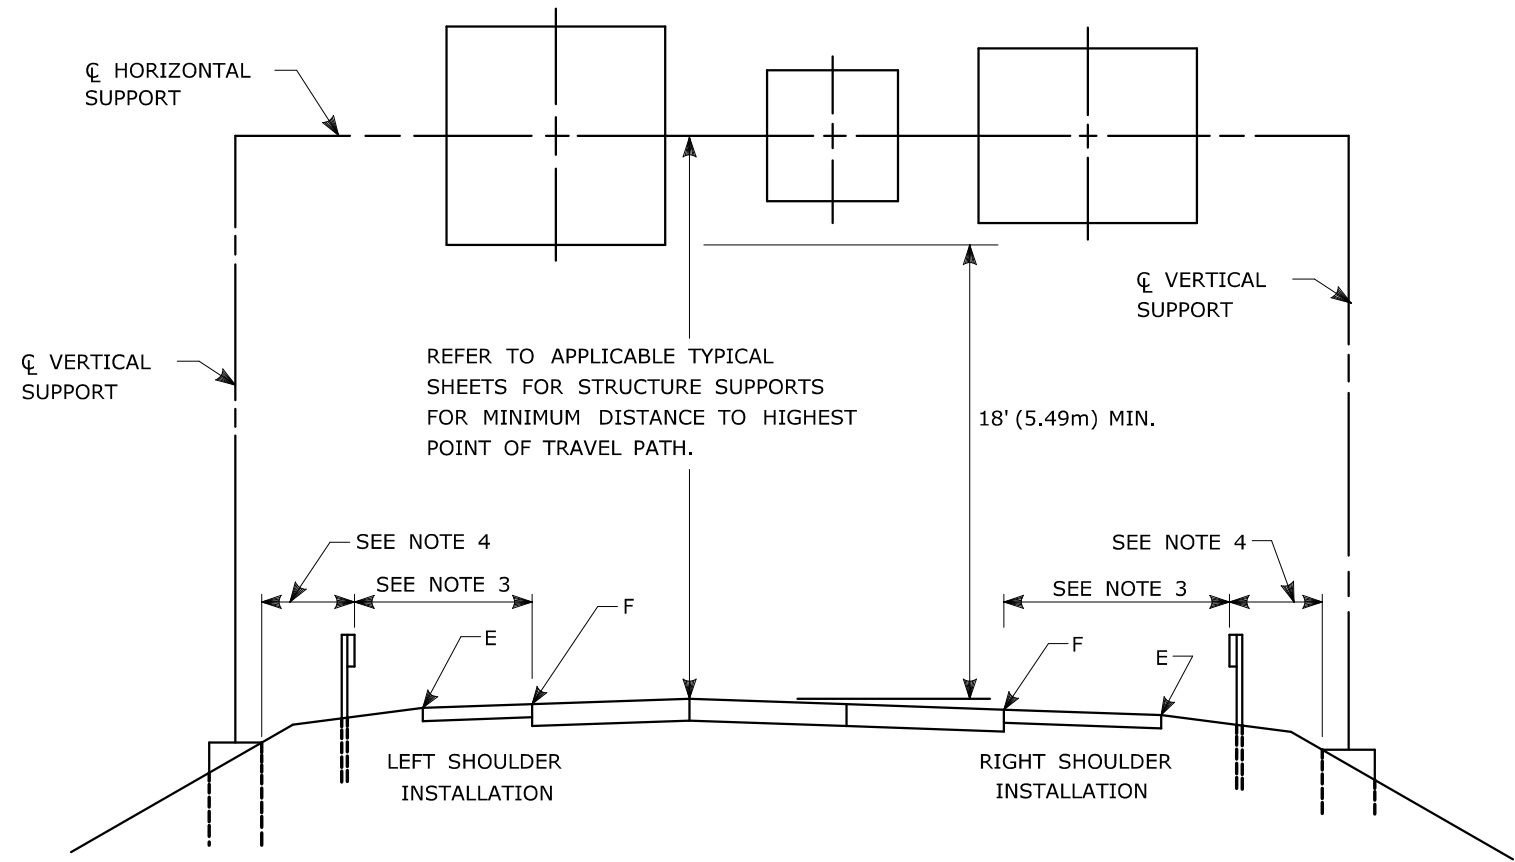FOR MAXIMUM EFFECTIVENESS AND TO ELIMINATE OR MINIMIZE GLARE, POSITION SIDE MOUNTED SIGNS ON STRUCTURAL STEEL BREAKAWAY SIGN SUPPORTS AS FOLLOWS:

ON A TANGENT SECTION, POSITION THE SIGN SO THE VERTICAL AXIS IS PLUMB AND THE HORIZONTAL AXIS IS AT AN ANGLE OF 93° WITH THE TRAFFIC LANE WHICH THE SIGN SERVES:

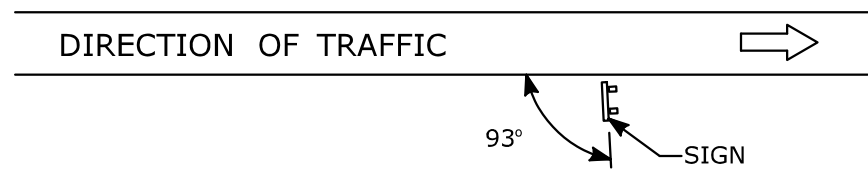


DIAGRAM "A"

ON A HORIZONTAL CURVE SECTION, POSITION THE SIGN SO THE VERTICAL AXIS IS PLUMB AND THE HORIZONTAL AXIS IS AT AN ANGLE OF 90° WITH A STRAIGHT LINE BETWEEN THE SIGN AND THE POINT AT WHICH THE SIGN SHALL BE READ.



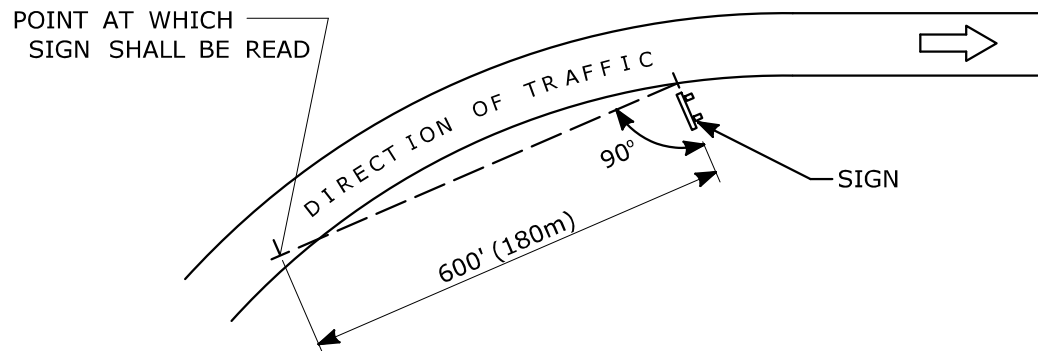


DIAGRAM "B"








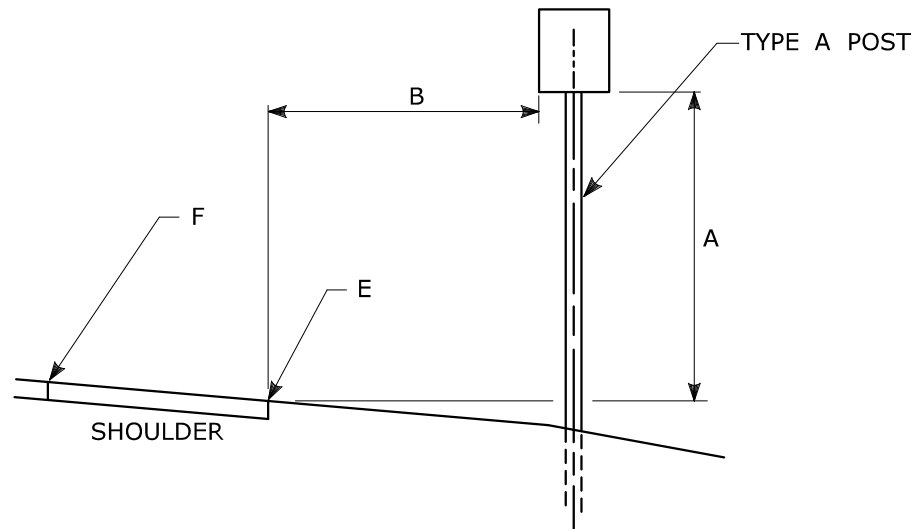
SIGN ORIENTATION DETAILS



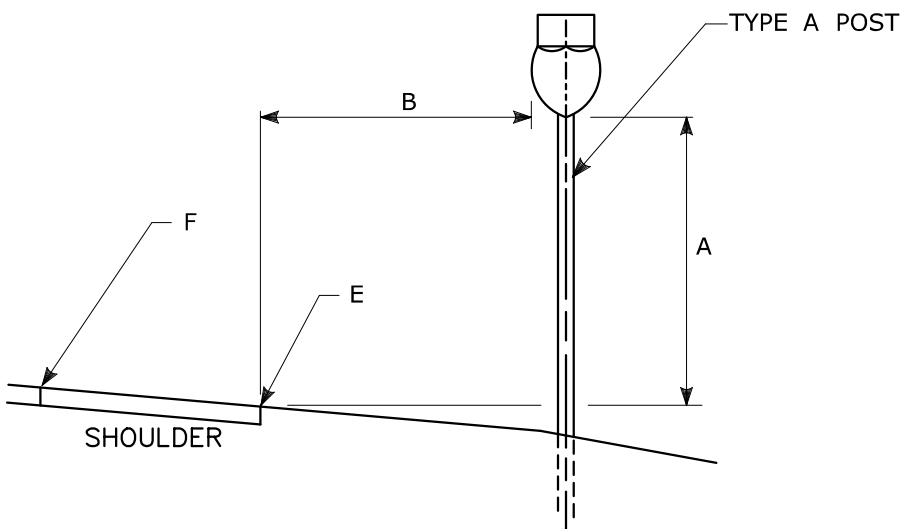TYPICAL REGULATORY & WARNING SIGN PLACEMENT



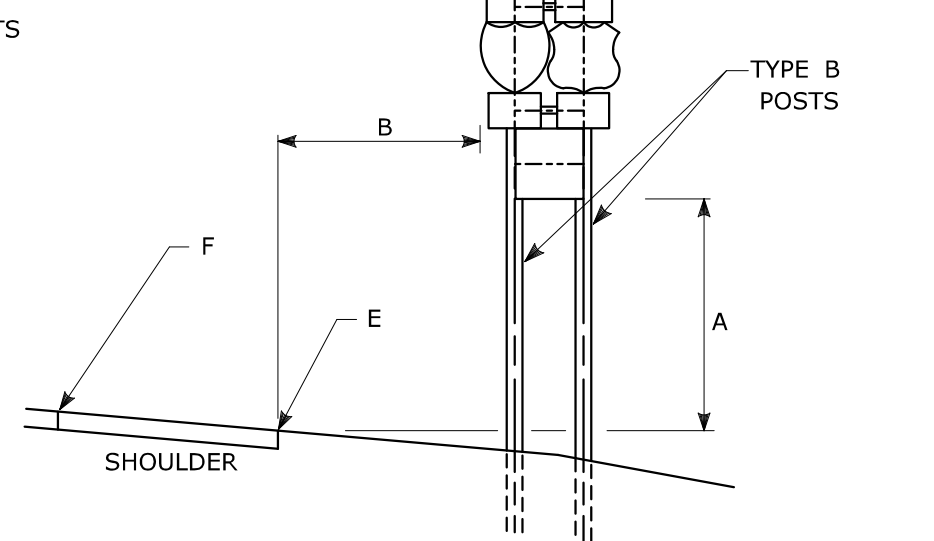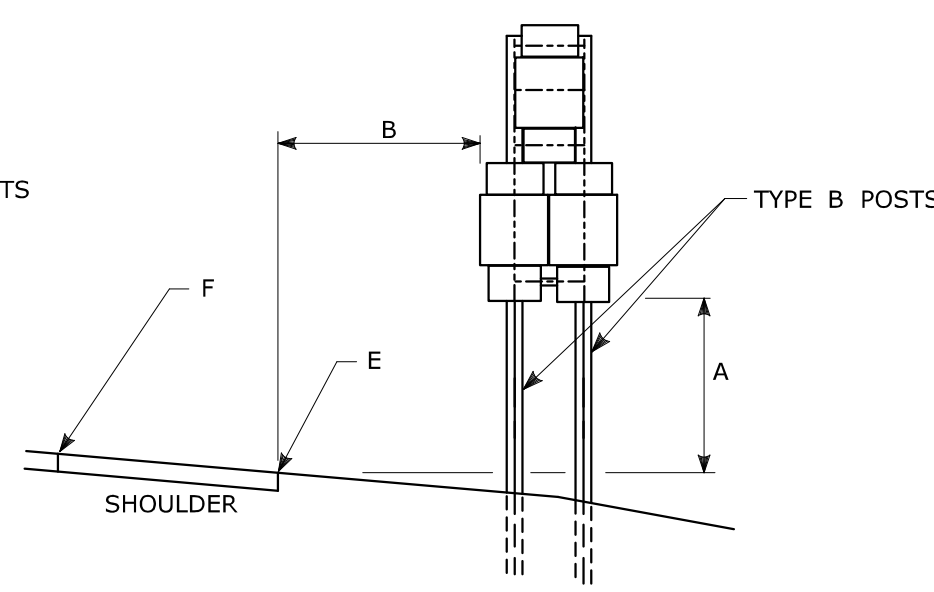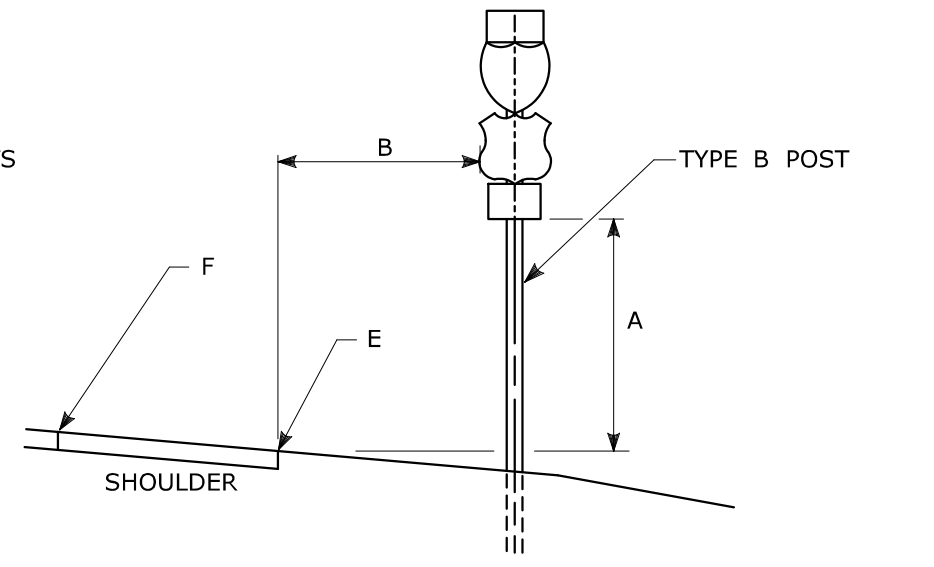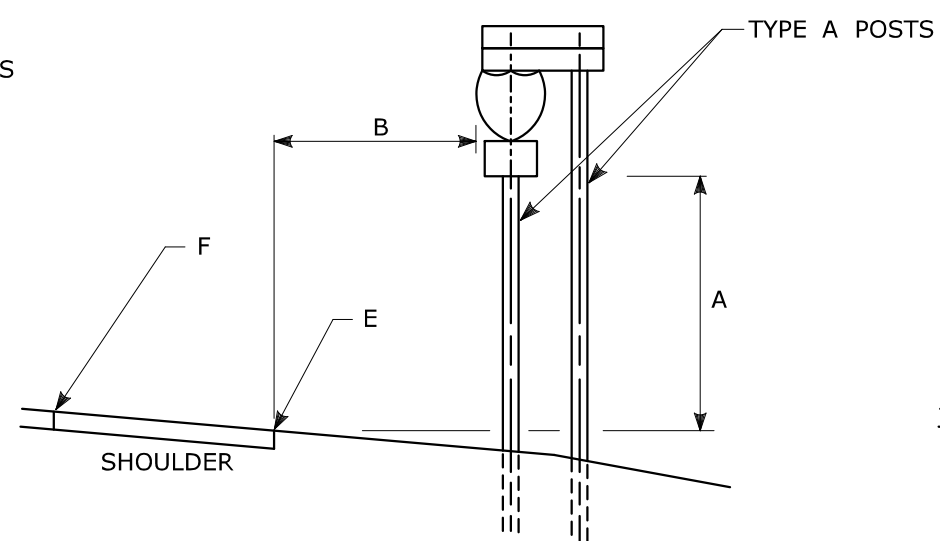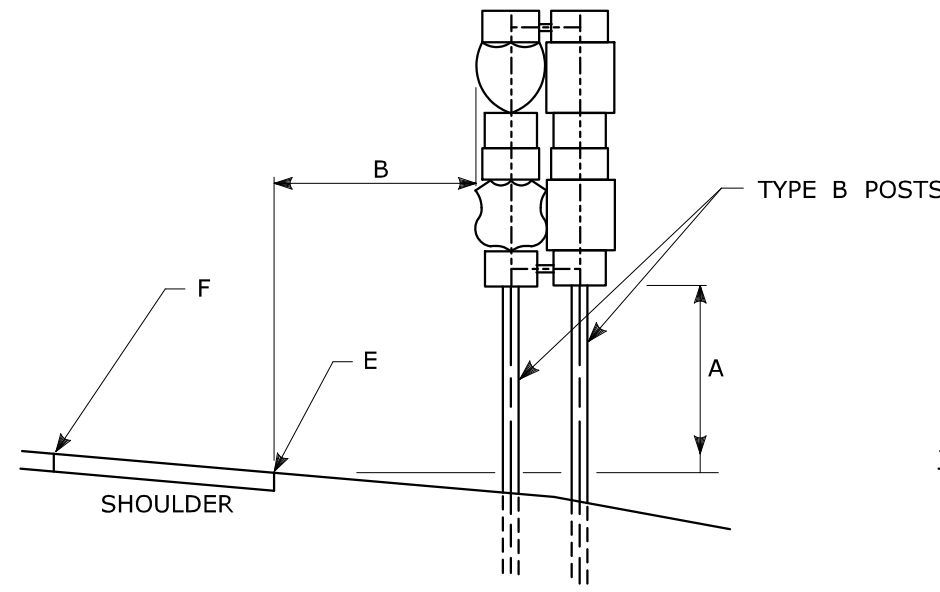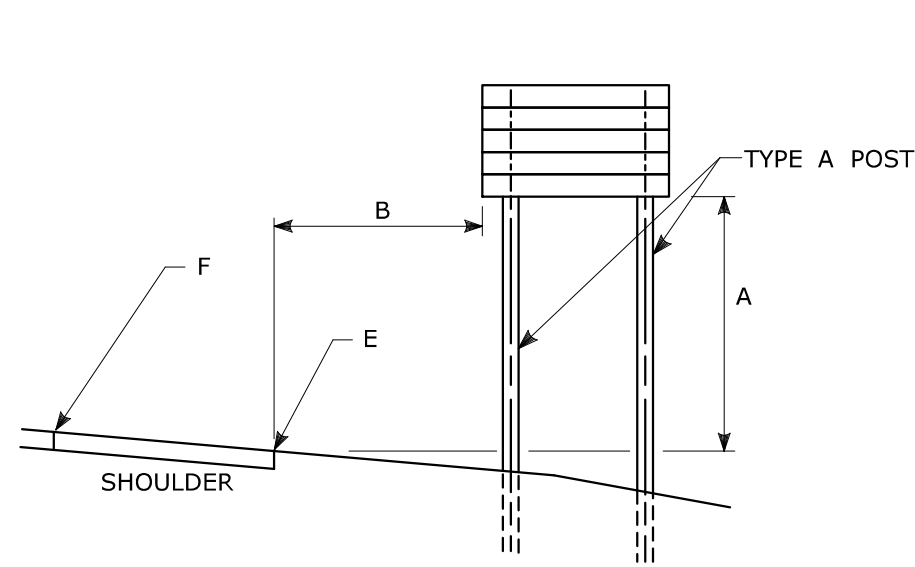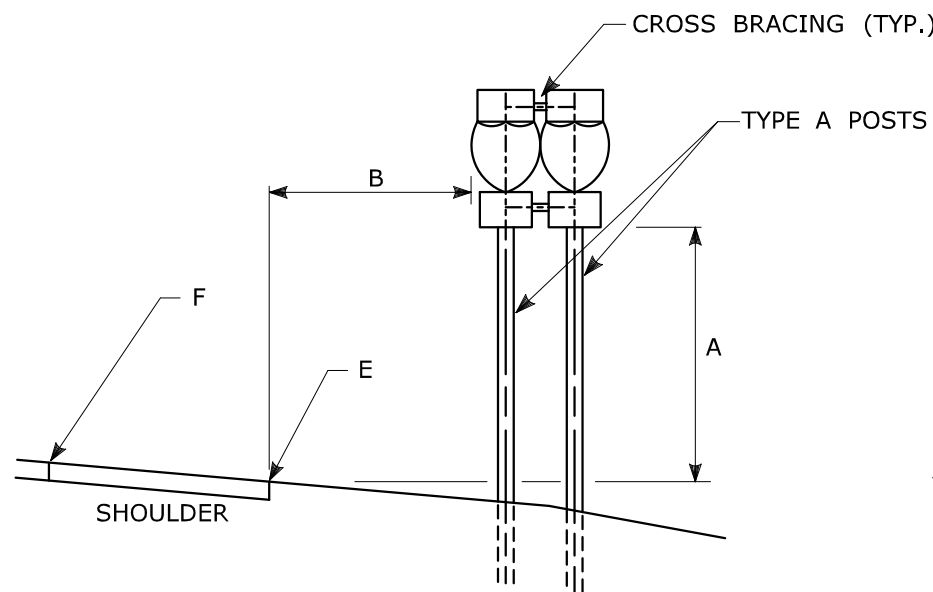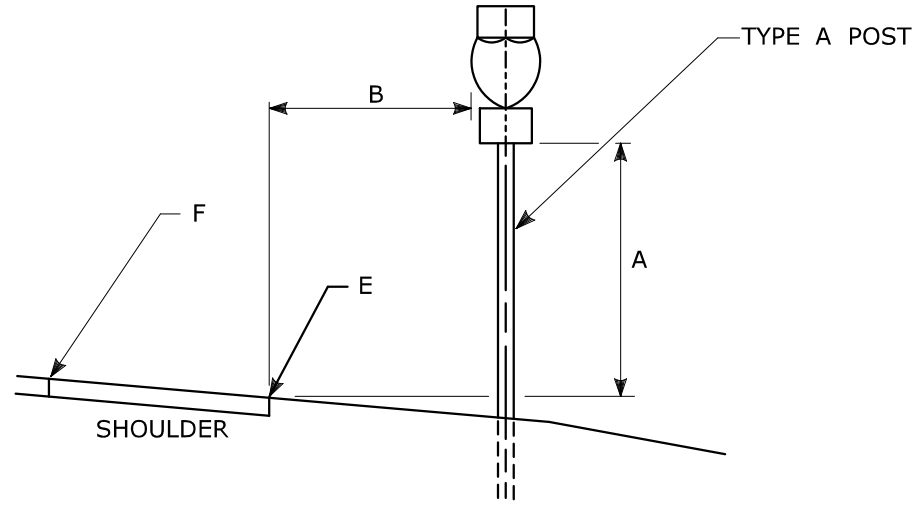TYPICAL CONFIRMATORY ROUTE MARKER PLACEMENT



TYPICAL SIGN PLACEMENT AND POST SELECTION

NOTES:

- ALL SIGNS AND SHIELDS ON DIRECTIONAL ASSEMBLIES SHALL ABUT VERTICALLY
2 POST ASSEMBLIES SHALL BE PROVIDED WITH 3" X 1/4" (75 X 6) GALVANIZED STEEL BAR CROSS BRACING.
REFER TO TRAFFIC TYPICAL SHEET "TYPICAL METAL SIGN POSTS AND SIGN MOUNTING DETAILS" FOR SIGN POSTS.

DIM."A"	DIM."B"	ASSEMBLY LOCATION
7' (2.1m)	6' (1.8m) 12' (3.6m)	RURAL DISTRICTS & EXPRESSWAYS
7' (2.1m)	2' (0.6m)	BUSINESS & RESIDENTIAL DISTRICTS WHERE PARKING OR OTHER OBSTRUCTIONS LIMIT VISIBILITY
8'-6" (2.6m)	1' (0.3m)	SIDEWALKS

- OR AS DIRECTED BY THE ENGINEER
 6' FROM EDGE OF SHOULDER, WHEN SHOULDER IS OVER 6' WIDE
12' FROM EDGE OF TRAVELWAY, WHEN SHOULDER IS LESS THAN 6' WIDE.
 A CLEAR PATH OF NOT LESS THAN 3 FT (0.9m) SHALL BE PROVIDED IN SIDEWALK AREAS.
"E" DENOTES EDGE OF SHOULDER OR FACE OF CURB
"F" DENOTES EDGE OF TRAVELWAY

TYPICAL PLACEMENT OF SIDE MOUNTED SIGNS ON STRUCTURAL STEEL BREAKAWAY SIGN SUPPORTS

NOTES:

- 1) MIN. VERTICAL CLEARANCE ABOVE SIDEWALKS SHALL BE 8'-6" (2.6m).
- 2) WHERE GUIDE RAIL IS USED, THE OFFSET TO THE NEAR EDGE OF SIGN FACE SHALL BE AS SHOWN ELSEWHERE IN THE CONTRACT PLANS.
- 3) ON INTERSECTING ROADS AT RAMP TERMINI, THE OFFSET TO THE NEAR EDGE OF OF SIGN FACE SHALL BE 6' (1.8m) MIN. FROM POINT "E".
- 4) IF 30'-0" (9.1m) MIN. CANNOT BE MET, PLEASE CONTACT THE ENGINEER.

TOWN OF BROOKFIELD, CT

PROJECT NAME: **TOWN DISTRICT SIDEWALK AND ACCESS MANAGEMENT PLAN**

SHEET TITLE: SIGN SUPPORT AND SIGN PLACEMENT DETAILS, GORE EXIT SIGN

URS CORPORATION
500 ENTERPRISE DRIVE, SUITE 3B
ROCKY HILL, CT 06067
(860) 529-8882

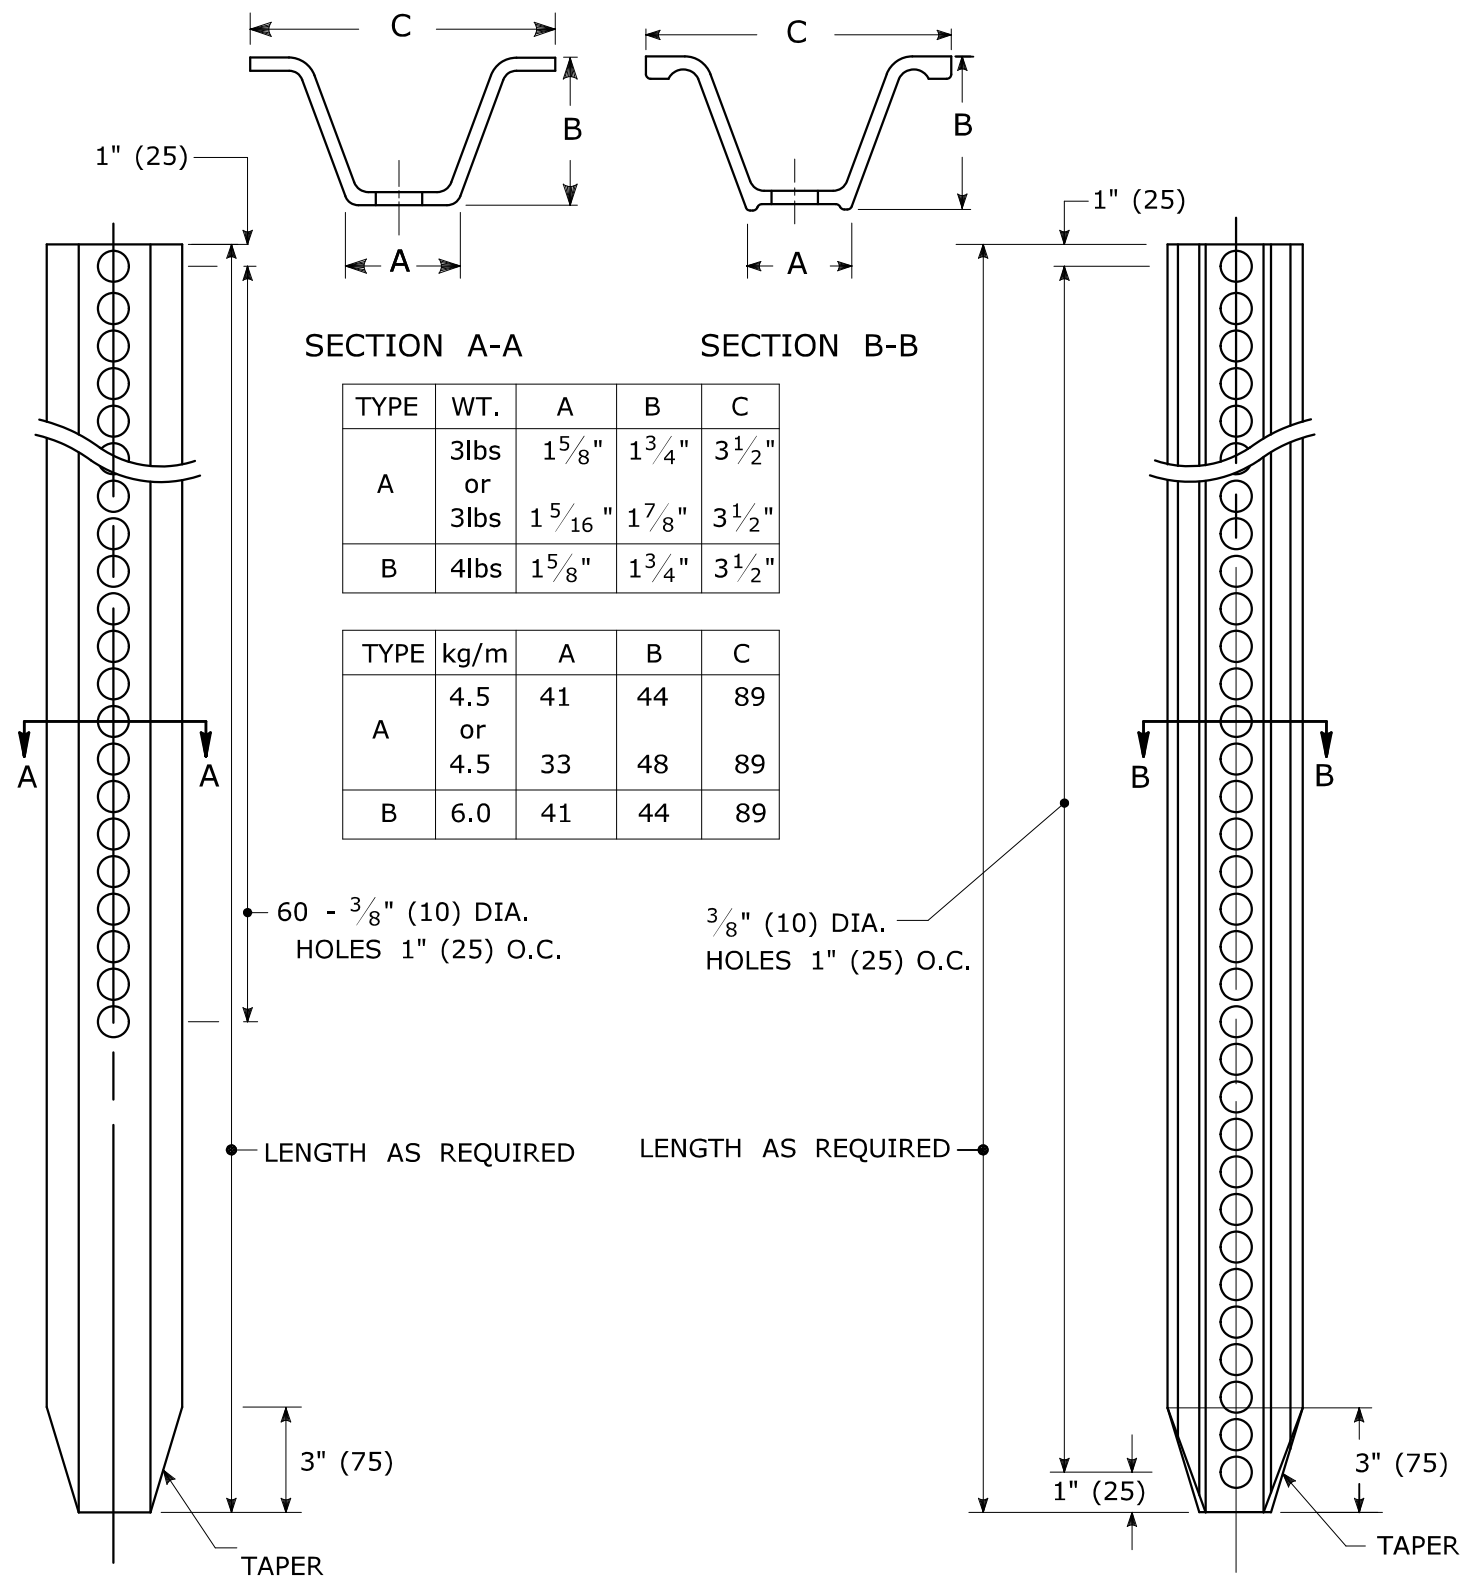
FILE NAME:
PROJECT LEADER: SM
DESIGNED BY: AG

PLOT DATE: 4/20/2016
DRAWN BY: AG
CHECKED BY: PG

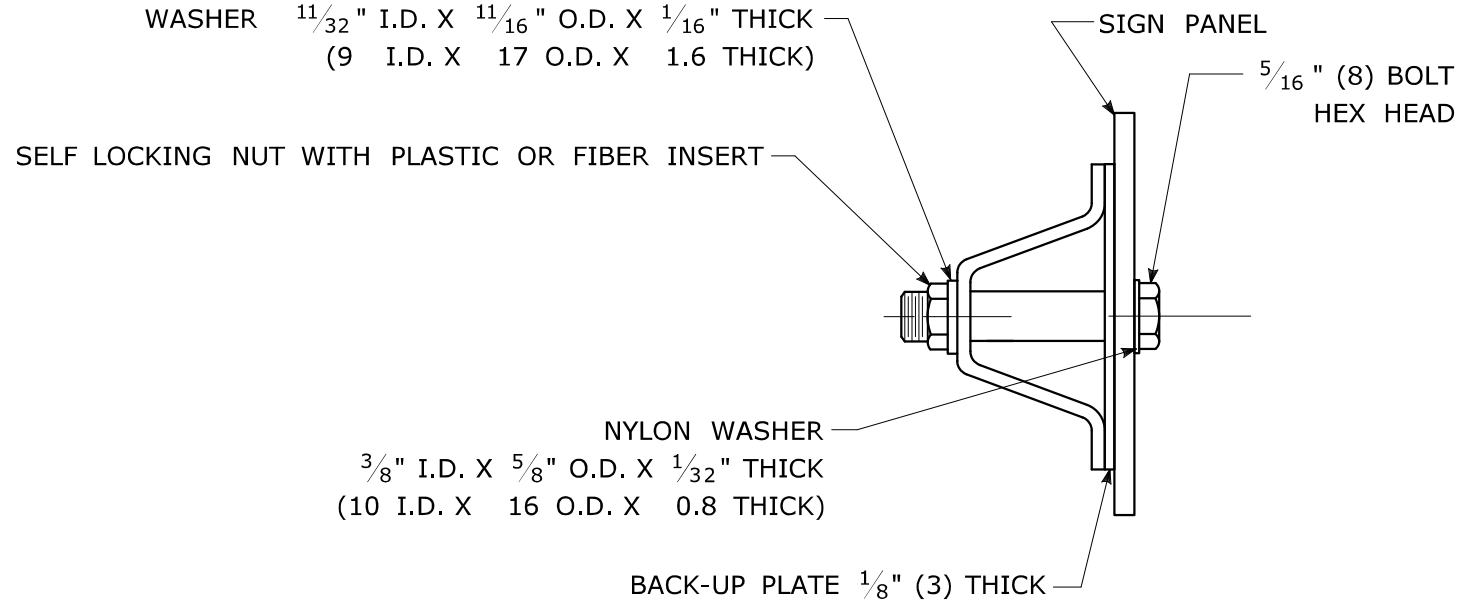
DRAWING NO.:
MDS-12
SHEET NO.:
18

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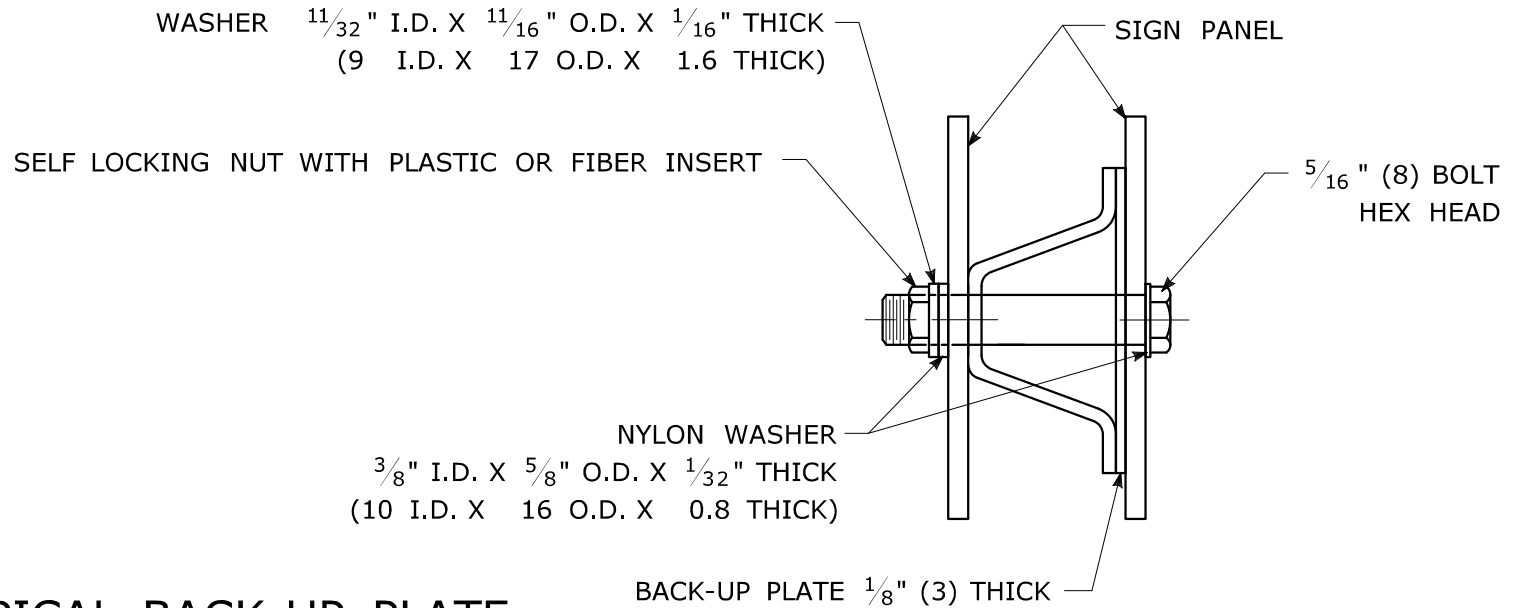
TYPICAL METAL SIGN POSTS




TYPICAL SIGN PANEL ATTACHMENT



TYPICAL BACK TO BACK SIGN PANEL ATTACHMENT




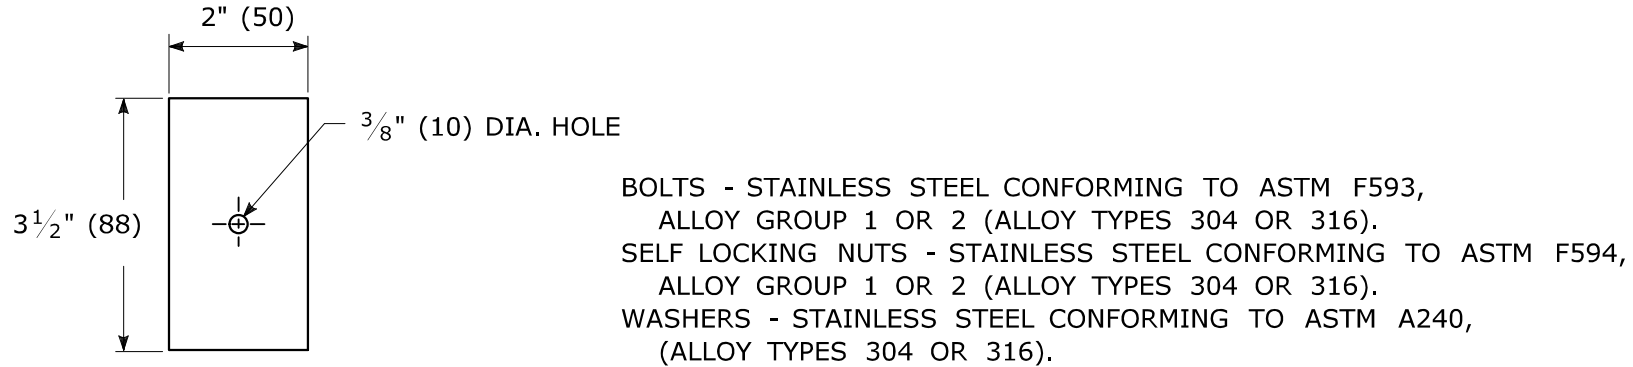TYPICAL BACK-UP PLATE



METAL DELINEATOR POST

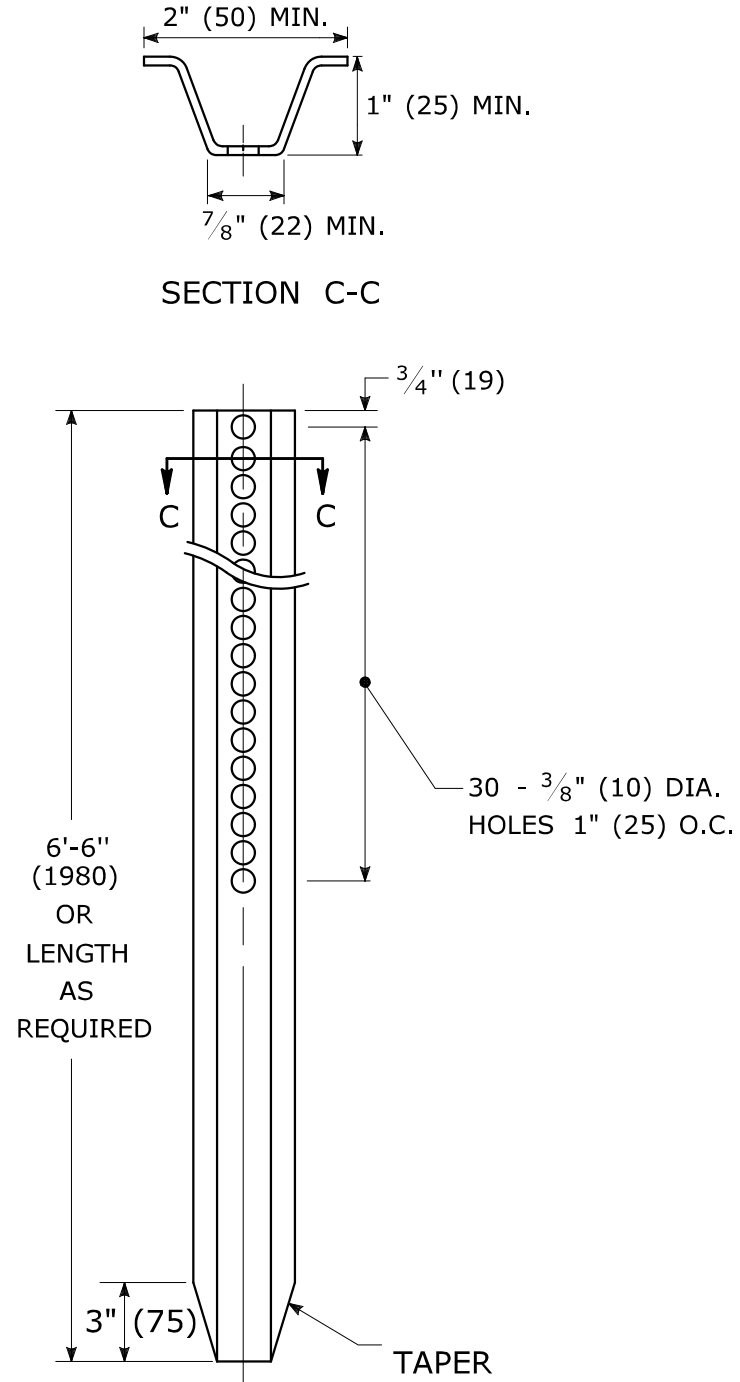WT./FT. = 1.12 LBS. MIN.
(MASS/m = 1.67 kg/m MIN.)




GENERAL NOTES:

- STEEL FOR DELINEATOR POSTS SHALL BE ASTM A36/A36(m) STEEL. STEEL FOR ALL OTHER POSTS SHALL CONFORM TO THE MECHANICAL REQUIREMENTS OF ASTM A 499 GRADE 60 AND TO THE CHEMICAL REQUIREMENTS OF ASTM A1 CARBON STEEL TEE RAIL HAVING NOMINAL WEIGHT (MASS) OF 91lbs. (45 kg.) OR GREATER PER LINEAR YARD (METER).
- AFTER FABRICATION, ALL STEEL POSTS, STRAPS AND PLATES SHALL BE GALVANIZED TO MEET THE REQUIREMENTS OF ASTM A123/A123(m).
- WASHERS FOR BREAKAWAY INSTALLATIONS SHALL MEET ASTM F436, TYPE 1.
- ALL BOLTS, NUTS, AND WASHERS FOR BREAKAWAY INSTALLATIONS SHALL BE GALVANIZED TO MEET THE REQUIREMENTS OF ASTM A153/A153(m).
- ALL SIGN POSTS SHALL HAVE BREAKAWAY FEATURES THAT MEET AASHTO REQUIREMENTS CONTAINED IN THE CURRENT "STANDARD SPECIFICATIONS FOR STRUCTURAL SUPPORTS FOR HIGHWAY SIGNS, LUMINAIRES AND TRAFFIC SIGNALS." THE BREAKAWAY FEATURES SHALL BE STRUCTURALLY ADEQUATE TO CARRY THE SIGNS SHOWN IN THE PLANS AT 60 mph (97 km/h) WIND LOADINGS. INSTALLATIONS SHALL BE IN ACCORDANCE WITH MANUFACTURERS RECOMMENDATIONS.
- TYPE A POSTS - 3 lbs/ft (4.5 kg/m) TYPE B POSTS - 4 lbs/ft (6 kg/m).


BREAKAWAY TYPE I INSTALLATION

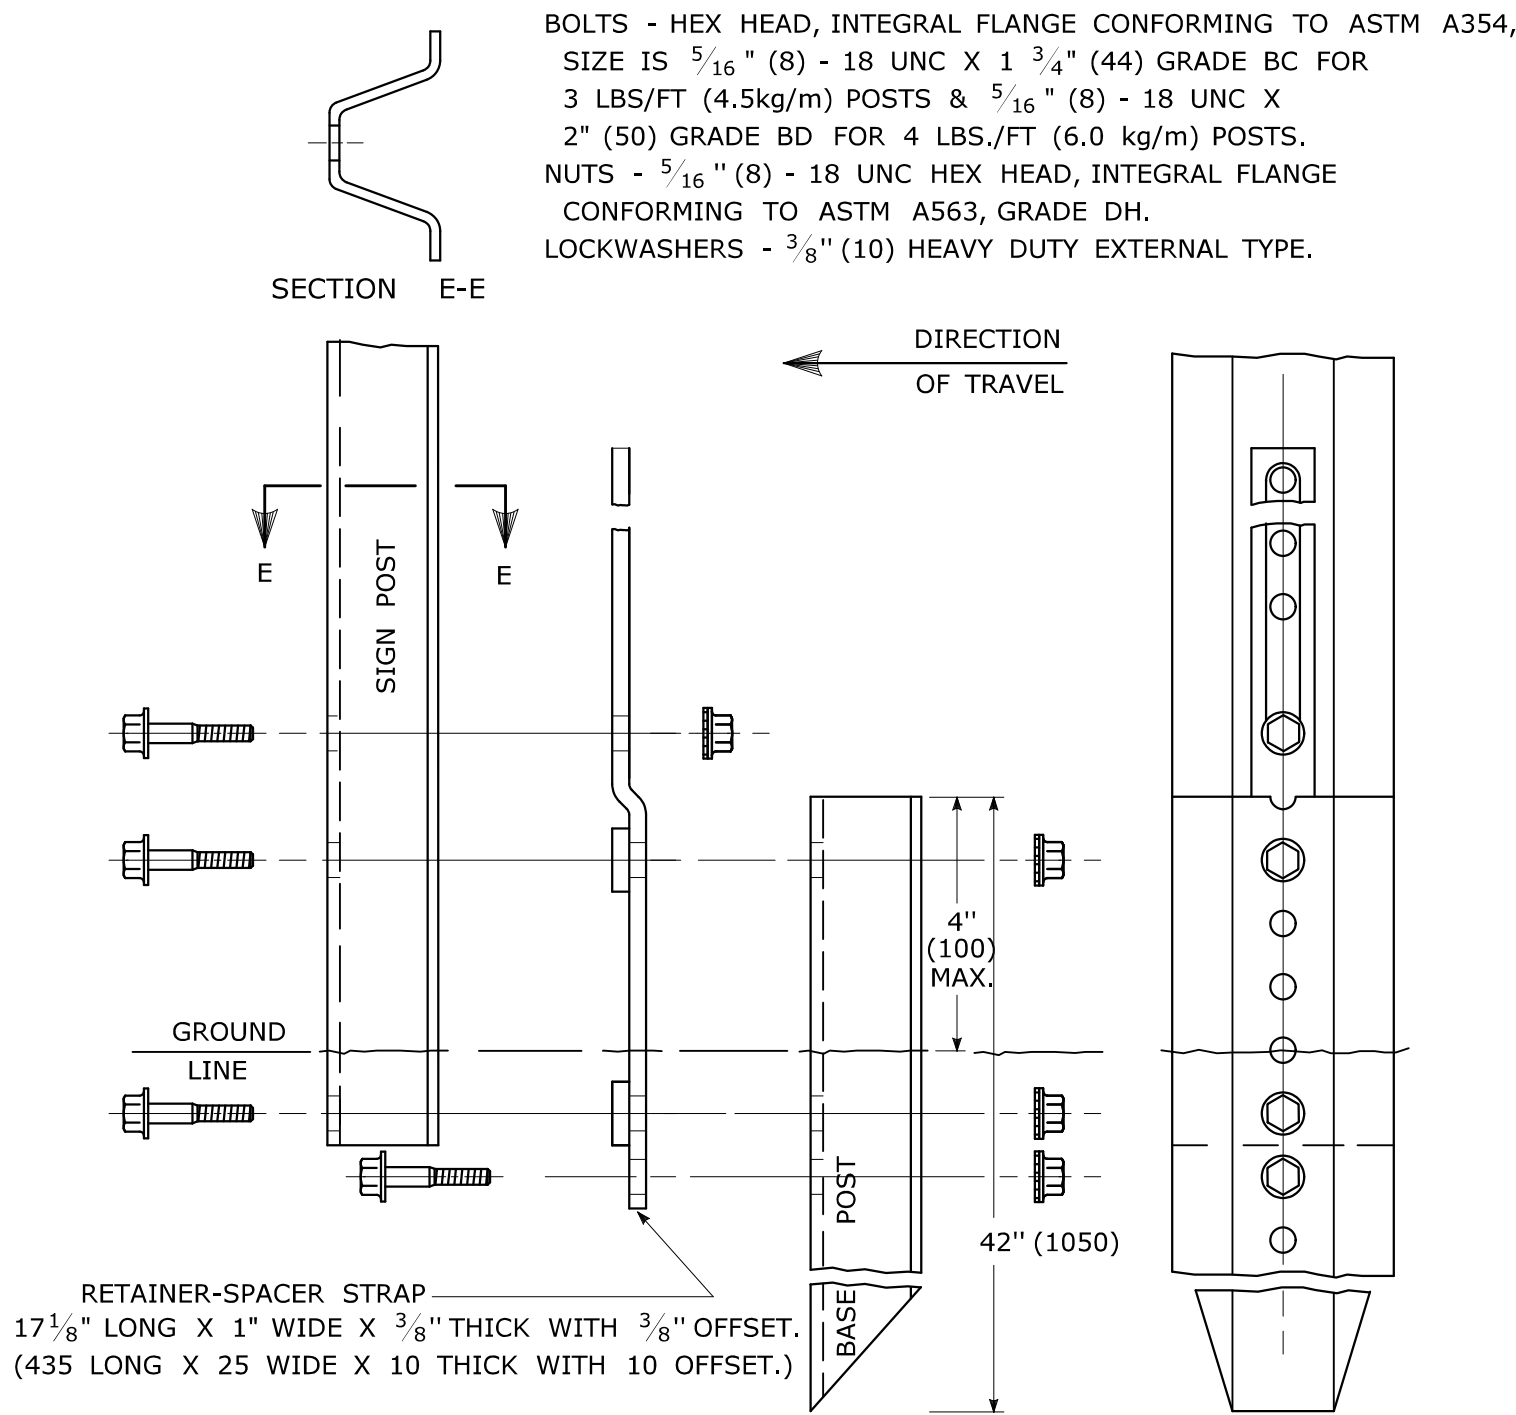FOR 3 & 4 LB. POSTS
(FOR 4.5 & 6.0 kg/m POSTS)




BREAKAWAY TYPE II INSTALLATION

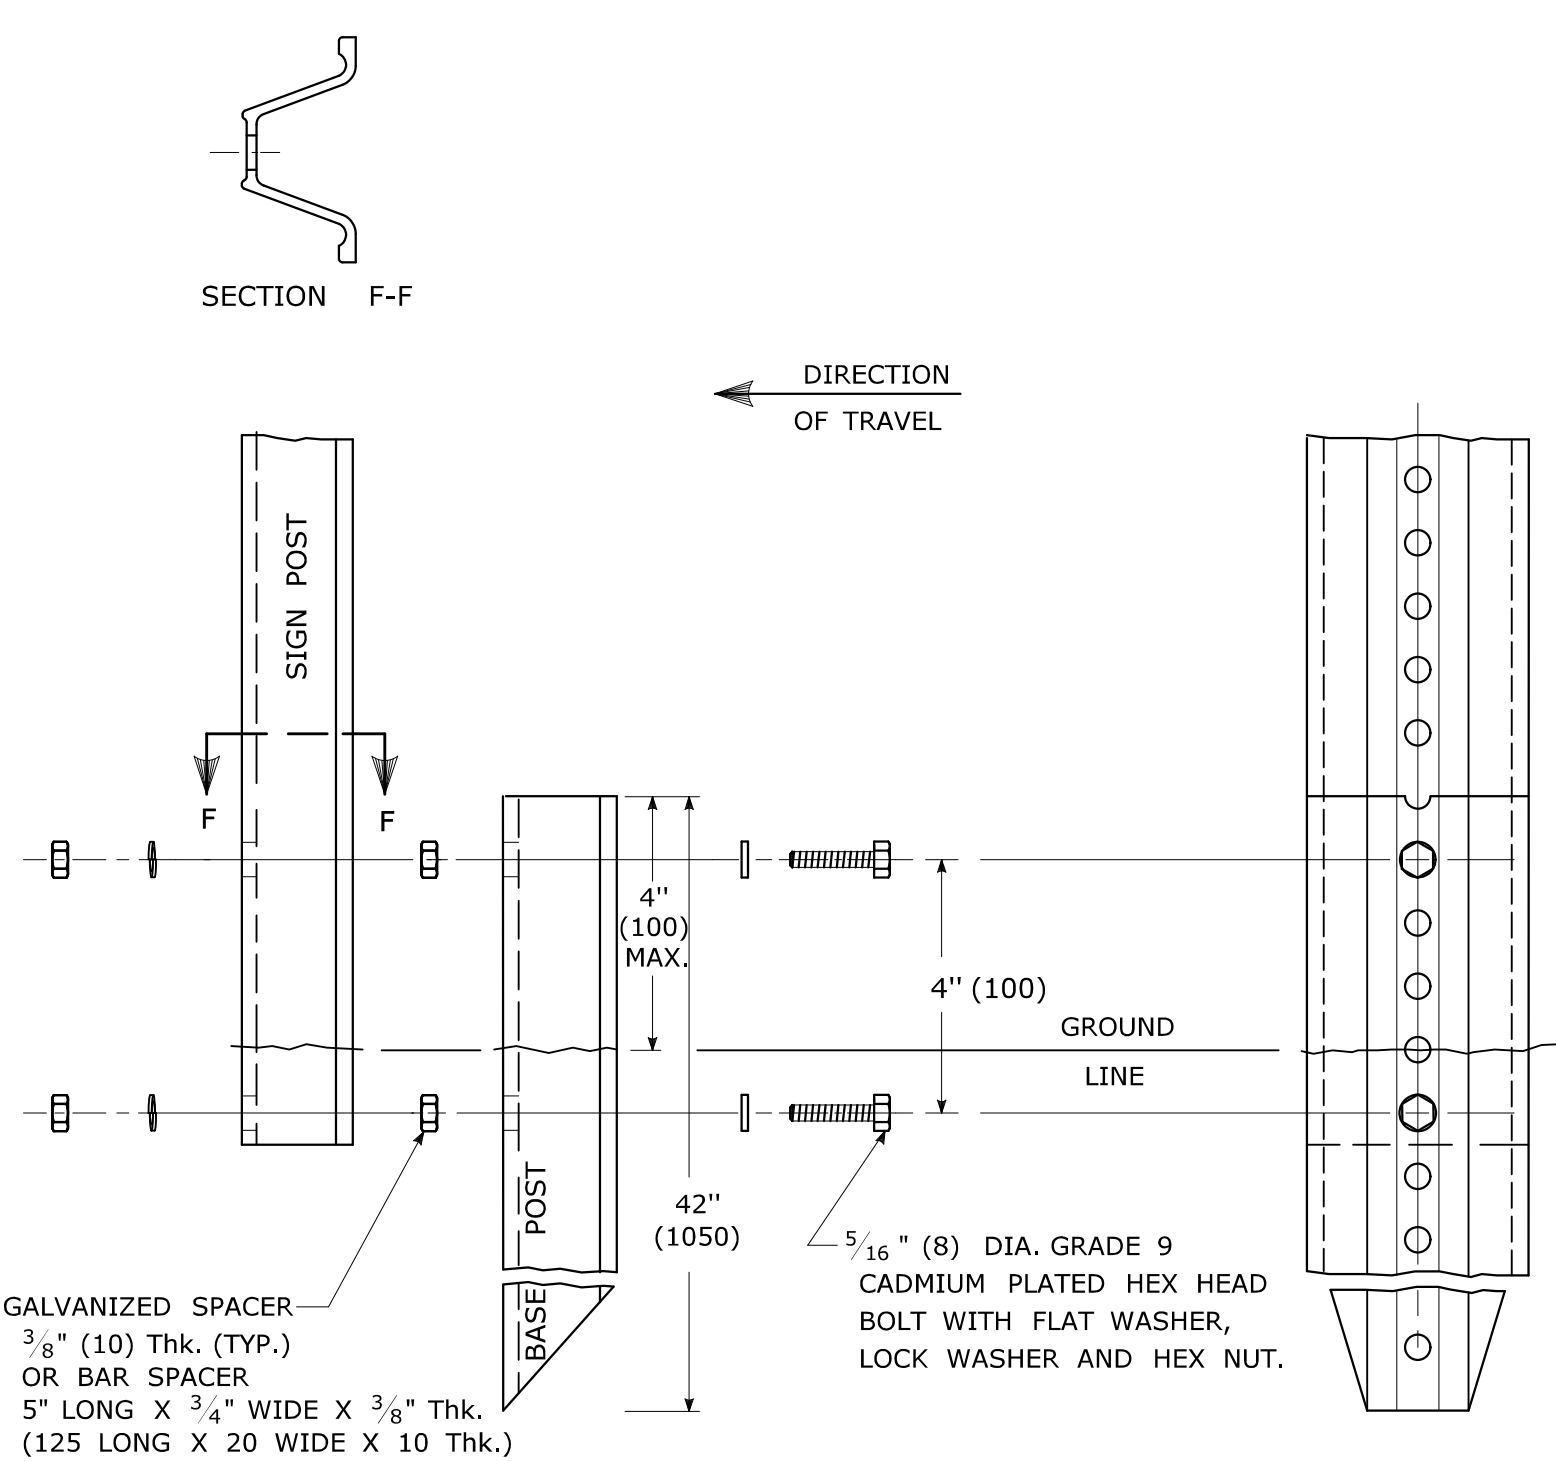
FOR 3 & 4 LB. POSTS
(FOR 4.5 & 6.0 kg/m POSTS)



TYPICAL SLEEVE FOR PAVED AREAS

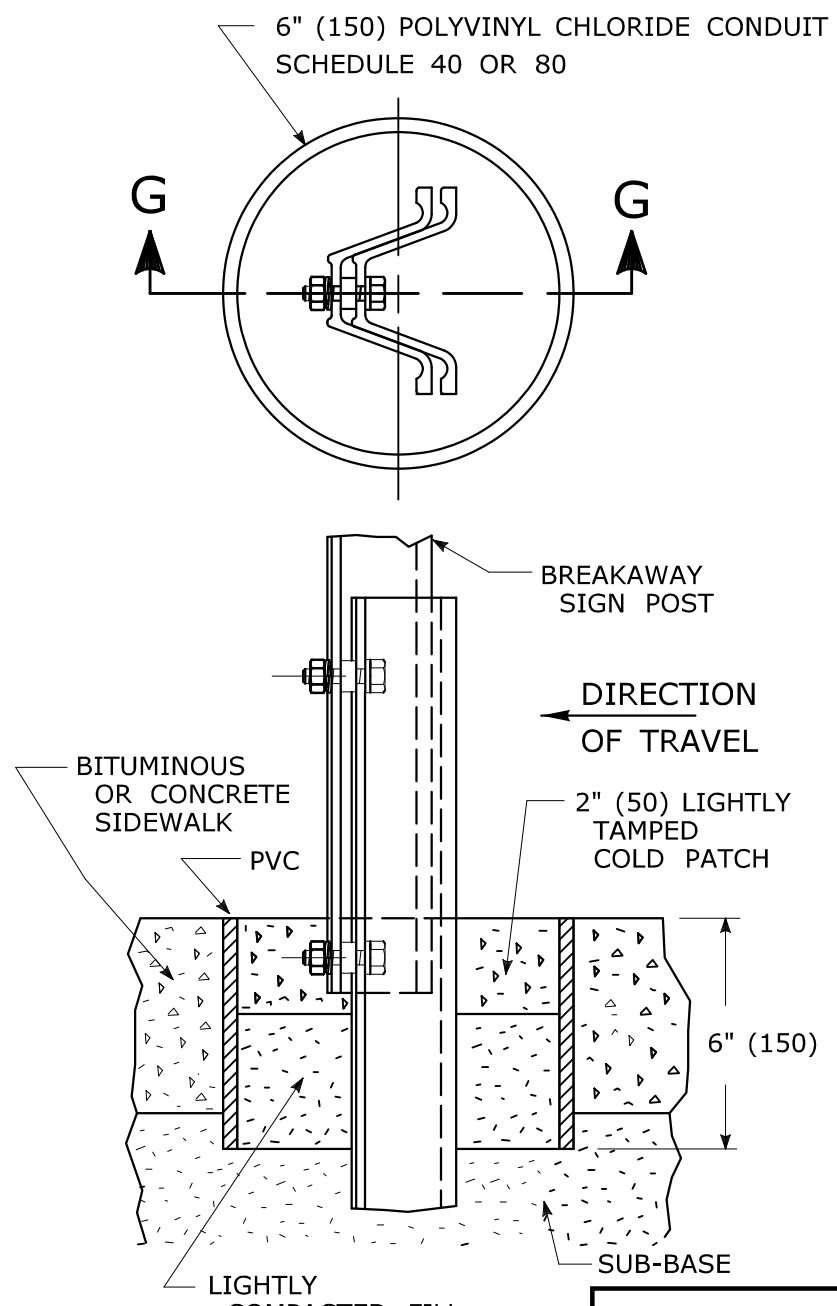

45° SUBMOUNTING BRACKET

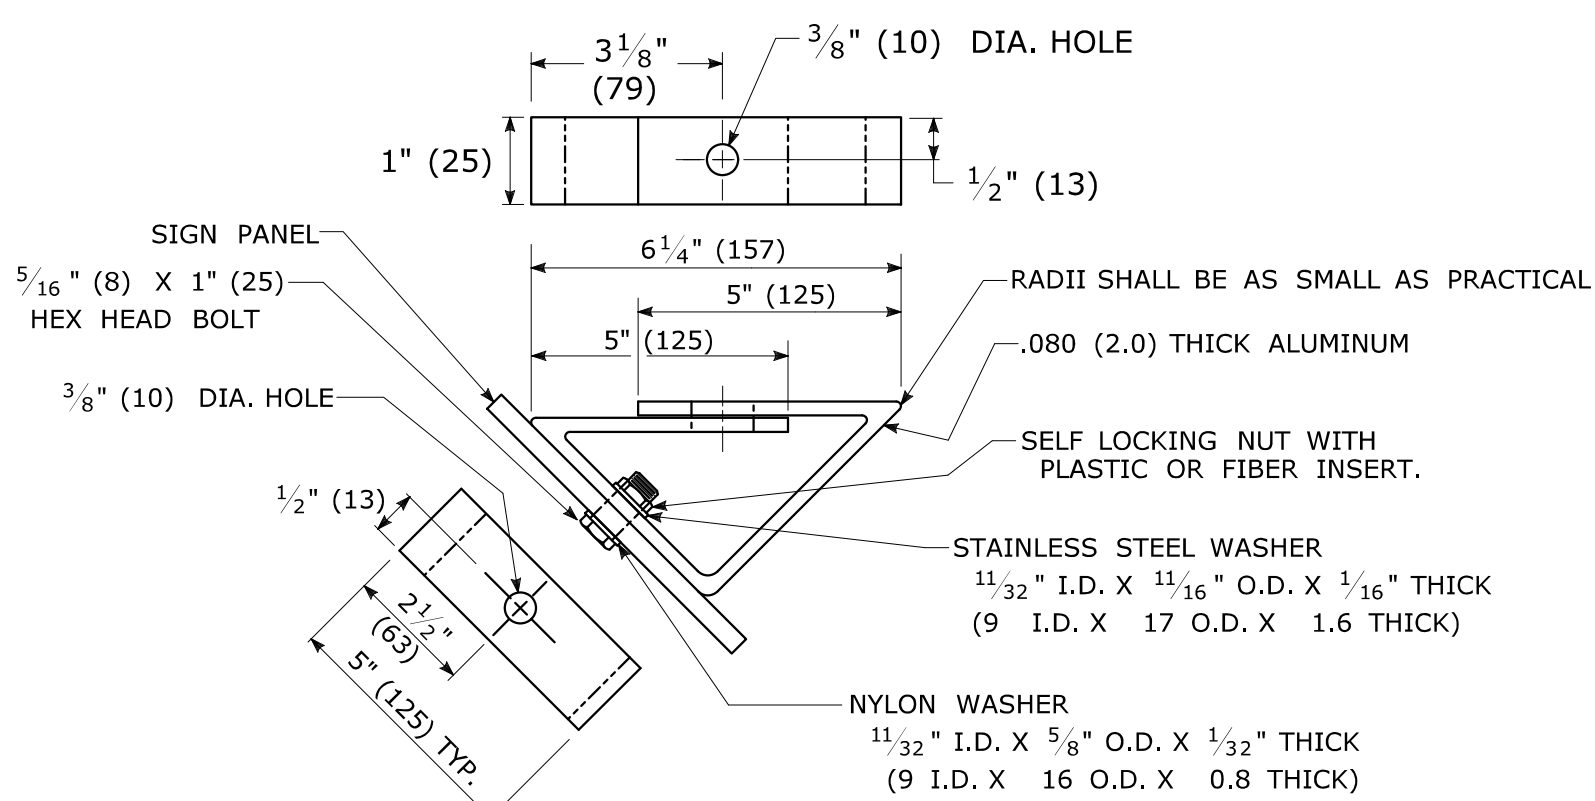

TOWN OF BROOKFIELD, CT

PROJECT NAME: TOWN DISTRICT SIDEWALK AND ACCESS MANAGEMENT PLAN

SHEET TITLE: METAL SIGN POSTS AND SIGN MOUNTING DETAILS

FILE NAME:

PROJECT LEADER: SM

DESIGNED BY: AG

PLOT DATE: 4/20/2016

DRAWN BY: AG







CHECKED BY: PG

DRAWING NO.: MDS-13

SHEET NO.: 19

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NOTES:

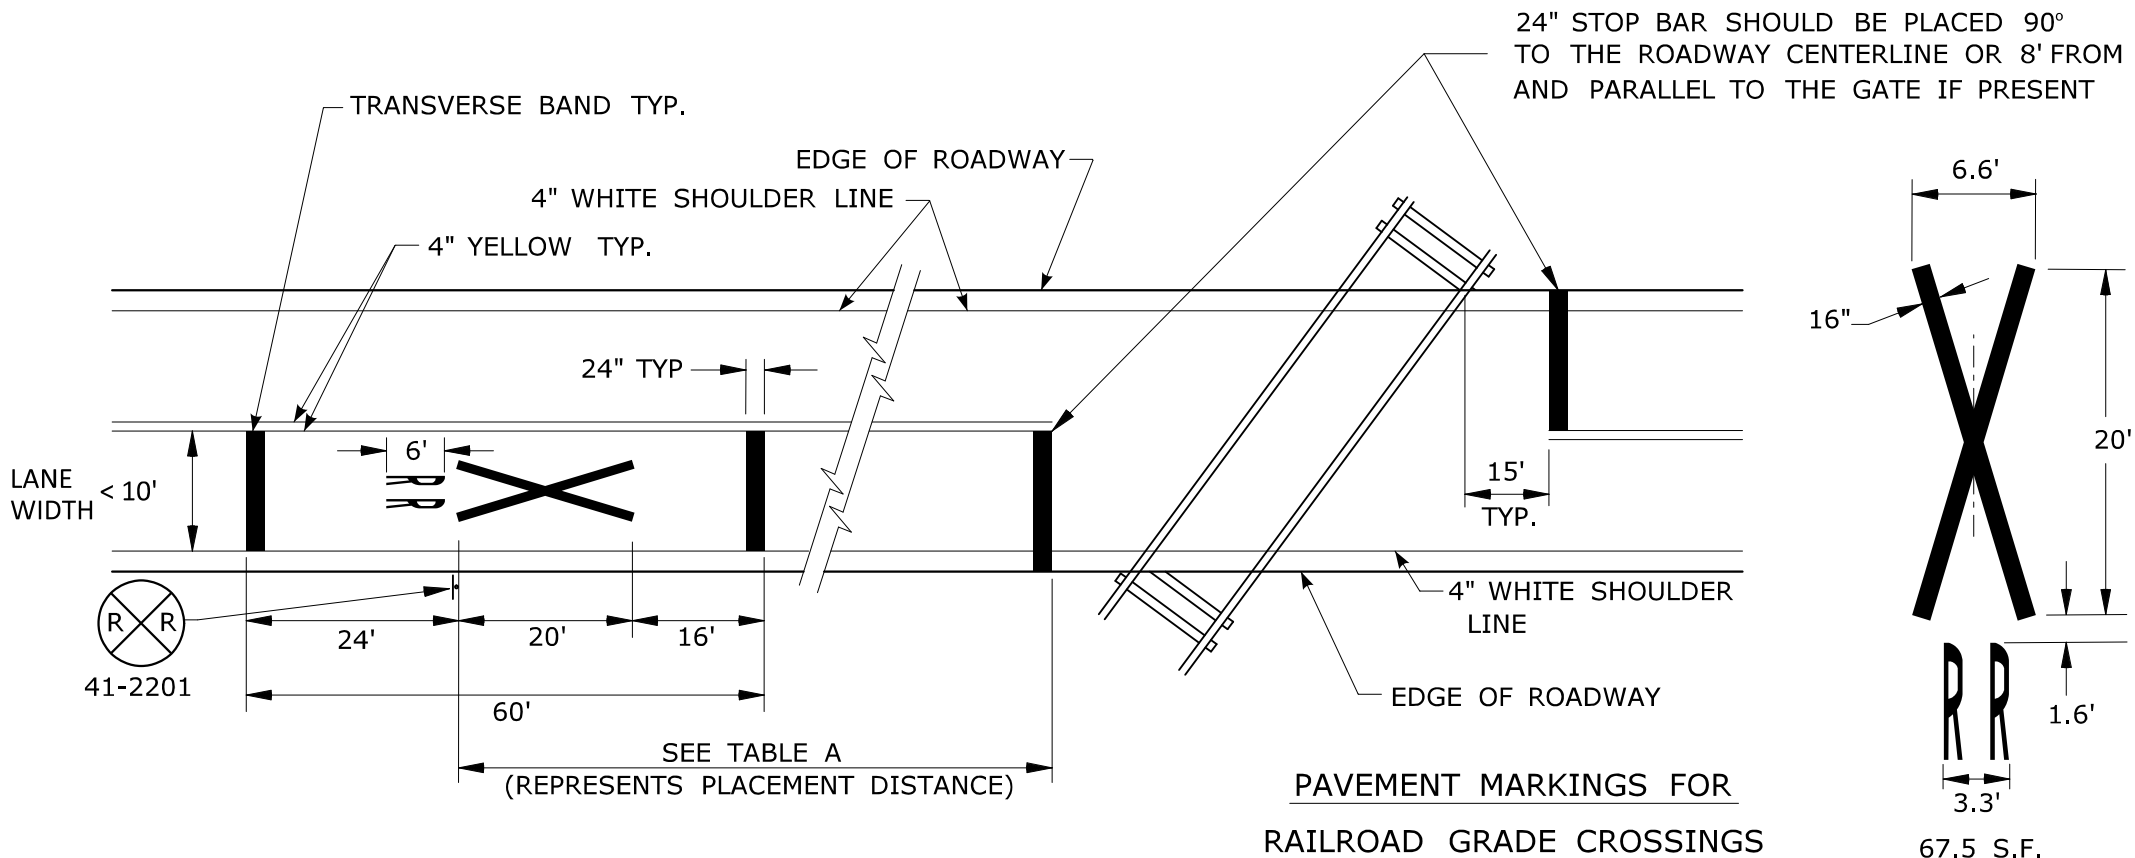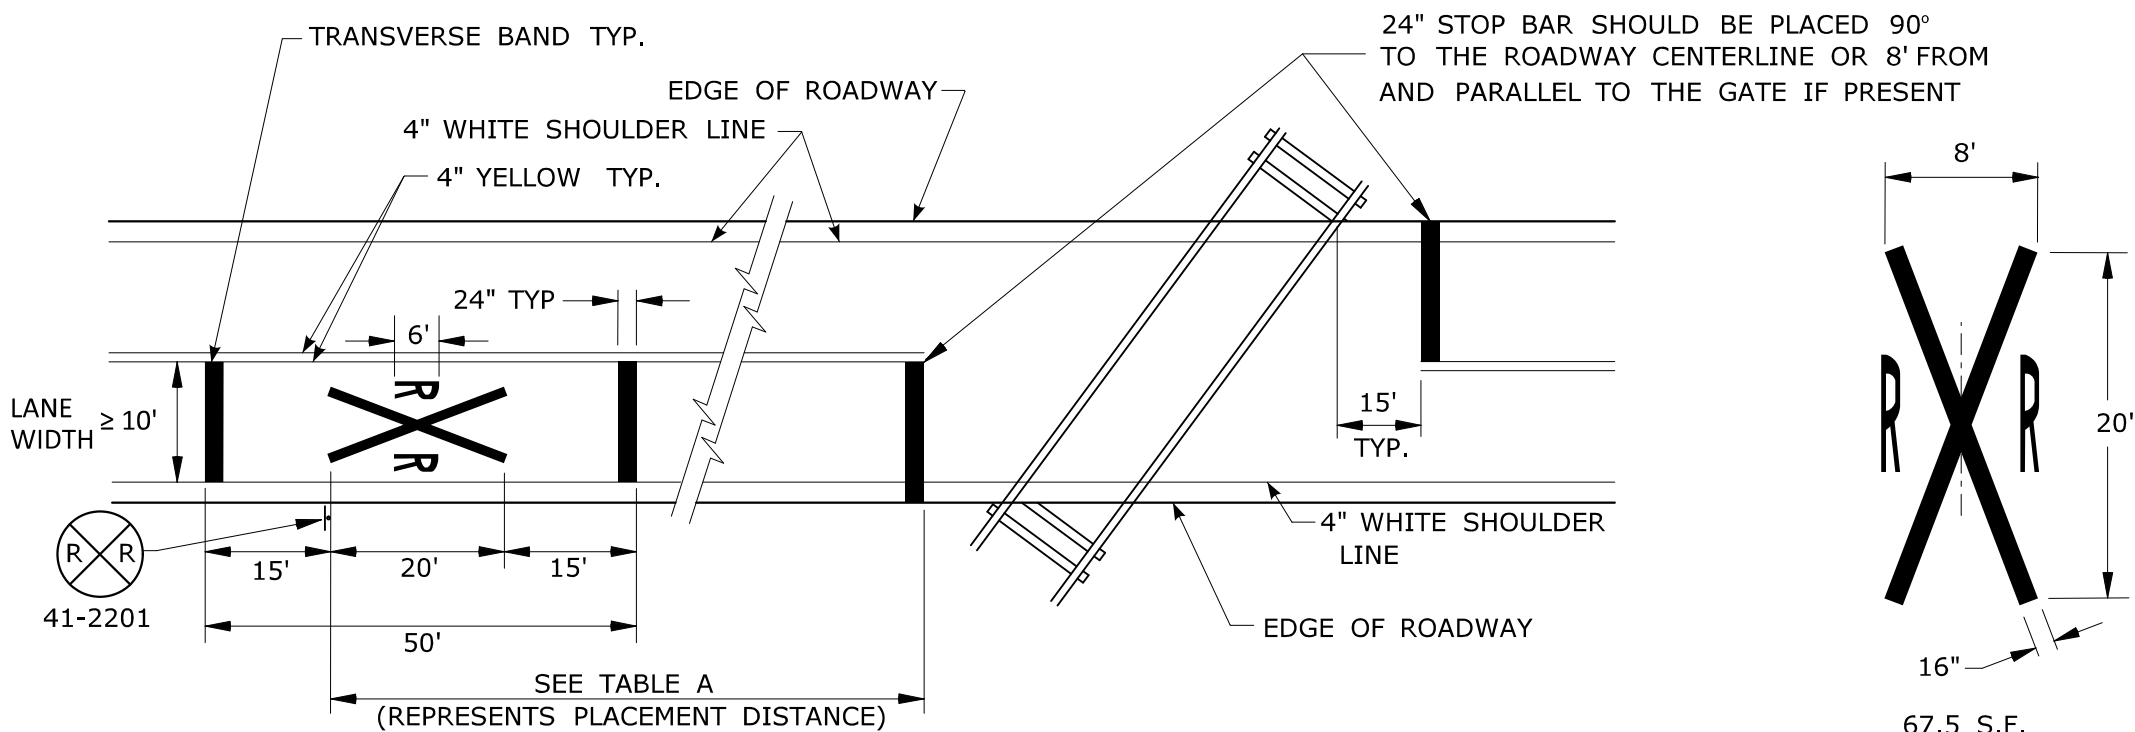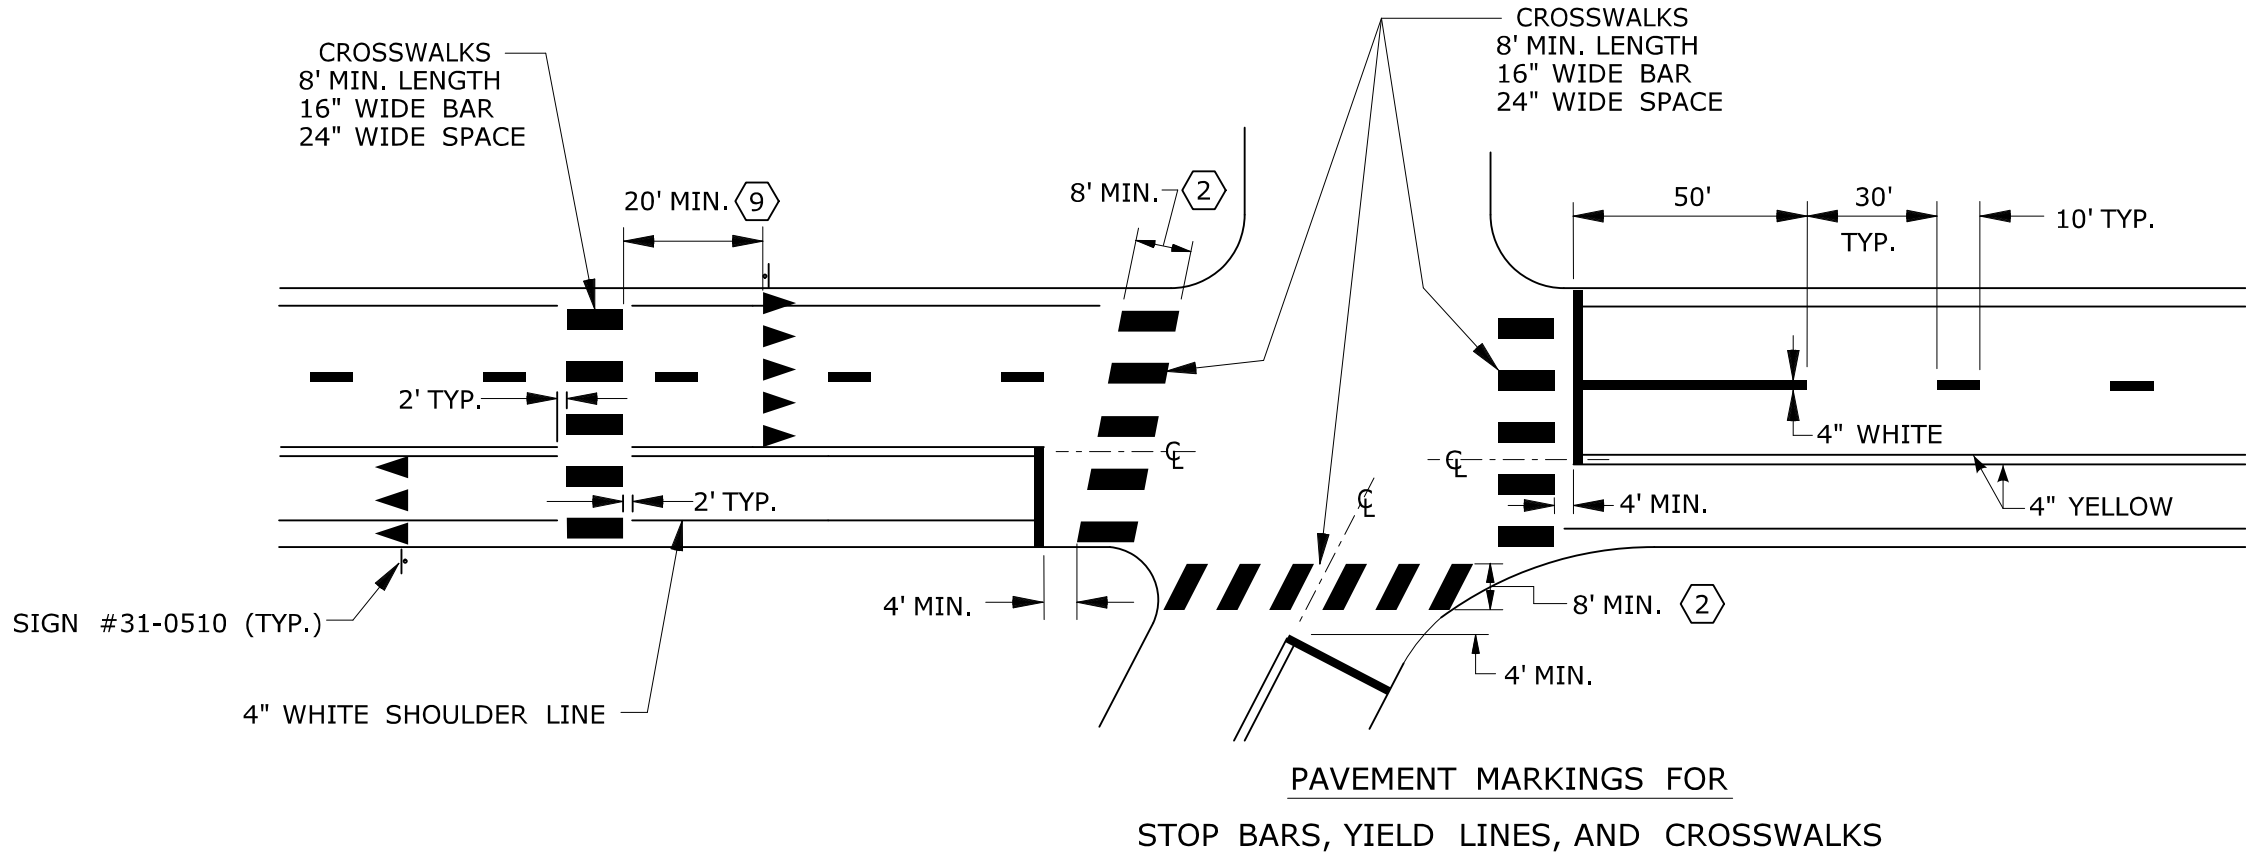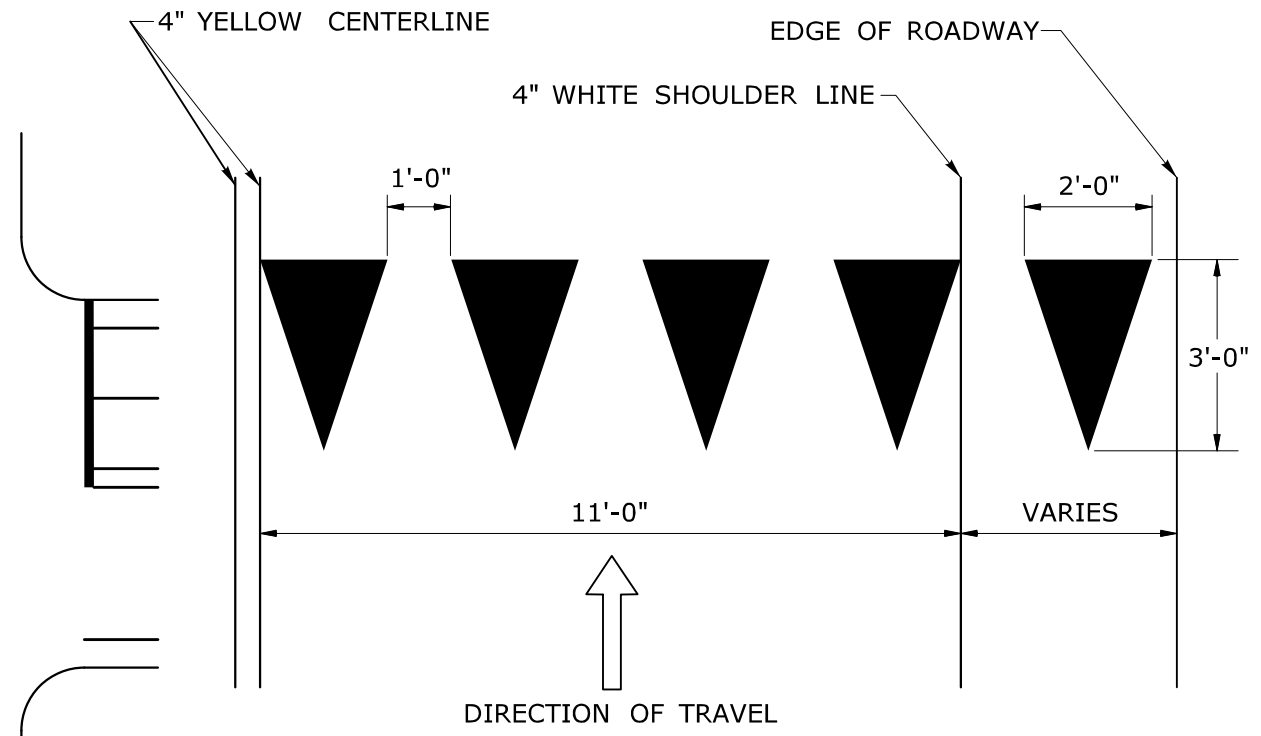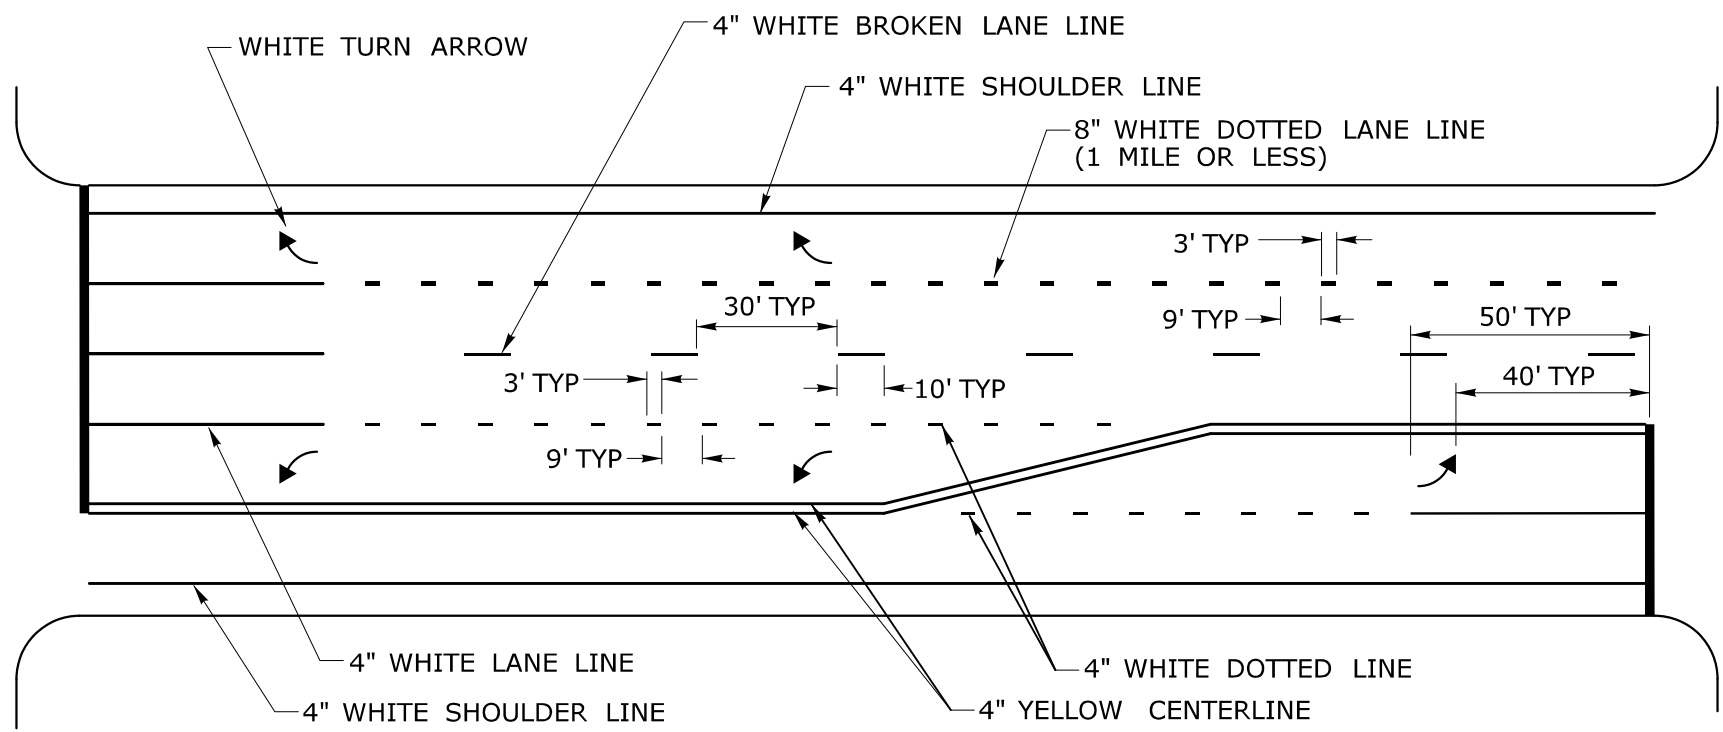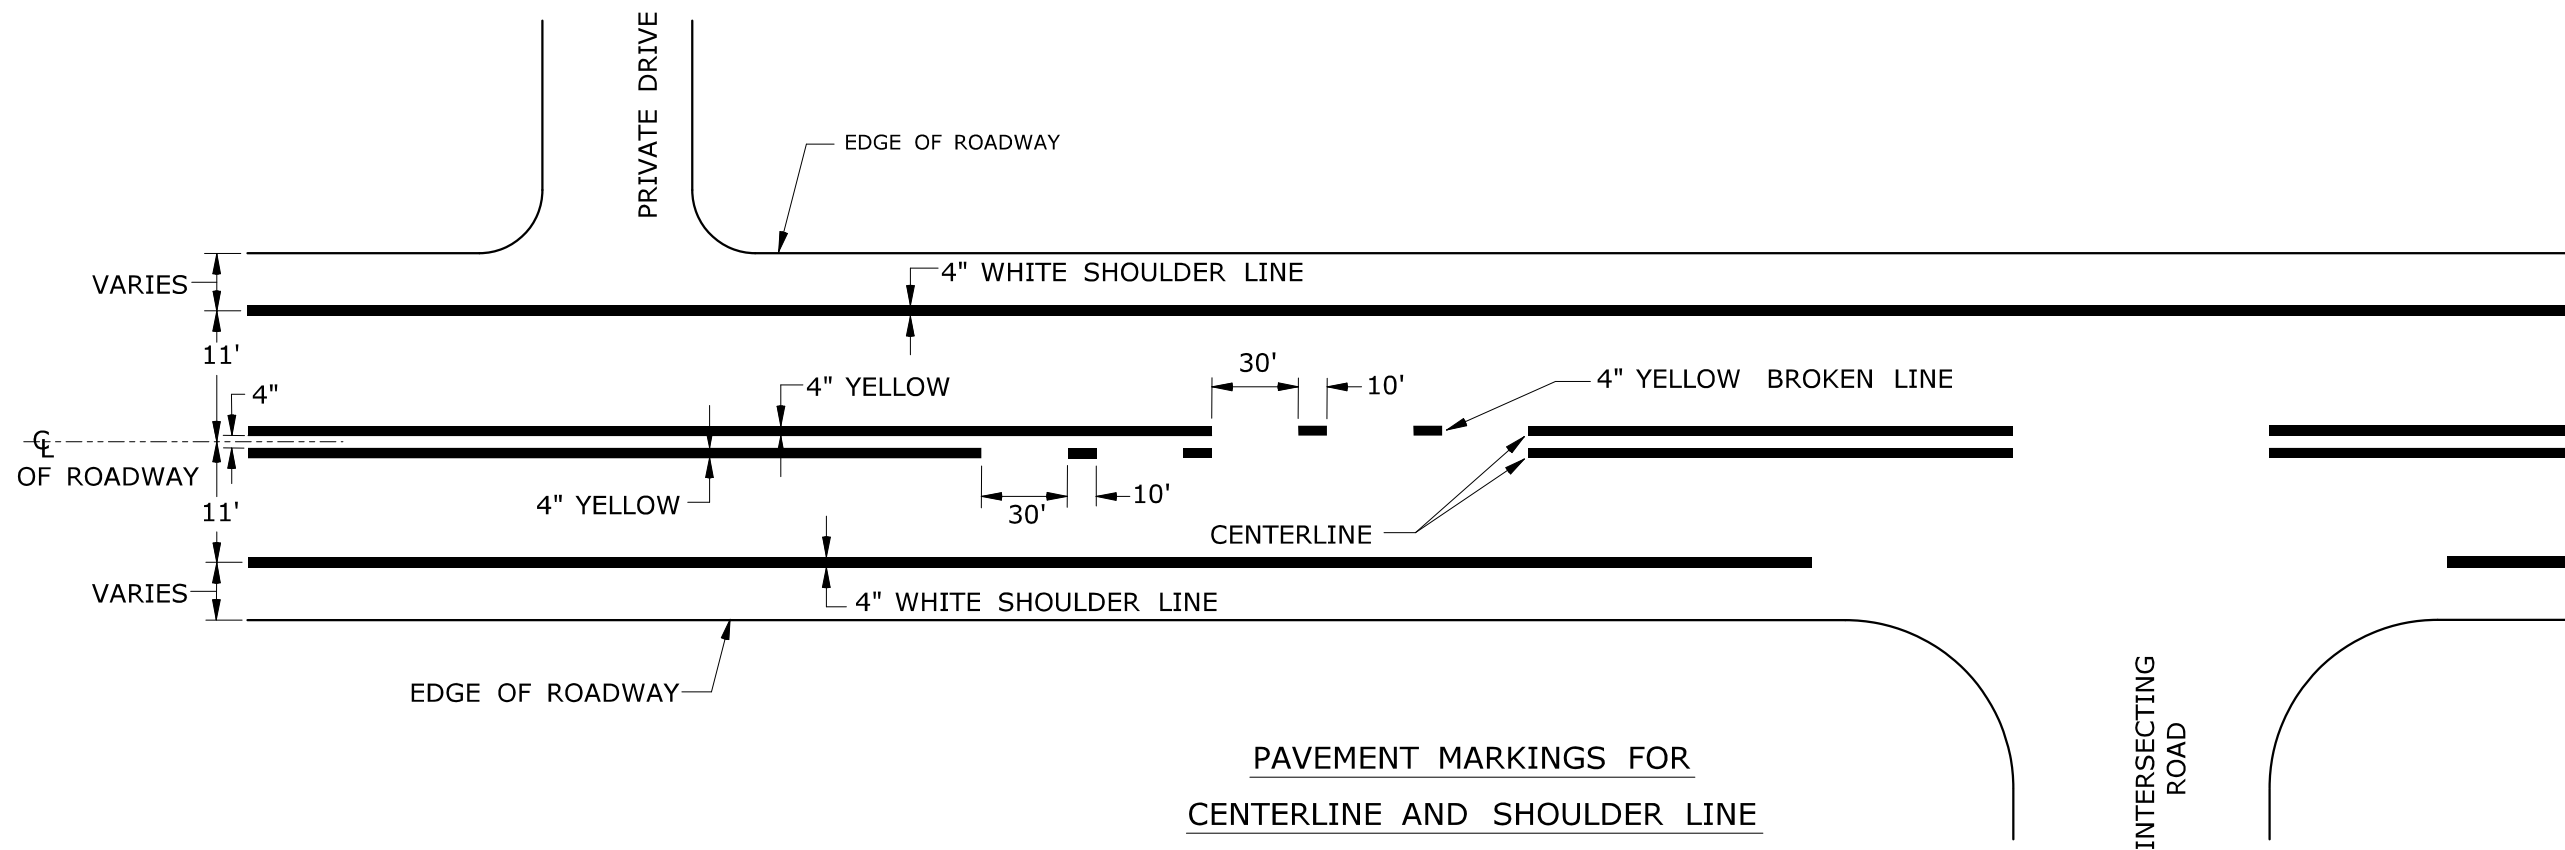- STOP BARS AND YIELD LINES SHALL BE WHITE.
- STOP BARS SHALL BE 12" MIN. UNLESS OTHERWISE NOTED ON PLANS.
- STOP BARS TO BE MARKED A MINIMUM OF 4' IN ADVANCE OF THE NEAREST EDGE OF CROSSWALK AND SHOULD BE PLACED 90° TO THE CENTERLINE OF THE ROADWAY.
- IN THE ABSENCE OF A MARKED CROSSWALK THE STOP BAR SHOULD BE PLACED 90° TO THE CENTERLINE OF THE ROADWAY, AT THE DESIRED STOPPING POINT AT LEAST 5' AND NO MORE THAN 30' FROM THE NEAREST EDGE OF THE INTERSECTING ROADWAY.
- THE STOP BAR SHOULD BE PLACED IN LINE WITH THE STOP SIGN. HOWEVER, IF THE STOP SIGN CANNOT BE LOCATED EXACTLY WHERE VEHICLES ARE EXPECTED TO STOP, THE STOP BAR SHOULD BE PLACED AT THE STOPPING POINT.
- FOR STOP BARS AT RAMP SEE DETAILS "O" & "P" AND NOTES ON TRAFFIC STANDARD SHEET TR-1210.02 "PAVEMENT MARKINGS FOR DIVIDED HIGHWAYS".
- YIELD LINES SHOULD BE INSTALLED FROM THE CENTERLINE TO THE CURB LINE/EDGE OF ROAD AND SHOULD BE PLACED 90° TO THE CENTERLINE OF THE ROADWAY.
- FOR YIELD LINE INSTALLATIONS, ONLY FULL TRIANGLES ARE TO BE INSTALLED.
- AT MID-BLOCK CROSSWALKS ONLY, YIELD LINES SHOULD BE INSTALLED 20 TO 50 FEET IN ADVANCE OF THE NEAREST CROSSWALK LINE, OR AS DIRECTED BY THE ENGINEER.
- THE YIELD LINE SHOULD BE PLACED IN LINE WITH A YIELD SIGN. HOWEVER, IF THE YIELD SIGN CANNOT BE LOCATED EXACTLY WHERE VEHICLES ARE EXPECTED TO YIELD, THE YIELD LINE SHOULD BE PLACED AT THE YIELDING POINT.

CROSSWALKS

- CROSSWALK MARKINGS SHALL BE WHITE.
- AT LOCATIONS WHERE THE CROSSWALK IS SKEWED, BARS TO BE PARALLEL TO CL AND ENDS OF BARS TO BE PARALLEL. THE LENGTH OF THE BARS WILL VARY DEPENDING ON THE ANGLE OF SKEW.
- BARS SHOULD BE NO CLOSER THAN 1' FROM CURB LINE/EDGE OF ROAD.
- ONLY FULL LENGTH BARS ARE TO BE INSTALLED.
- DECORATIVE CROSSWALKS SHALL BE BANDED FROM CURB TO CURB WITH A MINIMUM 12" WIDE WHITE TRANSVERSE LINE ALONG EACH EDGE.
- 24" WIDE SPACE TO BE CENTERED ON YELLOW CENTERLINE.

RAILROAD GRADE CROSSINGS

- RAILROAD MARKINGS SHALL BE WHITE.
- ON MULTI-LANE ROADS THE TRANSVERSE BANDS SHOULD EXTEND ACROSS THE APPROACH LANES AND INDIVIDUAL R X R SYMBOLS SHOULD BE USED IN EACH APPROACH LANE.



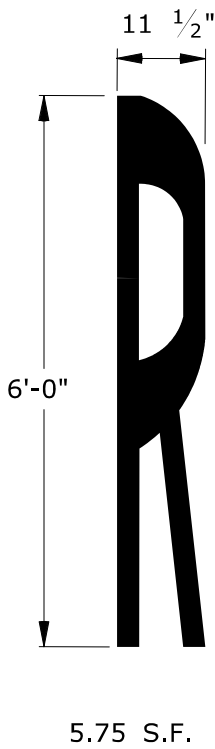
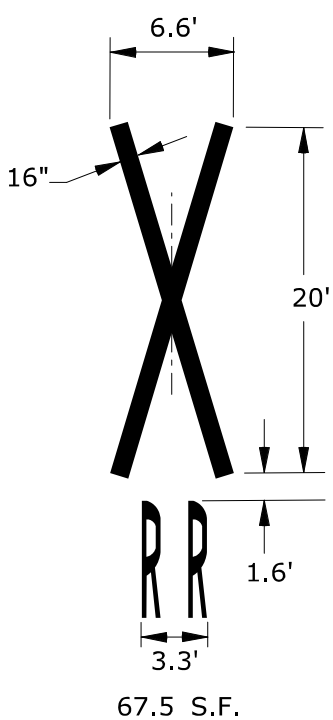
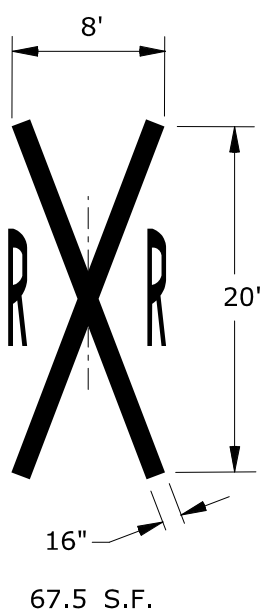
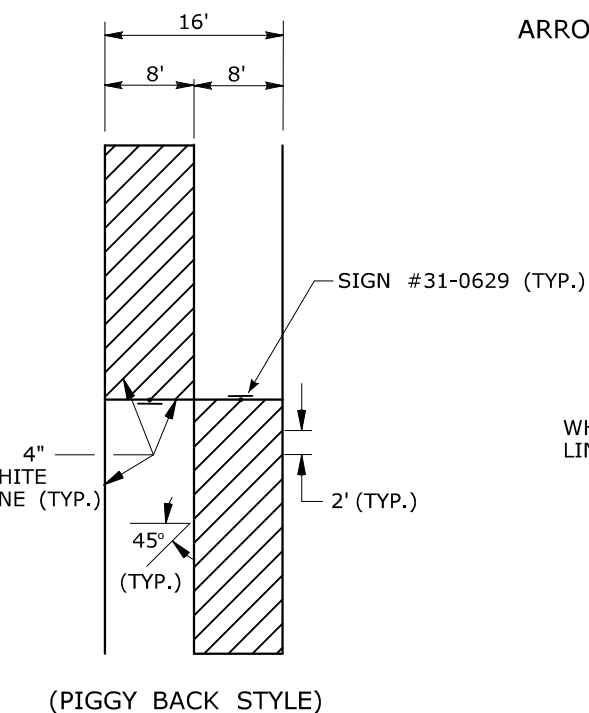


TABLE A	
POSTED OR 85 PERCENTILE SPEED M.P.H.	MINIMUM DISTANCE FT.
20	100
25	100
30	100
35	100
40	125
45	175
50	250
55	325
60	400
65	475

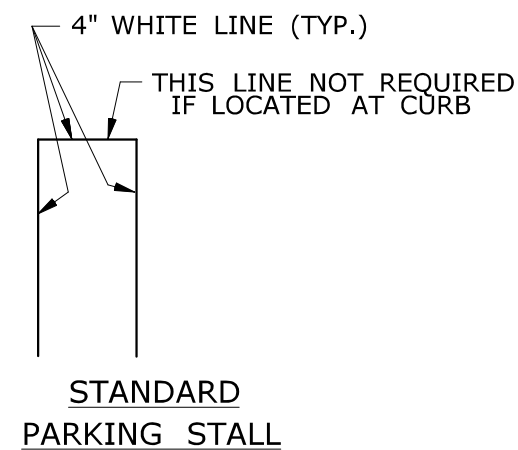

PAVEMENT ARROW DETAILS

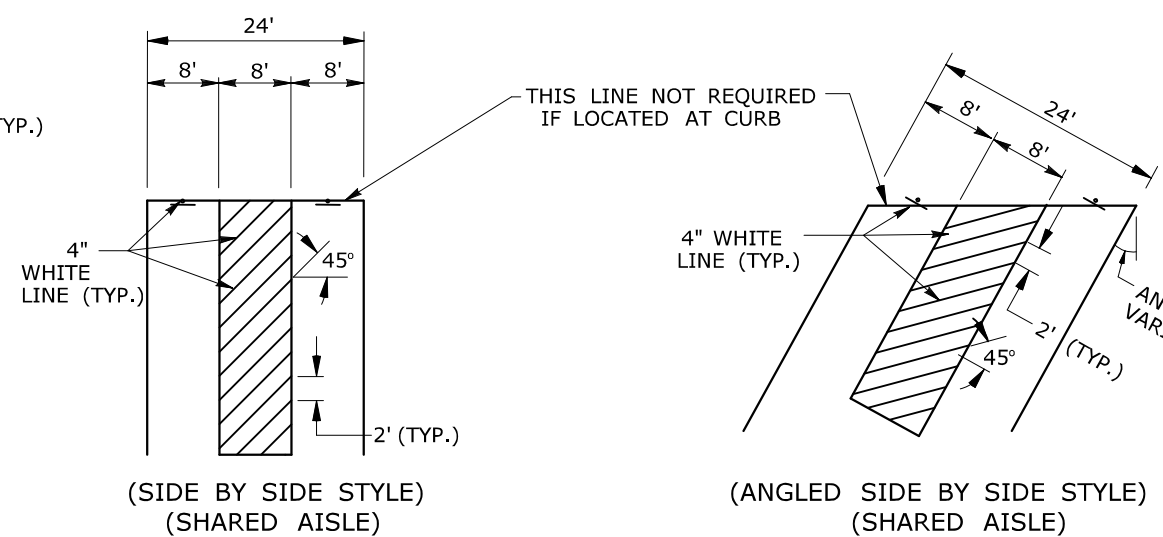(WHITE)
ARROWS SHALL BE CENTERED IN TRAVEL LANE



NOTES:

- FOR PAVEMENT MARKINGS ON A CLIMBING LANE SEE DETAIL "L" ON TRAFFIC STANDARD SHEET TR-1210.02 "PAVEMENT MARKINGS FOR DIVIDED HIGHWAYS".
- AREA OF PAVEMENT MARKINGS AS INDICATED IS APPROXIMATE.
- FOR PAVEMENT MARKING LINES, STOP BARS AND ARROWS AT RAMP SEE DETAILS "O" & "P" AND NOTES ON TRAFFIC STANDARD SHEET TR-1210.02 "PAVEMENT MARKINGS FOR DIVIDED HIGHWAYS".
- RIGHT TURN PAVEMENT MARKINGS ARROWS ARE MIRROR IMAGE OF LEFT TURN PAVEMENT MARKING ARROWS.
- SHARED AISLES MAY NOT BE USED WHERE CONNECTICUT BUILDING CODE GOVERNS.
- LANE WIDTHS TO BE 11' UNLESS OTHERWISE NOTED.

TOWN OF BROOKFIELD, CT

PROJECT NAME: **TOWN DISTRICT SIDEWALK AND ACCESS MANAGEMENT PLAN**

SHEET TITLE: SPECIAL DETAILS & TYPICAL PAVEMENT MARKINGS FOR TWO-WAY HIGHWAYS


URS CORPORATION
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(860) 529-8882

FILE NAME:
PROJECT LEADER: SM
DESIGNED BY: AG

PLOT DATE: 4/20/2016
DRAWN BY: AG
CHECKED BY: PG

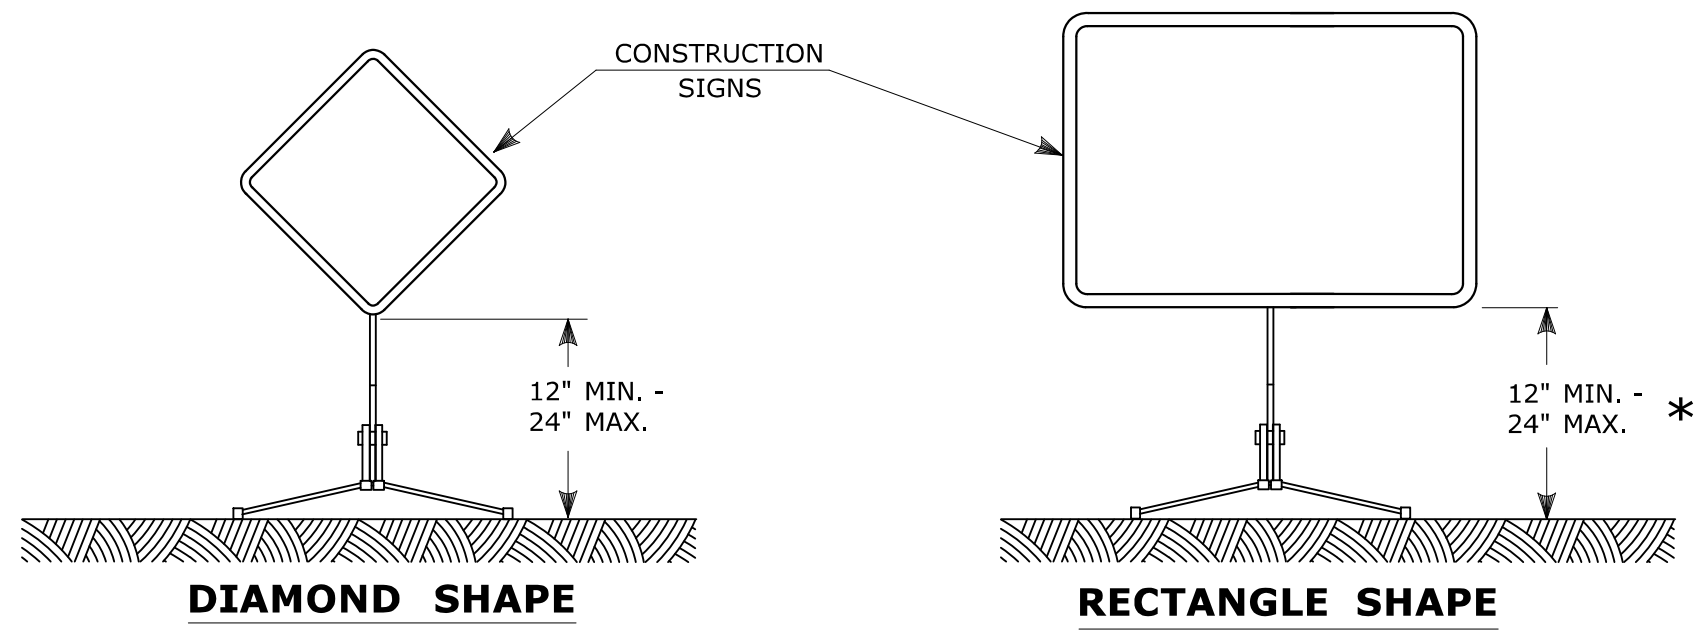DRAWING NO.:
MDS-14
SHEET NO.:
20

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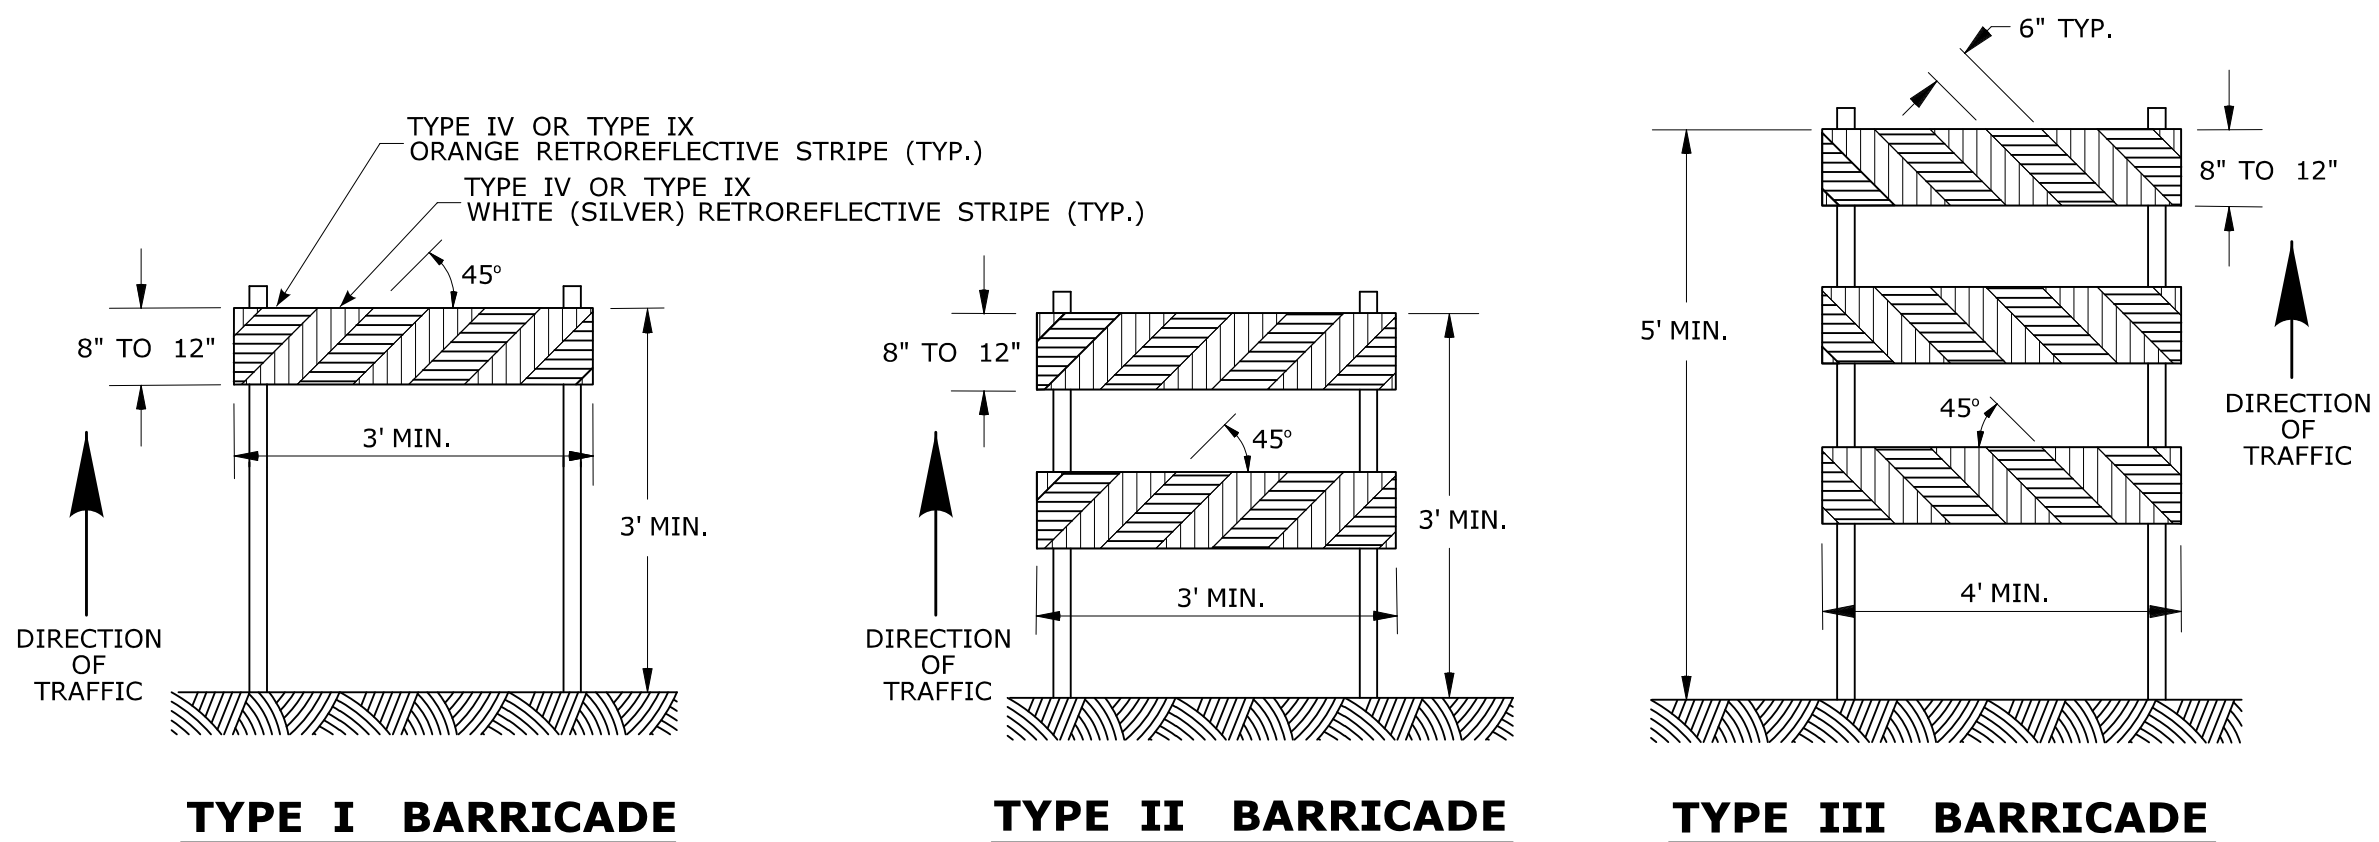


PORTABLE CONSTRUCTION SIGNS

NOTES FOR PORTABLE SIGN SUPPORTS:

- SIGNS AND THEIR PORTABLE SUPPORTS SHALL CONFORM TO THE REQUIREMENTS OF NCHRP REPORT 350 (TL-3) OR THE AASHTO MASH FOR CATEGORY 2 DEVICES AND THE LATEST EDITION OF THE MUTCD.
- MOUNTING HEIGHT OF SIGNS SHALL BE A MINIMUM OF 12" AND A MAXIMUM OF 24". SIGNS SHALL BE MOUNTED HIGHER AS NEEDED TO MEET FIELD CONDITIONS OR AS DIRECTED BY THE ENGINEER.
- THE ENGINEER RESERVES THE RIGHT TO REJECT ANY SUPPORT DEEMED UNSUITABLE FOR THE PURPOSE INTENDED.
- PORTABLE SIGN SUPPORTS SHALL BE STABILIZED IN A MANNER THAT WILL NOT AFFECT THEIR COMPLIANCE WITH NCHRP REPORT 350 (TL-3) OR THE AASHTO MASH FOR CATEGORY 2 DEVICES.
- PORTABLE CONSTRUCTION SIGN SUPPORTS SHOULD NOT BE USED FOR DURATION OF MORE THAN 3 DAYS EXCEPT FOR R9-8 THROUGH R9-11a SERIES, R11 SERIES, W1-6 THROUGH W1-8 SERIES, M4-10, AND E5-1. SEE STANDARD SHEET TR-1220.01 - "SIGNS FOR CONSTRUCTION AND PERMIT OPERATIONS" FOR SIGN DETAILS.

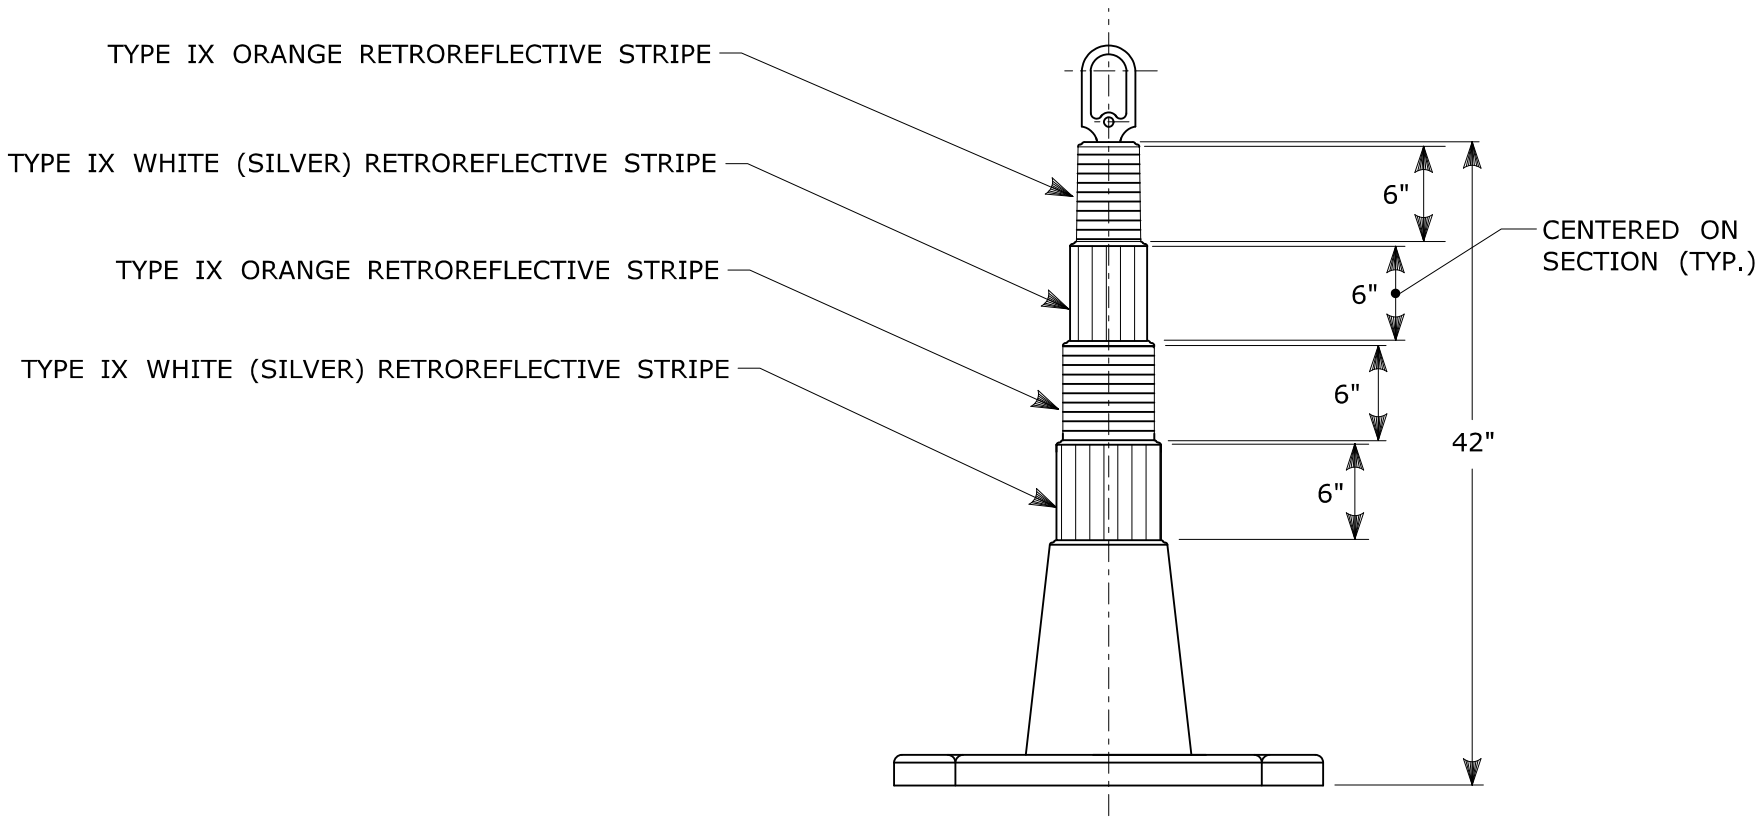
✱ FOR E5-1 (EXIT SIGNS) USE MIN 48".



CONSTRUCTION BARRICADES

NOTES:


- CONSTRUCTION BARRICADES SHALL CONFORM TO THE REQUIREMENTS OF NCHRP REPORT 350 (TL-3) OR THE AASHTO MASH AND THE LATEST EDITION OF THE MUTCD.
- MARKINGS FOR BARRICADE RAILS SHALL BE ALTERNATE ORANGE AND WHITE STRIPES SLOPING DOWNWARD IN THE DIRECTION TRAFFIC IS TO PASS. 6" WIDE STRIPES SHALL BE USED.
- THE ENTIRE AREA OF ORANGE AND WHITE STRIPES SHALL BE RETROREFLECTIVE SHEETING AS REQUIRED IN THE SPECIFICATIONS. THE SIDES OF BARRICADES FACING TRAFFIC SHALL HAVE RETROREFLECTIVE RAIL FACES.
- THE ENGINEER RESERVES THE RIGHT TO REJECT ANY BARRICADE DEEMED UNSUITABLE FOR THE PURPOSE INTENDED.
- CORNERS OF BARRICADE RAILS SHALL BE ROUNDED.
- SIGNS MAY ONLY BE INSTALLED ON TYPE III BARRICADES AND SHALL BE PLACED SO AS TO COVER NO MORE THAN ONE BARRICADE RAIL.



42" TRAFFIC CONE

NOTES:

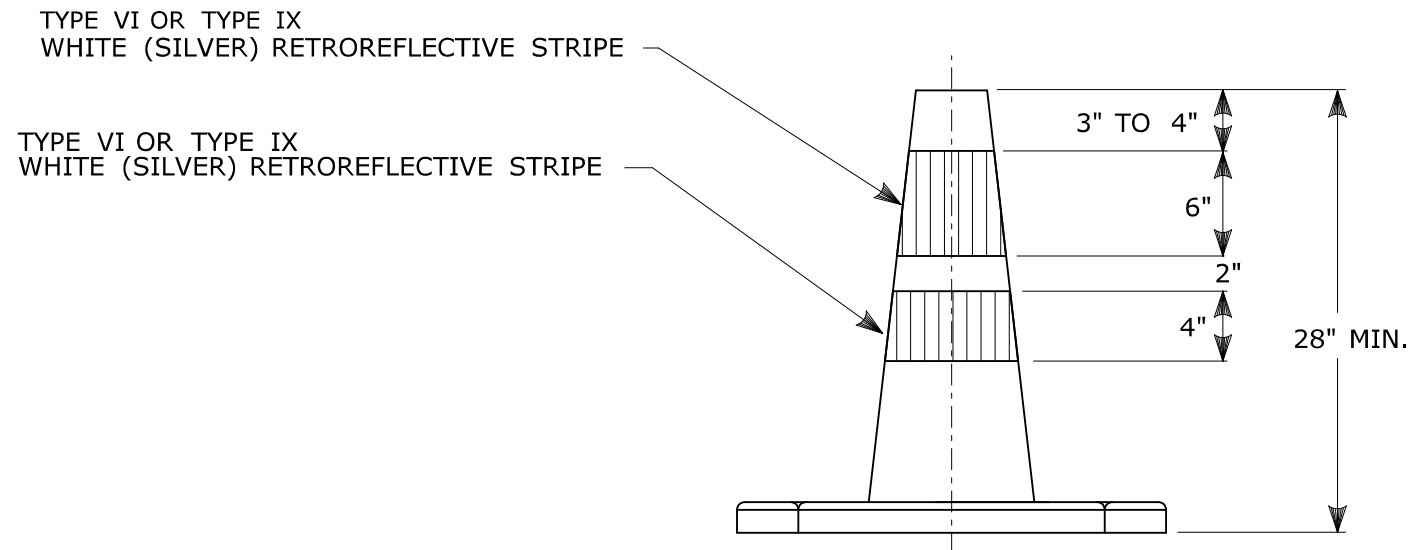
- TRAFFIC CONES SHALL CONFORM TO THE REQUIREMENTS OF NCHRP REPORT 350 (TL-3) OR THE AASHTO MASH FOR CATEGORY 1 DEVICES AND THE LATEST EDITION OF THE MUTCD.
- IF RUBBER CONES ARE USED, THEY SHALL HAVE INTERIOR RIBS FOR RIGIDITY.
- IF PLASTIC CONES ARE USED, THEY SHALL BE COLOR IMPREGNATED.
- THE ENGINEER RESERVES THE RIGHT TO REJECT ANY CONE DEEMED UNSUITABLE FOR THE PURPOSE INTENDED.
- THE ENTIRE AREA OF ORANGE AND WHITE STRIPES SHALL BE RETROREFLECTIVE SHEETING AS REQUIRED IN THE SPECIFICATIONS.
- THE SECTIONS OF CONES NOT COVERED WITH RETROREFLECTIVE STRIPES SHALL BE ORANGE.



TRAFFIC CONE

NOTES:

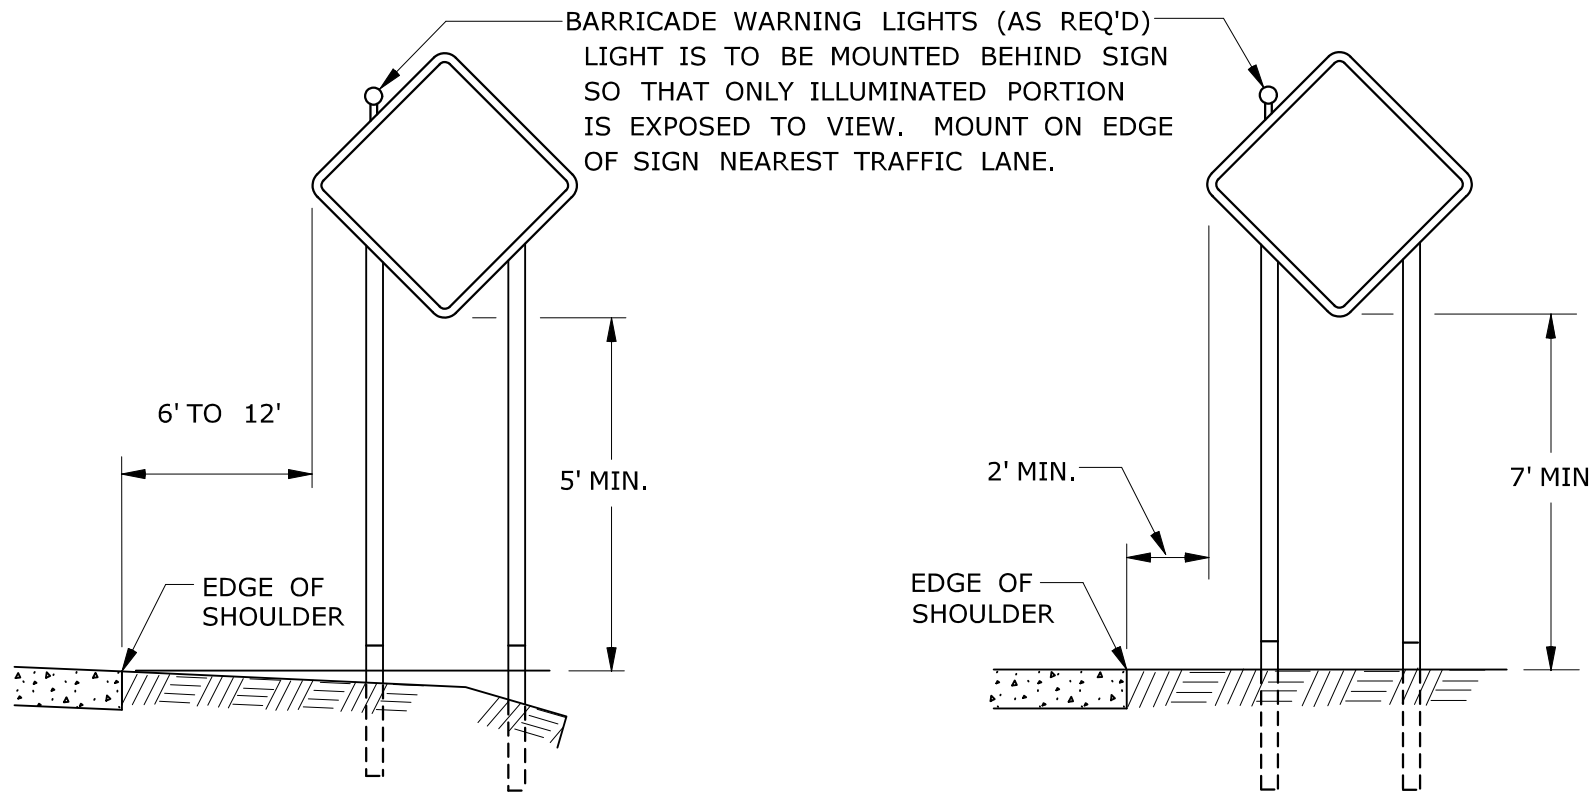- TRAFFIC CONES SHALL CONFORM TO THE REQUIREMENTS OF NCHRP REPORT 350 (TL-3) OR THE AASHTO MASH FOR CATEGORY 1 DEVICES AND THE LATEST EDITION OF THE MUTCD.
- IF RUBBER CONES ARE USED, THEY SHALL HAVE INTERIOR RIBS FOR RIGIDITY.
- IF PLASTIC CONES ARE USED, THEY SHALL BE COLOR IMPREGNATED.
- THE ENGINEER RESERVES THE RIGHT TO REJECT ANY CONE DEEMED UNSUITABLE FOR THE PURPOSE INTENDED.
- TRAFFIC CONES NOT USED AT NIGHT MAY UTILIZE TYPE III SHEETING.
- THE SECTIONS OF CONES NOT COVERED WITH RETROREFLECTIVE STRIPES SHALL BE ORANGE.




RURAL AREA

URBAN AREA

**PLACEMENT OF CONSTRUCTION SIGNS
TYPICAL LONG TERM INSTALLATION**

NOTES:

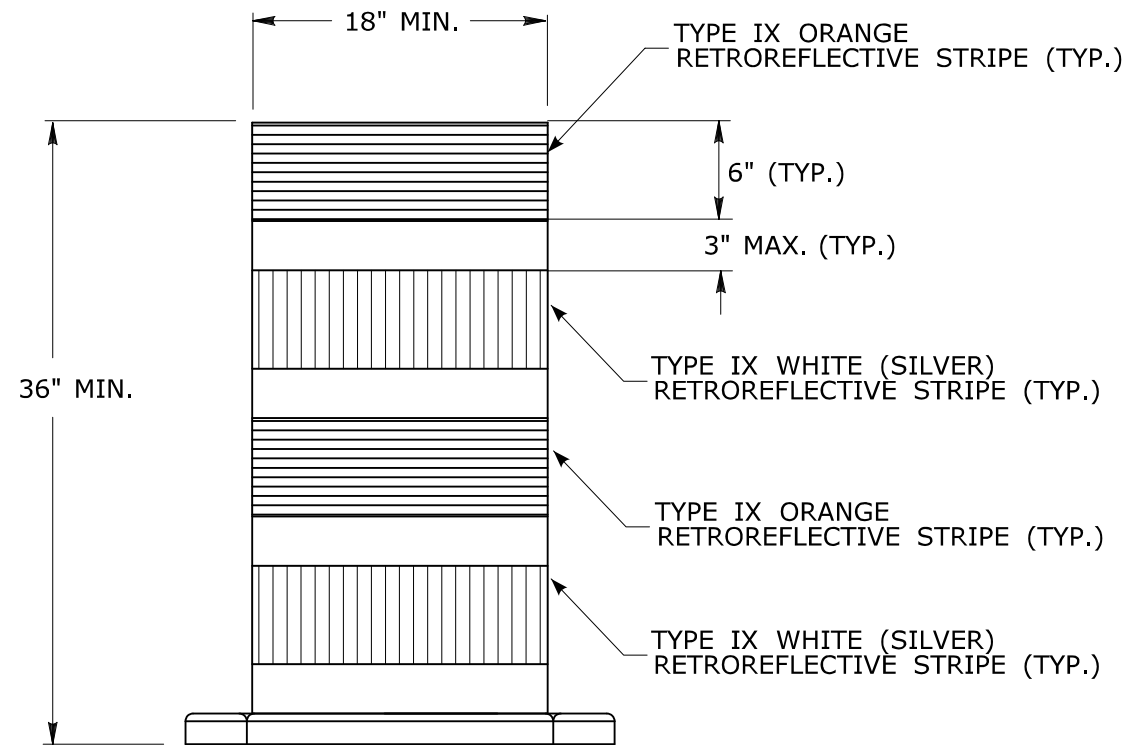- SUPPORTS SHALL BE METAL SIGN POSTS AND HAVE BREAK-AWAY FEATURES.
- SEE TYPICAL SHEETS:
"TYPICAL SIGN SUPPORT AND SIGN PLACEMENT DETAILS-GORE EXIT SIGN"
"TYPICAL METAL SIGN POSTS AND SIGN MOUNTING DETAILS"



**TRAFFIC DRUM
FRONT VIEW**

NOTES:

- TRAFFIC DRUM SHALL CONFORM TO THE REQUIREMENTS OF NCHRP REPORT 350 (TL-3) OR THE AASHTO MASH FOR CATEGORY 1 DEVICES AND THE LATEST EDITION OF THE MUTCD.
- THE ENGINEER RESERVES THE RIGHT TO REJECT ANY DRUM DEEMED UNSUITABLE FOR THE PURPOSE INTENDED.
- THE ENTIRE AREA OF ORANGE AND WHITE STRIPES SHALL BE RETROREFLECTIVE SHEETING AS REQUIRED IN THE SPECIFICATIONS.
- THE SECTIONS OF DRUMS NOT COVERED WITH RETROREFLECTIVE STRIPES SHALL BE ORANGE.

TOWN OF BROOKFIELD, CT

PROJECT NAME: TOWN DISTRICT SIDEWALK AND ACCESS MANAGEMENT PLAN			
SHEET TITLE: CONSTRUCTION SIGN SUPPORTS AND CHANNELIZING DEVICES			
URS CORPORATION 500 ENTERPRISE DRIVE, SUITE 3B ROCKY HILL, CT 06067 (860) 529-8882	FILE NAME:	PLOT DATE: 4/20/2016	DRAWING NO.: MDS-16
	PROJECT LEADER: SM DESIGNED BY: AG	DRAWN BY: AG CHECKED BY: PG	SHEET NO.: 22

R1 - SERIES										R2 - SERIES										R3 - SERIES																				R4 - SERIES										R5 - SERIES																																																																																																																																																																																																																											
<div>R1-1</div> <div>*</div> <div></div> <div>LEGEND - WHITE BACKGROUND - RED</div> <table><tr><th>AREA (SQ. FT)</th><th>SIZE (INCHES)</th><th>CONN. D.O.T. #</th><th>POSTS</th><th>ALUM. THK.</th></tr><tr><td>3.31</td><td>24</td><td>31-0536</td><td>1</td><td>.080</td></tr><tr><td>5.19</td><td>30</td><td>31-0552</td><td>1</td><td>.080</td></tr><tr><td>7.98</td><td>36</td><td>31-0553</td><td>1</td><td>.080</td></tr><tr><td>13.3</td><td>48</td><td>31-0557</td><td>2</td><td>.100</td></tr></table>										AREA (SQ. FT)	SIZE (INCHES)	CONN. D.O.T. #	POSTS	ALUM. THK.	3.31	24	31-0536	1	.080	5.19	30	31-0552	1	.080	7.98	36	31-0553	1	.080	13.3	48	31-0557	2	.100	<div>R2-1</div> <div></div> <table><tr><th>AREA (SQ. FT)</th><th>SIZE (INCHES)</th><th>CONN. D.O.T. #</th><th>POSTS</th><th>ALUM. THK.</th></tr><tr><td>5.00</td><td>24X30</td><td>31-5505</td><td>1</td><td>.080</td></tr><tr><td>7.50</td><td>30X36</td><td>31-5504</td><td>1</td><td>.080</td></tr><tr><td>12.00</td><td>36X48</td><td>31-5506</td><td>2</td><td>.100</td></tr><tr><td>20.00</td><td>48X60</td><td>31-5507</td><td>2B</td><td>.100</td></tr></table>										AREA (SQ. FT)	SIZE (INCHES)	CONN. D.O.T. #	POSTS	ALUM. THK.	5.00	24X30	31-5505	1	.080	7.50	30X36	31-5504	1	.080	12.00	36X48	31-5506	2	.100	20.00	48X60	31-5507	2B	.100	<div>R3-1</div> <div></div> <div>31-1604 OVERHEAD MTD</div> <div>LEGEND - BLACK BACKGROUND - WHITE CIRCLE & DIAGONAL - RED</div> <table><tr><th>AREA (SQ. FT)</th><th>SIZE (INCHES)</th><th>CONN. D.O.T. #</th><th>POSTS</th><th>ALUM. THK.</th></tr><tr><td>4.00</td><td>24X24</td><td>31-1604</td><td></td><td>.080</td></tr><tr><td>6.25</td><td>30X30</td><td>31-1617</td><td>1</td><td>.080</td></tr><tr><td>5.00</td><td>30X24</td><td>31-1618</td><td></td><td>.080</td></tr><tr><td>9.00</td><td>36X36</td><td>31-1627</td><td>2</td><td>.080</td></tr><tr><td>7.50</td><td>36X30</td><td>31-1628</td><td></td><td>.080</td></tr></table> <div>R3-5</div> <div></div> <div>31-0135L 31-0135R</div> <div>LEGEND - BLACK BACKGROUND - WHITE CIRCLE & DIAGONAL - RED</div> <table><tr><th>AREA (SQ. FT)</th><th>SIZE (INCHES)</th><th>CONN. D.O.T. #</th><th>POSTS</th><th>ALUM. THK.</th></tr><tr><td>4.00</td><td>24X24</td><td>31-0135L</td><td>1</td><td>.080</td></tr><tr><td>4.00</td><td>24X24</td><td>31-0138R</td><td>1</td><td>.080</td></tr><tr><td>4.00</td><td>24X24</td><td>31-0125</td><td>1</td><td>.080</td></tr><tr><td>6.25</td><td>30X30</td><td>31-0165</td><td>1</td><td>.080</td></tr><tr><td>7.50</td><td>30X36</td><td>31-0183L</td><td>1</td><td>.080</td></tr><tr><td>7.50</td><td>30X36</td><td>31-0184R</td><td>1</td><td>.080</td></tr></table> <div>R3-6b</div> <div></div> <div>31-0282 31-0283</div> <div>LEGEND - BLACK BACKGROUND - WHITE CIRCLE & DIAGONAL - RED</div> <table><tr><th>AREA (SQ. FT)</th><th>SIZE (INCHES)</th><th>CONN. D.O.T. #</th><th>POSTS</th><th>ALUM. THK.</th></tr><tr><td>10.00</td><td>48X30</td><td>31-0302</td><td>2</td><td>.100</td></tr><tr><td>20.00</td><td>48X60</td><td>31-0121L</td><td>2B</td><td>.100</td></tr><tr><td>20.00</td><td>48X60</td><td>31-0122R</td><td>2B</td><td>.100</td></tr></table> <div>LEFT LANE MUST TURN LEFT</div> <div>RIGHT LANE MUST TURN RIGHT</div>										AREA (SQ. FT)	SIZE (INCHES)	CONN. D.O.T. #	POSTS	ALUM. THK.	4.00	24X24	31-1604		.080	6.25	30X30	31-1617	1	.080	5.00	30X24	31-1618		.080	9.00	36X36	31-1627	2	.080	7.50	36X30	31-1628		.080	AREA (SQ. FT)	SIZE (INCHES)	CONN. D.O.T. #	POSTS	ALUM. THK.	4.00	24X24	31-0135L	1	.080	4.00	24X24	31-0138R	1	.080	4.00	24X24	31-0125	1	.080	6.25	30X30	31-0165	1	.080	7.50	30X36	31-0183L	1	.080	7.50	30X36	31-0184R	1	.080	AREA (SQ. FT)	SIZE (INCHES)	CONN. D.O.T. #	POSTS	ALUM. THK.	10.00	48X30	31-0302	2	.100	20.00	48X60	31-0121L	2B	.100	20.00	48X60	31-0122R	2B	.100	<div>R4-1</div> <div></div> <div>KEEP RIGHT EXCEPT TO PASS</div> <div>R5-1</div> <div>*</div> <div></div> <div>LEGEND - WHITE BACKGROUND - WHITE CIRCLE - RED</div> <table><tr><th>AREA (SQ. FT)</th><th>SIZE (INCHES)</th><th>CONN. D.O.T. #</th><th>POSTS</th><th>ALUM. THK.</th></tr><tr><td>6.25</td><td>30X30</td><td>31-1119</td><td>1</td><td>.080</td></tr><tr><td>9.00</td><td>36X36</td><td>31-1120</td><td>2</td><td>.080</td></tr><tr><td>16.00</td><td>48X48</td><td>31-1121</td><td>2</td><td>.100</td></tr></table> <div>NO PEDESTRIANS BICYCLES MOTOR BIKES MOTOR SCOOTERS</div>										AREA (SQ. FT)	SIZE (INCHES)	CONN. D.O.T. #	POSTS	ALUM. THK.	6.25	30X30	31-1119	1	.080	9.00	36X36	31-1120	2	.080	16.00	48X48	31-1121	2	.100																																																																											
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<div>R1-3</div> <div>*</div> <div></div> <div>LEGEND - WHITE BACKGROUND - RED</div> <table><tr><th>AREA (SQ. FT)</th><th>SIZE (INCHES)</th><th>CONN. D.O.T. #</th><th>POSTS</th><th>ALUM. THK.</th></tr><tr><td>0.75</td><td>18X6</td><td>31-0508</td><td></td><td>.080</td></tr></table>										AREA (SQ. FT)	SIZE (INCHES)	CONN. D.O.T. #	POSTS	ALUM. THK.	0.75	18X6	31-0508		.080	<div>R2-3</div> <div></div> <div>R3-7L R3-7R</div> <div>LEGEND - BLACK BACKGROUND - WHITE CIRCLE & DIAGONAL - RED</div> <table><tr><th>AREA (SQ. FT)</th><th>SIZE (INCHES)</th><th>CONN. D.O.T. #</th><th>POSTS</th><th>ALUM. THK.</th></tr><tr><td>6.25</td><td>30X30</td><td>31-0117L</td><td>1</td><td>.080</td></tr><tr><td>6.25</td><td>30X30</td><td>31-0118R</td><td>1</td><td>.080</td></tr><tr><td>9.00</td><td>36X36</td><td>31-0120L</td><td>2</td><td>.080</td></tr><tr><td>9.00</td><td>36X36</td><td>31-0123R</td><td>2</td><td>.080</td></tr></table> <div>R3-4</div> <div></div> <div>LEGEND - BLACK BACKGROUND - WHITE CIRCLE & DIAGONAL - RED</div> <table><tr><th>AREA (SQ. FT)</th><th>SIZE (INCHES)</th><th>CONN. D.O.T. #</th><th>POSTS</th><th>ALUM. THK.</th></tr><tr><td>4.00</td><td>24X24</td><td>31-1622</td><td>1</td><td>.080</td></tr><tr><td>9.00</td><td>36X36</td><td>31-1632</td><td>2</td><td>.080</td></tr></table> <div>R3-4b</div> <div></div> <div>31-0222 31-0223</div> <div>LEGEND - BLACK BACKGROUND - WHITE CIRCLE & DIAGONAL - RED</div> <table><tr><th>AREA (SQ. FT)</th><th>SIZE (INCHES)</th><th>CONN. D.O.T. #</th><th>POSTS</th><th>ALUM. THK.</th></tr><tr><td>6.25</td><td>30X30</td><td>31-0262L</td><td>1</td><td>.080</td></tr><tr><td>8.75</td><td>42X30</td><td>31-0279</td><td>2</td><td>.100</td></tr></table> <div>R4-7</div> <div></div> <div>31-0370 31-0371</div> <div>LEGEND - BLACK BACKGROUND - WHITE CIRCLE & DIAGONAL - RED</div> <table><tr><th>AREA (SQ. FT)</th><th>SIZE (INCHES)</th><th>CONN. D.O.T. #</th><th>POSTS</th><th>ALUM. THK.</th></tr><tr><td>8.75</td><td>42X30</td><td></td><td>2</td><td>.100</td></tr></table>										AREA (SQ. FT)	SIZE (INCHES)	CONN. D.O.T. #	POSTS	ALUM. THK.	6.25	30X30	31-0117L	1	.080	6.25	30X30	31-0118R	1	.080	9.00	36X36	31-0120L	2	.080	9.00	36X36	31-0123R	2	.080	AREA (SQ. FT)	SIZE (INCHES)	CONN. D.O.T. #	POSTS	ALUM. THK.	4.00	24X24	31-1622	1	.080	9.00	36X36	31-1632	2	.080	AREA (SQ. FT)	SIZE (INCHES)	CONN. D.O.T. #	POSTS	ALUM. THK.	6.25	30X30	31-0262L	1	.080	8.75	42X30	31-0279	2	.100	AREA (SQ. FT)	SIZE (INCHES)	CONN. D.O.T. #	POSTS	ALUM. THK.	8.75	42X30		2	.100	<div>R2-4</div> <div></div> <div>LEGEND - WHITE BACKGROUND - RED</div> <table><tr><th>AREA (SQ. FT)</th><th>SIZE (INCHES)</th><th>CONN. D.O.T. #</th><th>POSTS</th><th>ALUM. THK.</th></tr><tr><td>27.00</td><td>54X72</td><td>31-1719</td><td>2B</td><td>.125</td></tr><tr><td>5.00</td><td>30X24</td><td>31-1702</td><td>1</td><td>.080</td></tr></table> <div>R5-10c</div> <div></div> <div>LEGEND - WHITE BACKGROUND - RED</div> <table><tr><th>AREA (SQ. FT)</th><th>SIZE (INCHES)</th><th>CONN. D.O.T. #</th><th>POSTS</th><th>ALUM. THK.</th></tr><tr><td>2.00</td><td>24X12</td><td>31-1774</td><td>1</td><td>.080</td></tr></table>										AREA (SQ. FT)	SIZE (INCHES)	CONN. D.O.T. #	POSTS	ALUM. THK.	27.00	54X72	31-1719	2B	.125	5.00	30X24	31-1702	1	.080	AREA (SQ. FT)	SIZE (INCHES)	CONN. D.O.T. #	POSTS	ALUM. THK.	2.00	24X12	31-1774	1	.080																																																																																																																																												
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<div>R6-1</div> <div>(L) (R)</div> <div></div> <table><tr><th>AREA (SQ. FT)</th><th>SIZE (INCHES)</th><th>CONN. D.O.T. #</th><th>POSTS</th><th>ALUM. THK.</th></tr><tr><td>3.00</td><td>36X12</td><td>31-1188L</td><td>1</td><td>.080</td></tr><tr><td>3.00</td><td>36X12</td><td>31-1177R</td><td>1</td><td>.080</td></tr><tr><td>6.75</td><td>54X18</td><td>31-1189L</td><td>2</td><td>.100</td></tr><tr><td>6.75</td><td>54X18</td><td>31-1178R</td><td>2</td><td>.100</td></tr></table>										AREA (SQ. FT)	SIZE (INCHES)	CONN. D.O.T. #	POSTS	ALUM. THK.	3.00	36X12	31-1188L	1	.080	3.00	36X12	31-1177R	1	.080	6.75	54X18	31-1189L	2	.100	6.75	54X18	31-1178R	2	.100	<div>R7-1</div> <div>(R) (D) (P) (NO ARROW)</div> <div></div> <div>LEGEND - WHITE BACKGROUND - BLUE</div> <table><tr><th>AREA (SQ. FT)</th><th>SIZE (INCHES)</th><th>CONN. D.O.T. #</th><th>POSTS</th><th>ALUM. THK.</th></tr><tr><td>2.00</td><td>12X24</td><td>31-0629</td><td>1</td><td>.080</td></tr></table> <div>R7-2a</div> <div></div> <div>LEGEND - RED BACKGROUND - WHITE</div> <table><tr><th>AREA (SQ. FT)</th><th>SIZE (INCHES)</th><th>CONN. D.O.T. #</th><th>POSTS</th><th>ALUM. THK.</th></tr><tr><td>1.50</td><td>12X18</td><td>31-0630</td><td>1</td><td>.080</td></tr></table> <div>R7-2b</div> <div></div> <div>LEGEND - RED BACKGROUND - WHITE</div> <table><tr><th>AREA (SQ. FT)</th><th>SIZE (INCHES)</th><th>CONN. D.O.T. #</th><th>POSTS</th><th>ALUM. THK.</th></tr><tr><td>1.50</td><td>12X18</td><td>31-0603</td><td>1</td><td>.080</td></tr></table>										AREA (SQ. FT)	SIZE (INCHES)	CONN. D.O.T. #	POSTS	ALUM. THK.	2.00	12X24	31-0629	1	.080	AREA (SQ. FT)	SIZE (INCHES)	CONN. D.O.T. #	POSTS	ALUM. THK.	1.50	12X18	31-0630	1	.080	AREA (SQ. FT)	SIZE (INCHES)	CONN. D.O.T. #	POSTS	ALUM. THK.	1.50	12X18	31-0603	1	.080	<div>R8-7</div> <div></div> <table><tr><th>AREA (SQ. FT)</th><th>SIZE (INCHES)</th><th>CONN. D.O.T. #</th><th>POSTS</th><th>ALUM. THK.</th></tr><tr><td>12.00</td><td>48X36</td><td>31-0670</td><td>2</td><td>.100</td></tr></table>										AREA (SQ. FT)	SIZE (INCHES)	CONN. D.O.T. #	POSTS	ALUM. THK.	12.00	48X36	31-0670	2	.100	<div>R9-1</div> <div></div> <table><tr><th>AREA (SQ. FT)</th><th>SIZE (INCHES)</th><th>CONN. D.O.T. #</th><th>POSTS</th><th>ALUM. THK.</th></tr><tr><td>27.50</td><td>66X60</td><td>31-1733</td><td>2B</td><td>.125</td></tr></table>										AREA (SQ. FT)	SIZE (INCHES)	CONN. D.O.T. #	POSTS	ALUM. THK.	27.50	66X60	31-1733	2B	.125	<div>R10-6</div> <div></div> <div>31-0801 31-0802</div> <div>LEGEND - BLACK BACKGROUND - WHITE CIRCLE & DIAGONAL - RED</div> <table><tr><th>AREA (SQ. FT)</th><th>SIZE (INCHES)</th><th>CONN. D.O.T. #</th><th>POSTS</th><th>ALUM. THK.</th></tr><tr><td>6.00</td><td>24X36</td><td></td><td>1</td><td>.080</td></tr><tr><td>4.00</td><td>24X24</td><td>31-0823</td><td></td><td>.080</td></tr><tr><td>9.00</td><td>36X36</td><td>31-0816</td><td>2</td><td>.080</td></tr></table> <div>R10-11b</div> <div></div> <div>LEGEND - BLACK BACKGROUND - WHITE CIRCLE & DIAGONAL - RED</div> <table><tr><th>AREA (SQ. FT)</th><th>SIZE (INCHES)</th><th>CONN. D.O.T. #</th><th>POSTS</th><th>ALUM. THK.</th></tr><tr><td>7.50</td><td>30X36</td><td>31-0847</td><td>1</td><td>.080</td></tr><tr><td>20.00</td><td>48X60</td><td>31-0849</td><td>2B</td><td>.100</td></tr></table> <div>R10-10L</div> <div></div> <div>LEGEND - BLACK BACKGROUND - WHITE CIRCLE & DIAGONAL - RED</div> <table><tr><th>AREA (SQ. FT)</th><th>SIZE (INCHES)</th><th>CONN. D.O.T. #</th><th>POSTS</th><th>ALUM. 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THK.	6.00	24X36		1	.080	4.00	24X24	31-0823		.080	9.00	36X36	31-0816	2	.080	AREA (SQ. FT)	SIZE (INCHES)	CONN. D.O.T. #	POSTS	ALUM. THK.	7.50	30X36	31-0847	1	.080	20.00	48X60	31-0849	2B	.100	AREA (SQ. FT)	SIZE (INCHES)	CONN. D.O.T. #	POSTS	ALUM. THK.	5.00	24X30	31-0803	1	.080	12.00	36X48	31-0804	2	.100	AREA (SQ. FT)	SIZE (INCHES)	CONN. D.O.T. #	POSTS	ALUM. THK.	5.00	24X30	31-0806	1	.080	12.00	36X48	31-0807	2	.100	AREA (SQ. FT)	SIZE (INCHES)	CONN. D.O.T. #	POSTS	ALUM. THK.	7.50	30X36	31-0830	1	.080	12.00	36X48	31-0819	2	.100	<div>R11-1</div> <div></div> <table><tr><th>AREA (SQ. FT)</th><th>SIZE (INCHES)</th><th>CONN. D.O.T. #</th><th>POSTS</th><th>ALUM. THK.</th></tr><tr><td>5.00</td><td>24X30</td><td>31-1915</td><td>1</td><td>.080</td></tr><tr><td>20.00</td><td>48X60</td><td>31-1918</td><td>2B</td><td>.100</td></tr></table>										AREA (SQ. FT)	SIZE (INCHES)	CONN. D.O.T. #	POSTS	ALUM. THK.	5.00	24X30	31-1915	1	.080	20.00	48X60	31-1918	2B	.100	<div>*</div> <div></div> <div>LEGEND - N/A</div> <table><tr><th>AREA (SQ. FT)</th><th>SIZE (INCHES)</th><th>CONN. D.O.T. #</th><th>POSTS</th><th>ALUM. THK.</th></tr><tr><td>1.00</td><td>4X36</td><td>31-5003</td><td>1</td><td>.080</td></tr><tr><td>2.00</td><td>4X72</td><td>31-5004</td><td>1</td><td>.080</td></tr><tr><td>2.67</td><td>4X96</td><td>31-5005</td><td>1</td><td>.080</td></tr></table>										AREA (SQ. FT)	SIZE (INCHES)	CONN. D.O.T. #	POSTS	ALUM. THK.	1.00	4X36	31-5003	1	.080	2.00	4X72	31-5004	1	.080	2.67	4X96	31-5005	1	.080	<div>NOTES:</div> <div>FOR METRIC SEE CONVERSION CHART.</div> <div>1. THE LEGEND "O.S.T.A." SHALL APPEAR ON ALL R-SERIES SIGNS EXCEPT WHEN SUFFIXED WITH THE LETTER "Z".</div> <div>2. FOR SPECIFIC SIGN DESIGN CONTACT CONN. D.O.T., DIVISION OF TRAFFIC ENGINEERING.</div> <div>FOR BOLT HOLE PATTERN REFER TO FHWA PUBLICATION "STANDARD HIGHWAY SIGNS".</div> <div>SIGNS OF DIFFERENT DIMENSIONS TO BE ERCTED ON THE SAME POSTS, OR SPAN/MAST ARM MOUNTED, MAY REQUIRE SPECIAL BOLT HOLE PATTERNS.</div> <div>3. POSTS - SEE STANDARD SHEET TR-1208.02 - "METAL SIGN POSTS AND SIGN MOUNTING DETAILS."</div> <div>4. POSTS - TYPE A (EXCEPT WHERE NOTED WITH A "B" FOR TYPE B)</div> <div>5. SIGNS SHALL BE FABRICATED OF ONE CONTINUOUS PIECE OF SHEET ALUMINUM.</div> <div>SPLICING OF SHEET ALUMINUM WILL NOT BE ACCEPTED.</div> <div>6. FOR OVERHEAD MOUNTED SIGNS, SEE STANDARD SHEET TR-1114.01 - "BONDING AND UTILITY POLE ATTACHMENT DETAILS, SIGN HANGER, "Y" CLAMP DETAIL."</div> <div>COLORS:</div> <div>BACKGROUND - WHITE (SILVER) - EXCEPT AS NOTED.</div> <div>LEGEND - BLACK - EXCEPT AS NOTED.</div> <div>ALL SIGNS TO USE TYPE IV RETROREFLECTIVE SHEETING EXCEPT AS NOTED BY *.</div> <div>* SIGNS TO USE TYPE IX RETROREFLECTIVE SHEETING.</div>									
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AREA (SQ. FT)	SIZE (INCHES)	CONN. D.O.T. #	POSTS	ALUM. THK.																																																																																																																																																																																																																																																																									
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AREA (SQ. FT)	SIZE (INCHES)	CONN. D.O.T. #	POSTS	ALUM. THK.																																																																																																																																																																																																																																																																									
12.00	48X36	31-0670	2	.100																																																																																																																																																																																																																																																																									
AREA (SQ. FT)	SIZE (INCHES)	CONN. D.O.T. #	POSTS	ALUM. THK.																																																																																																																																																																																																																																																																									
27.50	66X60	31-1733	2B	.125																																																																																																																																																																																																																																																																									
AREA (SQ. FT)	SIZE (INCHES)	CONN. D.O.T. #	POSTS	ALUM. THK.																																																																																																																																																																																																																																																																									
6.00	24X36		1	.080																																																																																																																																																																																																																																																																									
4.00	24X24	31-0823		.080																																																																																																																																																																																																																																																																									
9.00	36X36	31-0816	2	.080																																																																																																																																																																																																																																																																									
AREA (SQ. FT)	SIZE (INCHES)	CONN. D.O.T. #	POSTS	ALUM. THK.																																																																																																																																																																																																																																																																									
7.50	30X36	31-0847	1	.080																																																																																																																																																																																																																																																																									
20.00	48X60	31-0849	2B	.100																																																																																																																																																																																																																																																																									
AREA (SQ. FT)	SIZE (INCHES)	CONN. D.O.T. #	POSTS	ALUM. THK.																																																																																																																																																																																																																																																																									
5.00	24X30	31-0803	1	.080																																																																																																																																																																																																																																																																									
12.00	36X48	31-0804	2	.100																																																																																																																																																																																																																																																																									
AREA (SQ. FT)	SIZE (INCHES)	CONN. D.O.T. #	POSTS	ALUM. THK.																																																																																																																																																																																																																																																																									
5.00	24X30	31-0806	1	.080																																																																																																																																																																																																																																																																									
12.00	36X48	31-0807	2	.100																																																																																																																																																																																																																																																																									
AREA (SQ. FT)	SIZE (INCHES)	CONN. D.O.T. #	POSTS	ALUM. THK.																																																																																																																																																																																																																																																																									
7.50	30X36	31-0830	1	.080																																																																																																																																																																																																																																																																									
12.00	36X48	31-0819	2	.100																																																																																																																																																																																																																																																																									
AREA (SQ. FT)	SIZE (INCHES)	CONN. D.O.T. #	POSTS	ALUM. THK.																																																																																																																																																																																																																																																																									
5.00	24X30	31-1915	1	.080																																																																																																																																																																																																																																																																									
20.00	48X60	31-1918	2B	.100																																																																																																																																																																																																																																																																									
AREA (SQ. FT)	SIZE (INCHES)	CONN. D.O.T. #	POSTS	ALUM. THK.																																																																																																																																																																																																																																																																									
1.00	4X36	31-5003	1	.080																																																																																																																																																																																																																																																																									
2.00	4X72	31-5004	1	.080																																																																																																																																																																																																																																																																									
2.67	4X96	31-5005	1	.080																																																																																																																																																																																																																																																																									

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D1 - SERIES	D3 - SERIES	D4 - SERIES		D5 - SERIES	D7 - SERIES	D9 - SERIES	D10 - SERIES	RECREATIONAL RS- SERIES	E5 - SERIES	I - SERIES	INCIDENT MANAGEMENT																																																																																																																																																																										
<div>D1-1</div> <div><div>51-5202</div><div>Variable</div><div>→</div></div> <div>D1-2</div> <div><div>51-5203</div><div>Variable</div><div>Variable</div><div>→</div></div> <div>VARIABLE LEGEND & ARROW DIRECTION</div> <table><tr><th>AREA (SQ. FT)</th><th>SIZE (INCHES)</th><th>CONN. D.O.T. #</th><th>POSTS</th><th>ALUM. THK.</th></tr><tr><td>4.17</td><td>60X12</td><td>51-5202</td><td>2</td><td>.100</td></tr><tr><td>8.33</td><td>60X24</td><td>51-5203</td><td>2</td><td>.100</td></tr></table>	AREA (SQ. FT)	SIZE (INCHES)	CONN. D.O.T. #	POSTS	ALUM. THK.	4.17	60X12	51-5202	2	.100	8.33	60X24	51-5203	2	.100	<div>D3-1</div> <div>Variable Road Name</div> <div>D3-1</div> <div>Variable Road Name</div> <table><tr><th>AREA (SQ. FT)</th><th>SIZE (INCHES)</th><th>CONN. D.O.T. #</th><th>POSTS</th><th>ALUM. THK.</th></tr><tr><td>4.00</td><td>48X12</td><td>51-2010</td><td>2</td><td>.100</td></tr><tr><td>5.00</td><td>60X12</td><td>51-2011</td><td>2</td><td>.100</td></tr><tr><td>6.00</td><td>72X12</td><td>51-2012</td><td>2</td><td>.125</td></tr><tr><td>7.00</td><td>84X12</td><td>51-2013</td><td>2</td><td>.125</td></tr></table>	AREA (SQ. FT)	SIZE (INCHES)	CONN. D.O.T. #	POSTS	ALUM. THK.	4.00	48X12	51-2010	2	.100	5.00	60X12	51-2011	2	.100	6.00	72X12	51-2012	2	.125	7.00	84X12	51-2013	2	.125	<div>D4-2</div> <div><div><div><div><div></div><div></div></div><div></div></div><div>PARK - RIDE</div><div>→</div></div></div> <div>VARIABLE ARROW DIRECTION</div> <table><tr><th>AREA (SQ. FT)</th><th>SIZE (INCHES)</th><th>CONN. D.O.T. #</th><th>POSTS</th><th>ALUM. THK.</th></tr><tr><td>5.00</td><td>24X30</td><td>51-6006</td><td>1</td><td>.080</td></tr><tr><td>7.50</td><td>30X36</td><td>51-6007</td><td>1</td><td>.080</td></tr><tr><td>12.00</td><td>36X48</td><td>51-6008</td><td>2</td><td>.100</td></tr></table>	AREA (SQ. FT)	SIZE (INCHES)	CONN. D.O.T. #	POSTS	ALUM. THK.	5.00	24X30	51-6006	1	.080	7.50	30X36	51-6007	1	.080	12.00	36X48	51-6008	2	.100	<div>LEGEND - BLACK BACKGROUND - WHITE</div> <table><tr><th>AREA (SQ. FT)</th><th>SIZE (INCHES)</th><th>CONN. D.O.T. #</th><th>POSTS</th><th>ALUM. THK.</th></tr><tr><td>15.00</td><td>60X36</td><td>51-5937</td><td>2</td><td>.100</td></tr></table>	AREA (SQ. FT)	SIZE (INCHES)	CONN. D.O.T. #	POSTS	ALUM. THK.	15.00	60X36	51-5937	2	.100	<div>D5-2b</div> <div><div>REST AREA</div><div>↗</div></div> <div>LEGEND - WHITE BACKGROUND - BLUE</div> <table><tr><th>AREA (SQ. FT)</th><th>SIZE (INCHES)</th><th>CONN. D.O.T. #</th><th>POSTS</th><th>ALUM. THK.</th></tr><tr><td>42.25</td><td>78X78</td><td>51-6901</td><td>2B</td><td>.125</td></tr></table>	AREA (SQ. FT)	SIZE (INCHES)	CONN. D.O.T. #	POSTS	ALUM. THK.	42.25	78X78	51-6901	2B	.125	<div>D-7</div> <div><div>51-6802</div><div>Variable</div><div>→</div></div> <div><div>51-6803</div><div>Variable</div><div>Variable</div><div>→</div></div> <div>W or W/O ARROW VARIABLE ARROW DIRECTION</div> <table><tr><th>AREA (SQ. FT)</th><th>SIZE (INCHES)</th><th>CONN. D.O.T. #</th><th>POSTS</th><th>ALUM. THK.</th></tr><tr><td>4.17</td><td>60X10</td><td>51-6802</td><td>2</td><td>.100</td></tr><tr><td>8.33</td><td>60X20</td><td>51-6803</td><td>2</td><td>.100</td></tr></table>	AREA (SQ. FT)	SIZE (INCHES)	CONN. D.O.T. #	POSTS	ALUM. THK.	4.17	60X10	51-6802	2	.100	8.33	60X20	51-6803	2	.100	<div>D9-2</div> <div><div>H</div></div> <div>** FOR ARROW SUBPLATES USE M5 & M6 SERIES</div> <table><tr><th>AREA (SQ. FT)</th><th>SIZE (INCHES)</th><th>CONN. D.O.T. #</th><th>POSTS</th><th>ALUM. THK.</th></tr><tr><td>4.00</td><td>24X24</td><td>51-6788</td><td>1</td><td>.080</td></tr></table>	AREA (SQ. FT)	SIZE (INCHES)	CONN. D.O.T. #	POSTS	ALUM. THK.	4.00	24X24	51-6788	1	.080	<div>D10-4</div> <div><div><div>NORTH</div><div>95</div><div>MILE 000</div></div></div> <div>CARDINAL DIRECTION, SHIELD AND NUMERALS ARE VARIABLE</div> <table><tr><th>AREA (SQ. FT)</th><th>SIZE (INCHES)</th><th>CONN. D.O.T. #</th><th>POSTS</th><th>ALUM. THK.</th></tr><tr><td>6.75</td><td>18X54</td><td>51-5307</td><td>1</td><td>.080</td></tr></table>	AREA (SQ. FT)	SIZE (INCHES)	CONN. D.O.T. #	POSTS	ALUM. THK.	6.75	18X54	51-5307	1	.080	<div>RS-054</div> <div><div><div><div></div><div></div></div><div></div></div></div> <table><tr><th>AREA (SQ. FT)</th><th>SIZE (INCHES)</th><th>CONN. D.O.T. #</th><th>POSTS</th><th>ALUM. THK.</th></tr><tr><td>4.00</td><td>24X24</td><td>51-6873</td><td>1</td><td>.080</td></tr></table>	AREA (SQ. FT)	SIZE (INCHES)	CONN. D.O.T. #	POSTS	ALUM. THK.	4.00	24X24	51-6873	1	.080	<div>E5-1a</div> <div><div><div>EXIT</div><div>↖</div><div>(L)</div></div><div><div>EXIT</div><div>↗</div><div>(R)</div></div></div> <div>FOR USE AT "NO NUMBERED" EXITS (L or R)</div> <table><tr><th>AREA (SQ. FT)</th><th>SIZE (INCHES)</th><th>CONN. D.O.T. #</th><th>POSTS</th><th>ALUM. THK.</th></tr><tr><td>30.00</td><td>72X60</td><td>51-6150</td><td>2B</td><td>.125</td></tr></table>	AREA (SQ. FT)	SIZE (INCHES)	CONN. D.O.T. #	POSTS	ALUM. THK.	30.00	72X60	51-6150	2B	.125	<div>I-3</div> <div><div>(Variable) River</div></div> <div>VARIABLE: RIVER, BROOK, CREEK</div> <table><tr><th>AREA (SQ. FT)</th><th>SIZE (INCHES)</th><th>CONN. D.O.T. #</th><th>POSTS</th><th>ALUM. THK.</th></tr><tr><td>4.50</td><td>36X18</td><td>51-2007</td><td>2</td><td>.080</td></tr><tr><td>12.00</td><td>48X36</td><td>51-2051</td><td>2</td><td>.100</td></tr></table>	AREA (SQ. FT)	SIZE (INCHES)	CONN. D.O.T. #	POSTS	ALUM. THK.	4.50	36X18	51-2007	2	.080	12.00	48X36	51-2051	2	.100	<div>CARDINAL DIRECTION VARIABLE - N, S, E, W</div> <table><tr><th>AREA (SQ. FT)</th><th>SIZE (INCHES)</th><th>CONN. D.O.T. #</th><th>POSTS</th><th>ALUM. THK.</th></tr><tr><td>3.00</td><td>12X36</td><td>51-5103</td><td>1</td><td>.080</td></tr><tr><td>4.00</td><td>12X48</td><td>51-5104</td><td>1</td><td>.080</td></tr><tr><td>5.00</td><td>12X60</td><td>51-5105</td><td>1</td><td>.080</td></tr></table>	AREA (SQ. FT)	SIZE (INCHES)	CONN. D.O.T. #	POSTS	ALUM. THK.	3.00	12X36	51-5103	1	.080	4.00	12X48	51-5104	1	.080	5.00	12X60	51-5105	1	.080
AREA (SQ. FT)	SIZE (INCHES)	CONN. D.O.T. #	POSTS	ALUM. THK.																																																																																																																																																																																	
4.17	60X12	51-5202	2	.100																																																																																																																																																																																	
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AREA (SQ. FT)	SIZE (INCHES)	CONN. D.O.T. #	POSTS	ALUM. THK.																																																																																																																																																																																	
4.00	48X12	51-2010	2	.100																																																																																																																																																																																	
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6.00	72X12	51-2012	2	.125																																																																																																																																																																																	
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5.00	24X30	51-6006	1	.080																																																																																																																																																																																	
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15.00	60X36	51-5937	2	.100																																																																																																																																																																																	
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4.00	24X24	51-6788	1	.080																																																																																																																																																																																	
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4.00	24X24	51-6873	1	.080																																																																																																																																																																																	
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5.00	12X60	51-5105	1	.080																																																																																																																																																																																	
<div>D9-3a</div> <div><div><div><div></div><div></div></div><div></div></div></div> <div>** FOR ARROW SUBPLATES USE M5 & M6 SERIES</div> <table><tr><th>AREA (SQ. FT)</th><th>SIZE (INCHES)</th><th>CONN. D.O.T. #</th><th>POSTS</th><th>ALUM. THK.</th></tr><tr><td>4.00</td><td>24X24</td><td>51-6762</td><td>1</td><td>.080</td></tr></table>	AREA (SQ. FT)	SIZE (INCHES)	CONN. D.O.T. #	POSTS	ALUM. THK.	4.00	24X24	51-6762	1	.080	<div>RS-117</div> <div><div><div><div></div><div></div></div><div></div></div></div> <table><tr><th>AREA (SQ. FT)</th><th>SIZE (INCHES)</th><th>CONN. D.O.T. #</th><th>POSTS</th><th>ALUM. THK.</th></tr><tr><td>4.00</td><td>24X24</td><td>51-7872</td><td>1</td><td>.080</td></tr></table>	AREA (SQ. FT)	SIZE (INCHES)	CONN. D.O.T. #	POSTS	ALUM. THK.	4.00	24X24	51-7872	1	.080	<div>E5-1a</div> <div><div><div>EXIT</div><div>↖</div><div>00</div><div>(L)</div></div><div><div>EXIT</div><div>↗</div><div>00</div><div>(R)</div></div></div> <div>VARIABLE: TOWN / CITY (INCORPORATED) (DATE) OR SETTLED TOWN LINE</div> <table><tr><th>AREA (SQ. FT)</th><th>SIZE (INCHES)</th><th>CONN. D.O.T. #</th><th>POSTS</th><th>ALUM. THK.</th></tr><tr><td>7.50</td><td>40X27</td><td>51-2020</td><td>2</td><td>.080</td></tr></table>	AREA (SQ. FT)	SIZE (INCHES)	CONN. D.O.T. #	POSTS	ALUM. THK.	7.50	40X27	51-2020	2	.080	<div>SYMBOL - WHITE BACKGROUND - BLUE</div> <table><tr><th>AREA (SQ. FT)</th><th>SIZE (INCHES)</th><th>CONN. D.O.T. #</th><th>POSTS</th><th>ALUM. THK.</th></tr><tr><td>3.00</td><td>18X24</td><td>51-5943</td><td>1</td><td>.080</td></tr></table>	AREA (SQ. FT)	SIZE (INCHES)	CONN. D.O.T. #	POSTS	ALUM. THK.	3.00	18X24	51-5943	1	.080																																																																																																																																										
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LEGEND - WHITE
BACKGROUND - RED & BLUE

NOTES:

FOR METRIC SEE CONVERSION CHART.

1. FOR SPECIFIC SIGN DESIGN CONTACT CONN. D.O.T., DIVISION OF TRAFFIC ENGINEERING.
FOR BOLT HOLE PATTERN REFER TO FHWA PUBLICATION "STANDARD HIGHWAY SIGNS".
SIGNS OF DIFFERENT DIMENSIONS TO BE ERCTED ON THE SAME POSTS, OR SPAN/MAST ARM MOUNTED,
MAY REQUIRE SPECIAL BOLT HOLE PATTERNS.

2. POSTS - SEE STANDARD SHEET TR-1208.02 - "METAL SIGN POSTS AND SIGN MOUNTING DETAILS."

3. POSTS - TYPE A (EXCEPT WHERE NOTED WITH A "B" FOR TYPE B)

4. SIGNS SHALL BE FABRICATED OF ONE CONTINUOUS PIECE OF SHEET ALUMINUM.
SPlicing OF SHEET ALUMINUM WILL NOT BE ACCEPTED.

COLORS:

D - SERIES
D1, 2, 3, 4, 10 BACKGROUND-GREEN, LEGEND-WHITE
D7, RS BACKGROUND-BROWN, LEGEND-WHITE
D9 BACKGROUND-BLUE, LEGEND-WHITE
ALL OTHER D-SERIES AS NOTED

E - SERIES
BACKGROUND-GREEN, LEGEND-WHITE

I - SERIES
BACKGROUND-GREEN, LEGEND-WHITE
(EXCEPT AS NOTED)
M2 - M6 SERIES
(1) BACKGROUND-BLUE, LEGEND-WHITE
(2) BACKGROUND-WHITE, LEGEND-BLACK

ALL COLORS SHALL BE TYPE IV RETROREFLECTIVE WITH THE EXCEPTION OF BLACK WHICH SHALL BE OPAQUE.

TOWN OF BROOKFIELD, CT

PROJECT NAME: TOWN DISTRICT SIDEWALK AND ACCESS
MANAGEMENT PLAN

SHEET TITLE: SIGN FACE SHEET ALUMINUM D,RS,E,I,&M SERIES TYPICAL DETAILS

FILE NAME:

PLOT DATE:4/20/2016

DRAWING NO.: MDS-19

PROJECT LEADER: SM

DRAWN BY: AG

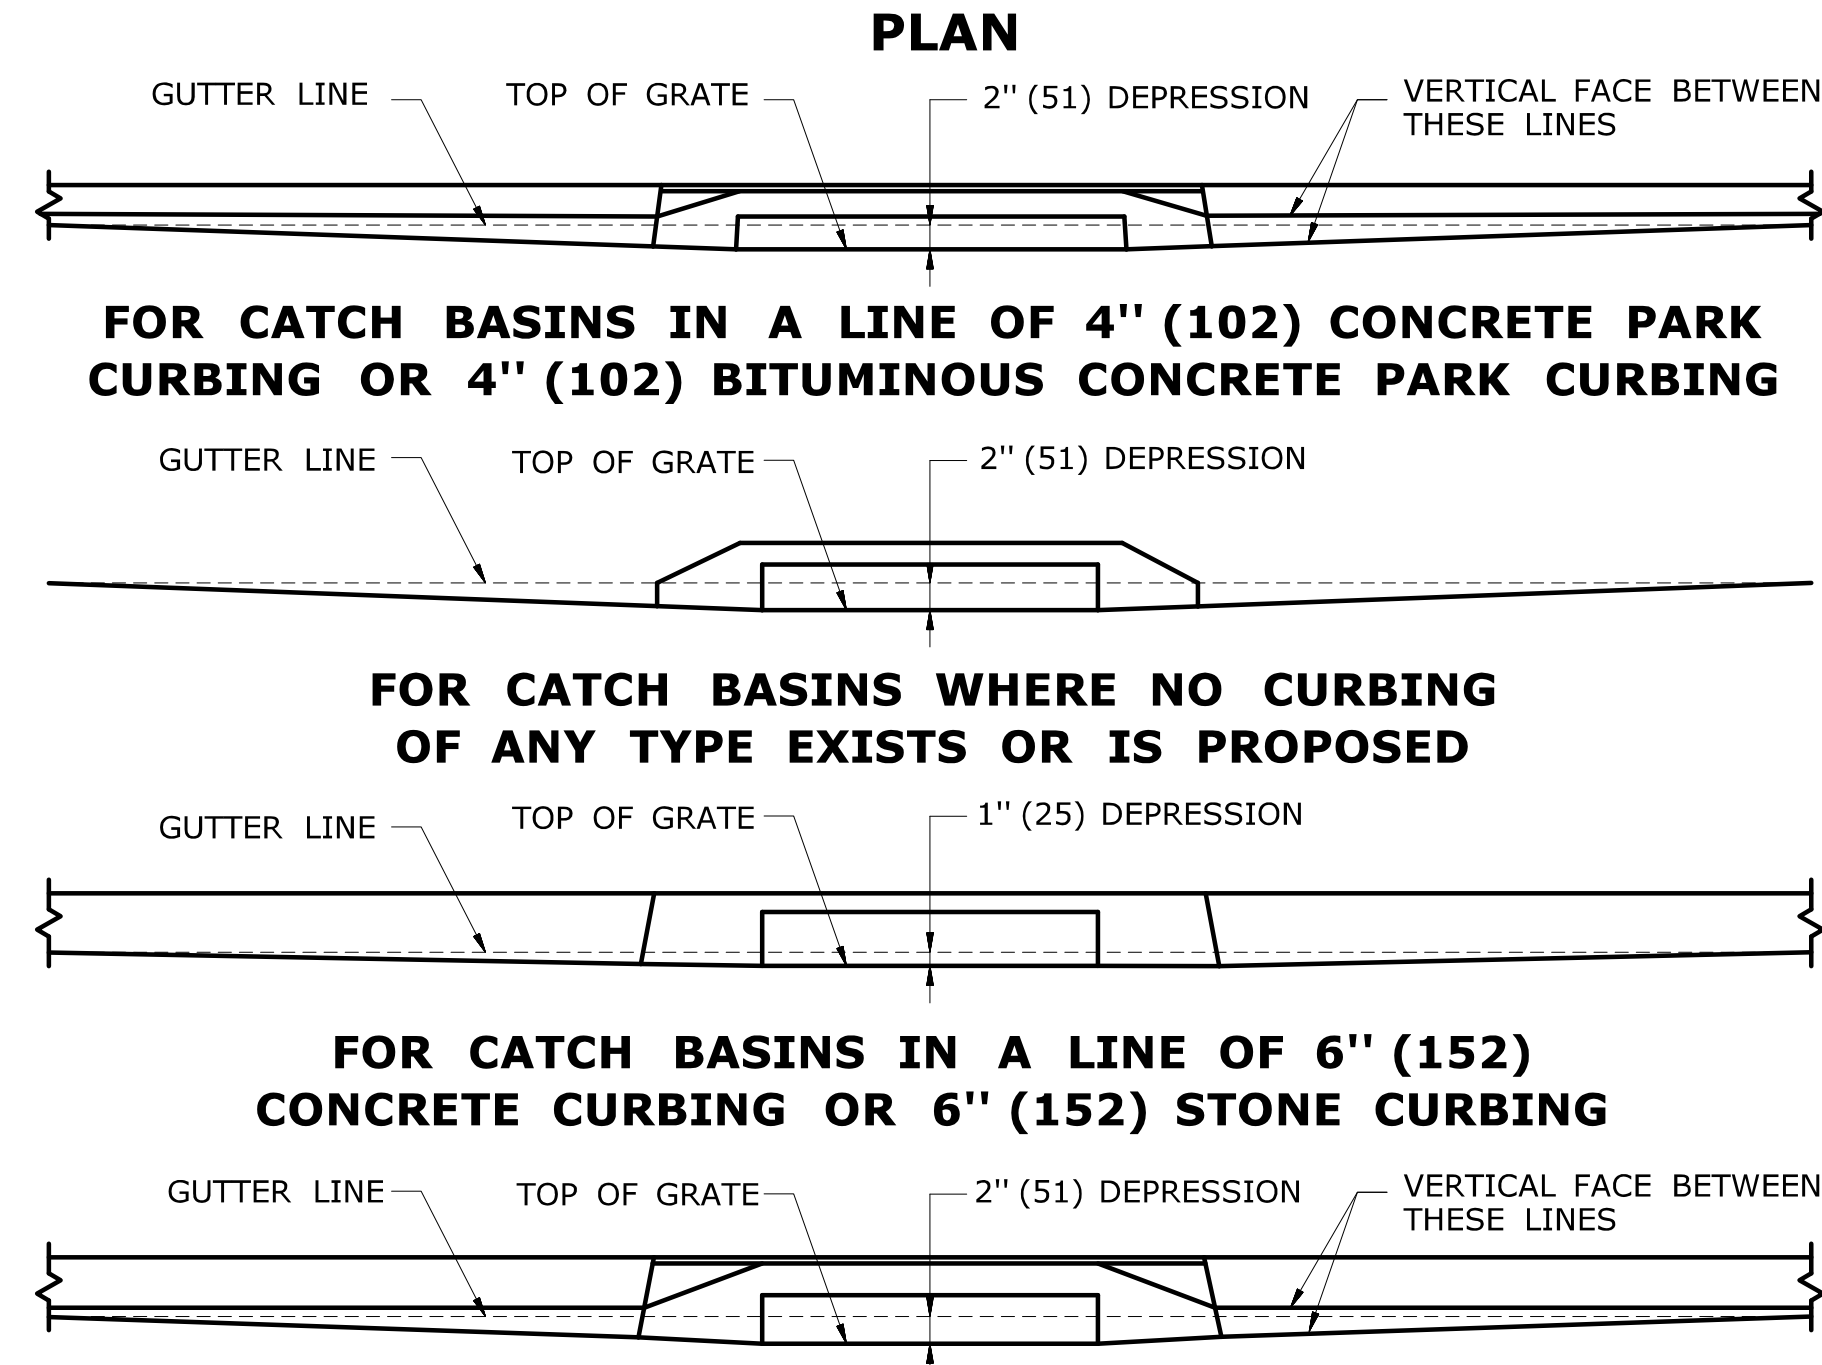
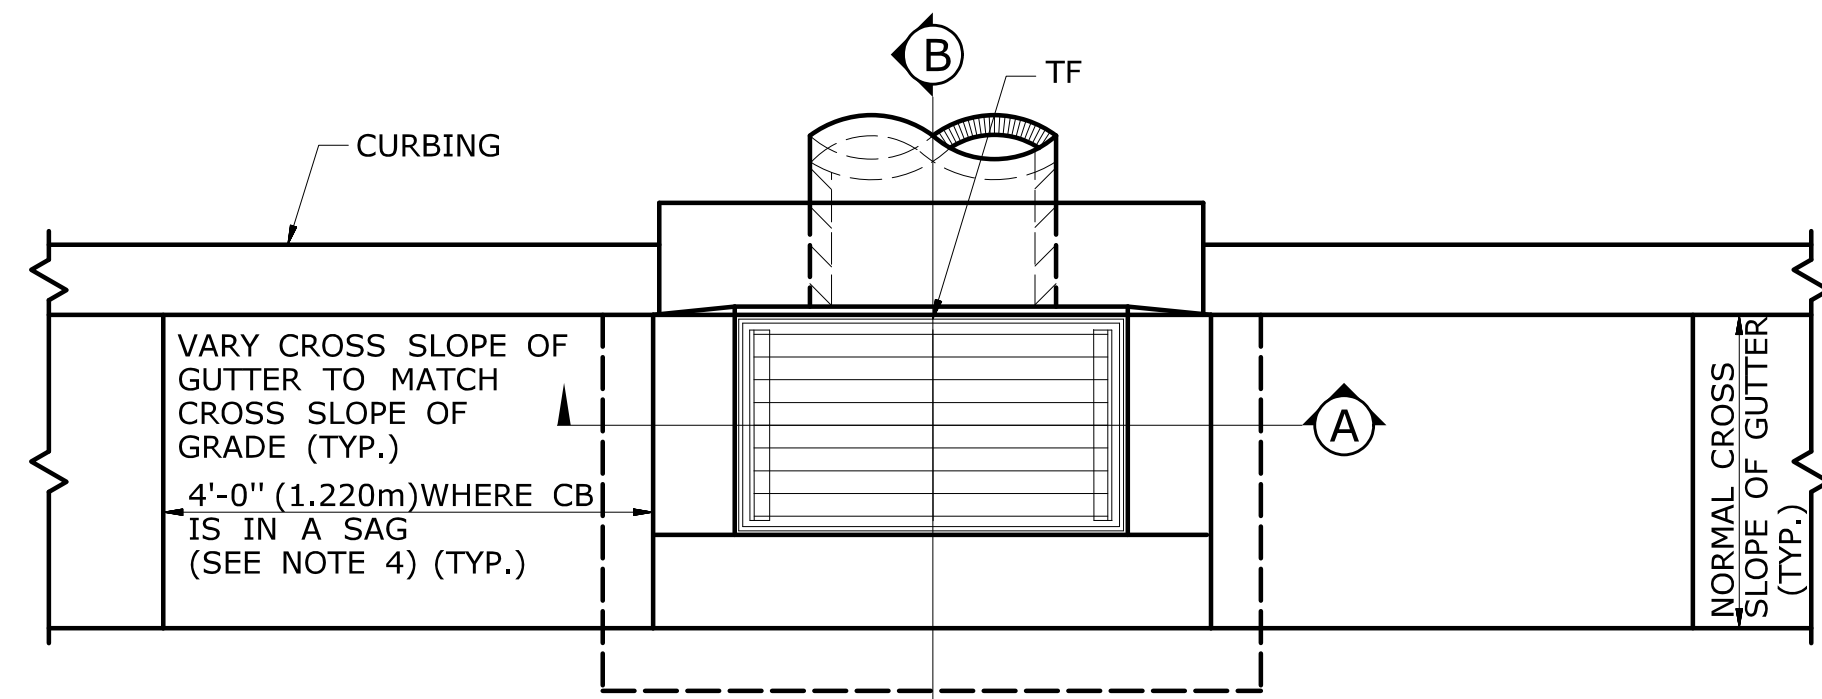
CHECKED BY: PG

SHEET NO.: 25

URS CORPORATION
500 ENTERPRISE DRIVE, SUITE 3B
ROCKY HILL, CT 06067
(860) 529-8882


GENERAL NOTES:

1. FOR DETAILS OF FRAME AND GRATE SEE STANDARD SHEET HW-507-08.
2. USE APPROPRIATE CONCRETE TOP FOR CURBING SHOWN ON PLANS. IF CURBING IS NOT SPECIFIED ON THE PLANS, IT SHALL BE CONSTRUCTED AS DIRECTED BY THE ENGINEER.
3. ALL FACES OF STRUCTURES IN CONTACT WITH CONCRETE PAVEMENT SHALL BE COVERED WITH A LAYER OF TAR PAPER OR APPROVED EQUAL. THE COST FOR THE PAPER SHALL BE INCLUDED IN THE BID PRICE FOR THE TYPE OF CATCH BASIN INSTALLED.
4. USE 6'-0" (1.830m) ON UPGRADE SIDE OF CONTINUOUS GRADE AND 1'-0" (305mm) ON DOWNGRADE SIDE OF CONTINUOUS GRADE OR AS DIRECTED.
5. IF MASONRY UNITS ARE REQUIRED, THE BASIN SHALL BE CONSTRUCTED IN CONFORMANCE WITH THE OVER ALL DIMENSIONS SHOWN HERE AND SECTION 5.07 OF THE STATE OF CONNECTICUT'S STANDARD SPECIFICATIONS. CORBELLING SHALL BE PERMITTED TO A MAXIMUM OF 3" (75mm.) NO PROJECTION SHALL EXTEND INSIDE THE LIMITS NOTED BY **.
6. WALL THICKNESS OF ALL CB'S OVER 10' (3.048m) DEEP SHALL BE INCREASED TO 12" (305mm) THICK. INSIDE DIMENSION SHALL REMAIN THE SAME. 12" (305mm) THICKNESS WILL START AFTER THE FIRST 10' (3.048m).
7. TO CONVEY SUBSURFACE DRAINAGE, OPENINGS SHALL BE FORMED IN THE FOUR WALLS AT OR IMMEDIATELY ABOVE THE BOTTOM OF THE PERVIOUS BACKFILL.
8. MINIMUM CONCRETE COMPRESSIVE STRENGTH OF F'c = 4000 PSI (27,580 kPa) SHALL BE OBTAINED PRIOR TO SHIPPING.
9. LATEST STATE OF CONNECTICUT'S STANDARD SPECIFICATIONS AND SUPPLEMENTALS SHALL GOVERN.
10. SPACER MAY BE CMU OR PRECAST WITH REQUIRED REINFORCING (RECOMMENDED BY THE MANUFACTURER) AS NEEDED TO PROVIDE PROPER GRADE SHOWN ON PLANS.
11. TOP OF FRAME (TF) ELEVATION SHALL BE MEASURED IN THE CENTER OF GRATE @ GUTTER LINE.




DETAILS OF DEPRESSED GUTTER STRIP FOR TYPE "C" CATCH BASIN

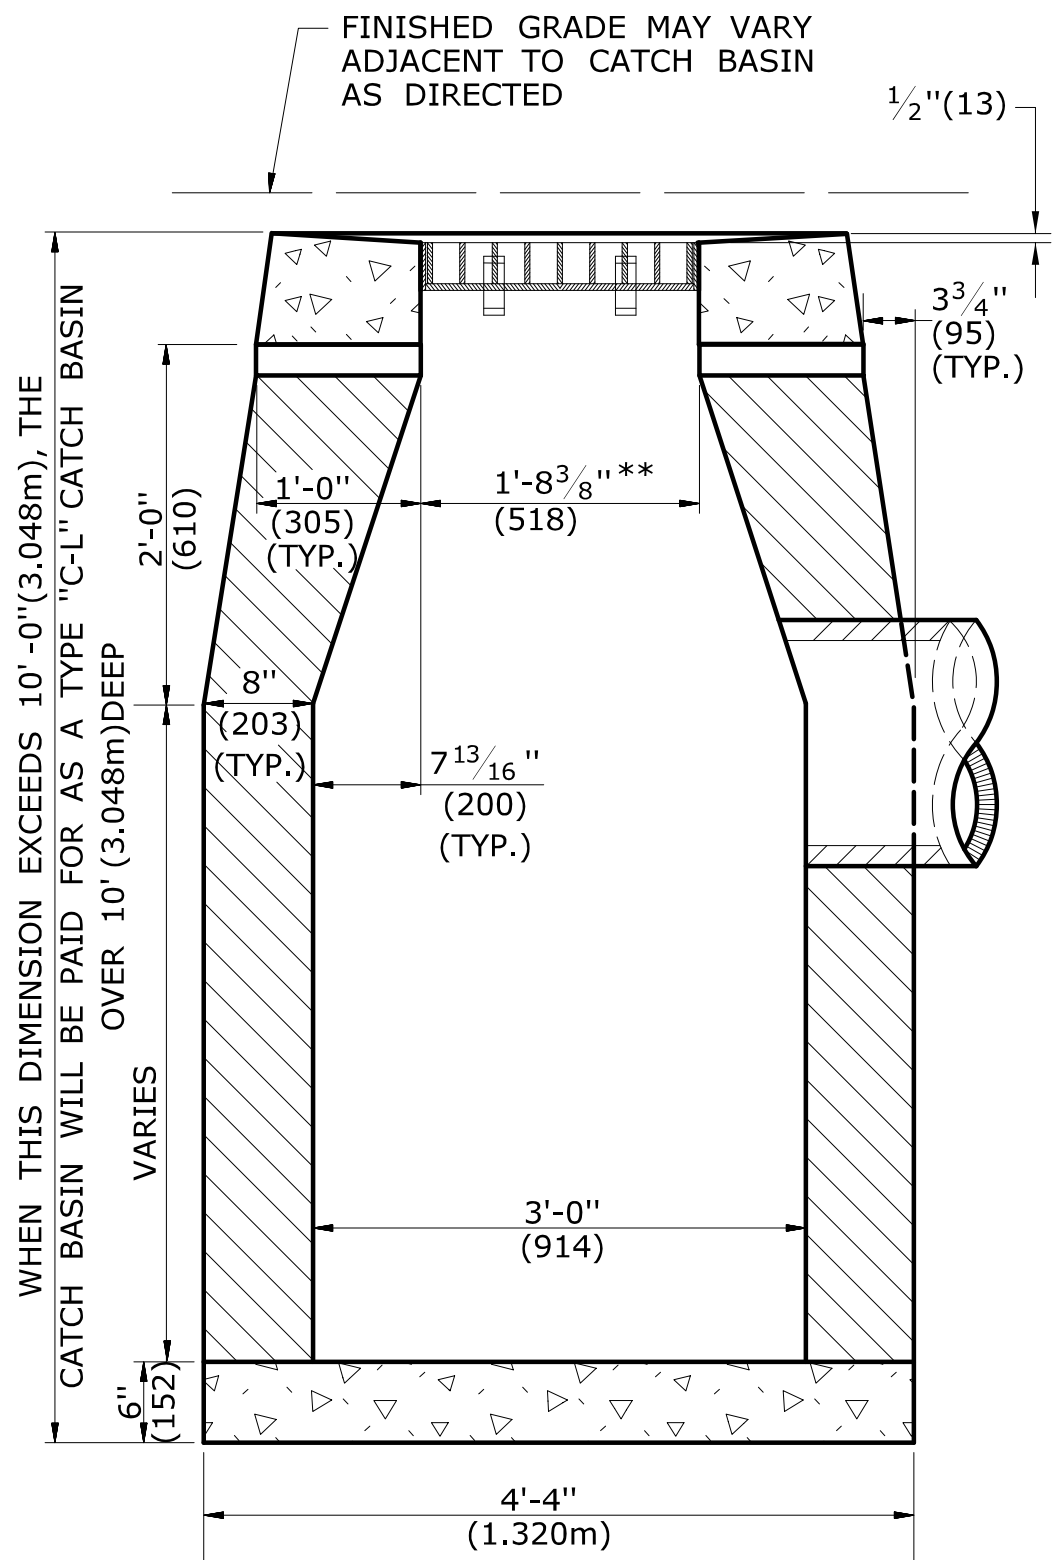ALL METRIC DIMENSIONS ARE IN MILLIMETERS (mm) UNLESS OTHERWISE NOTED.




SECTION B

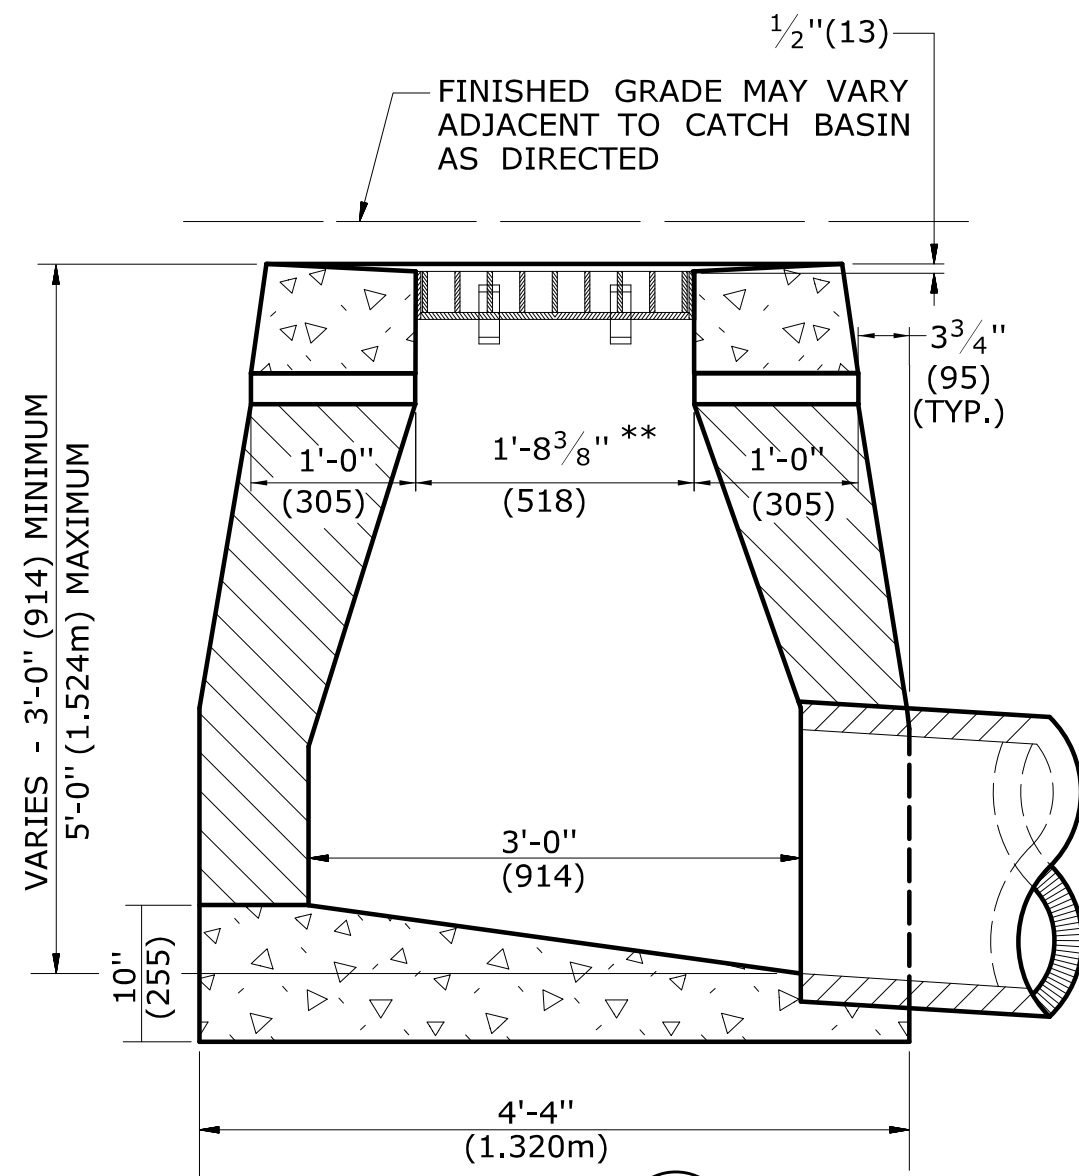TYPE "C-L" CATCH BASIN




SECTION B

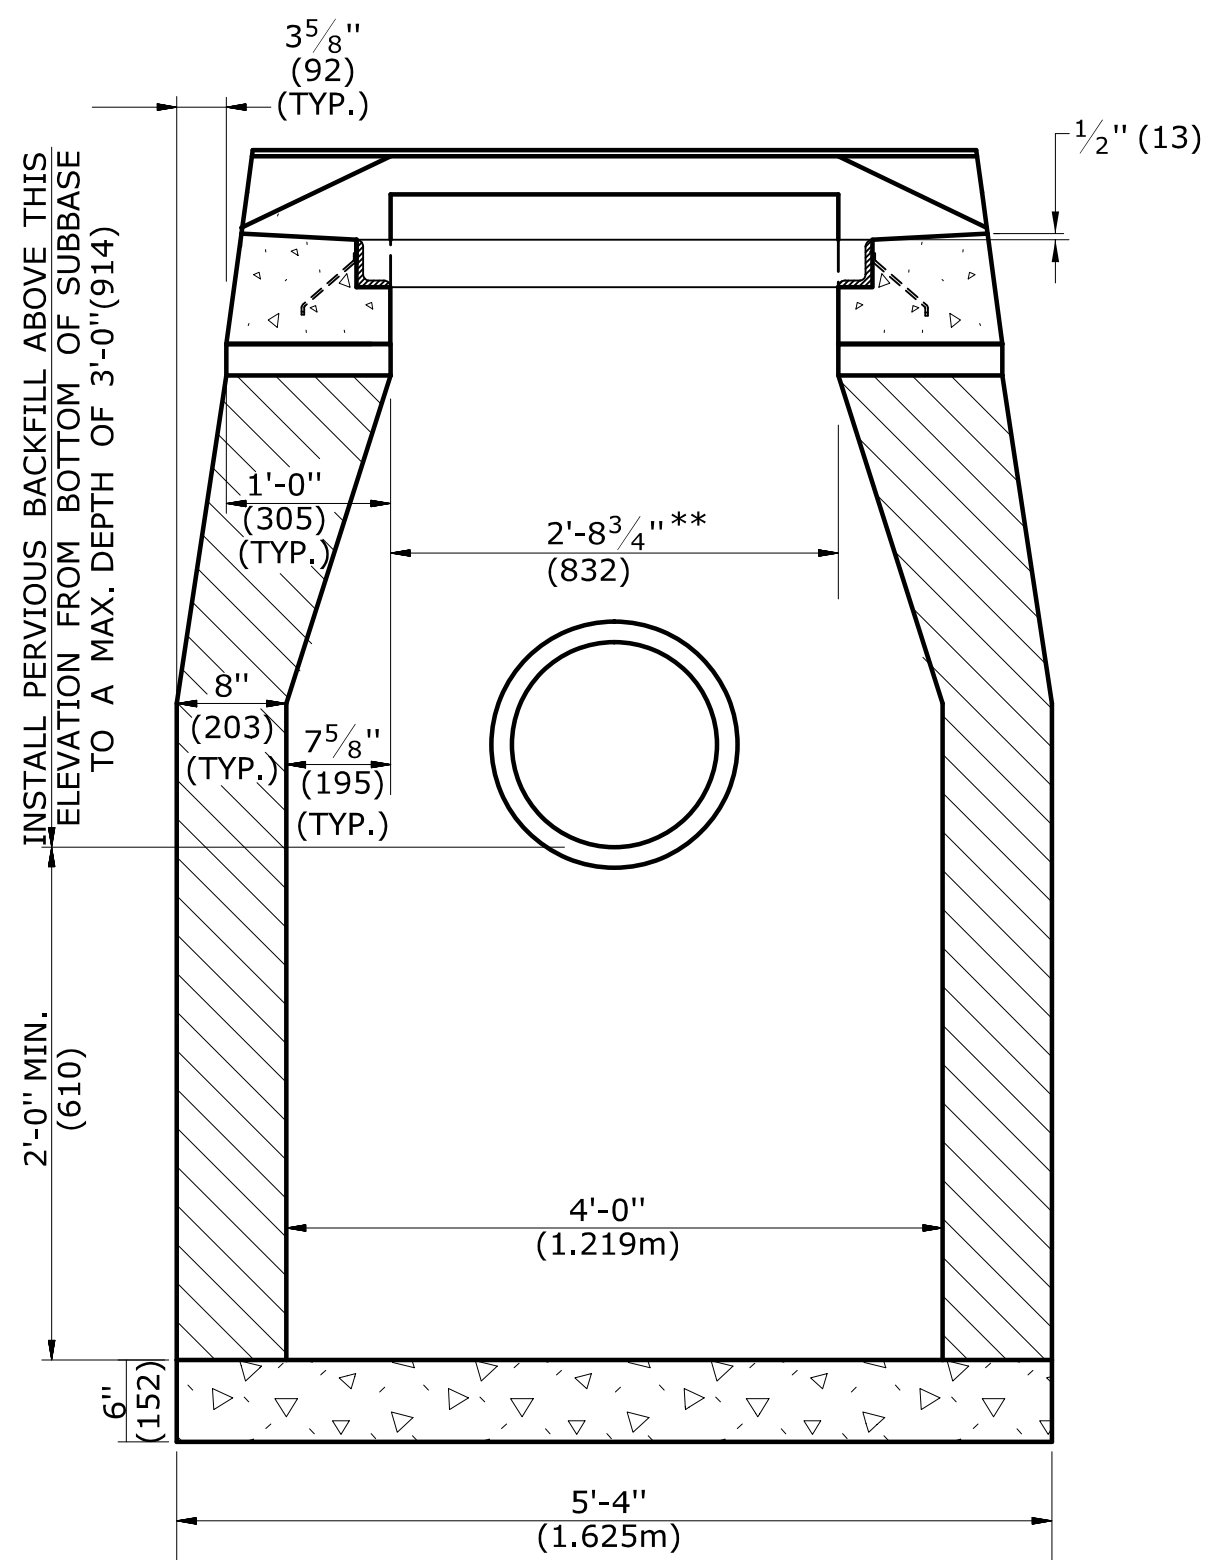TYPE "C-L" DROP INLET




SECTION A

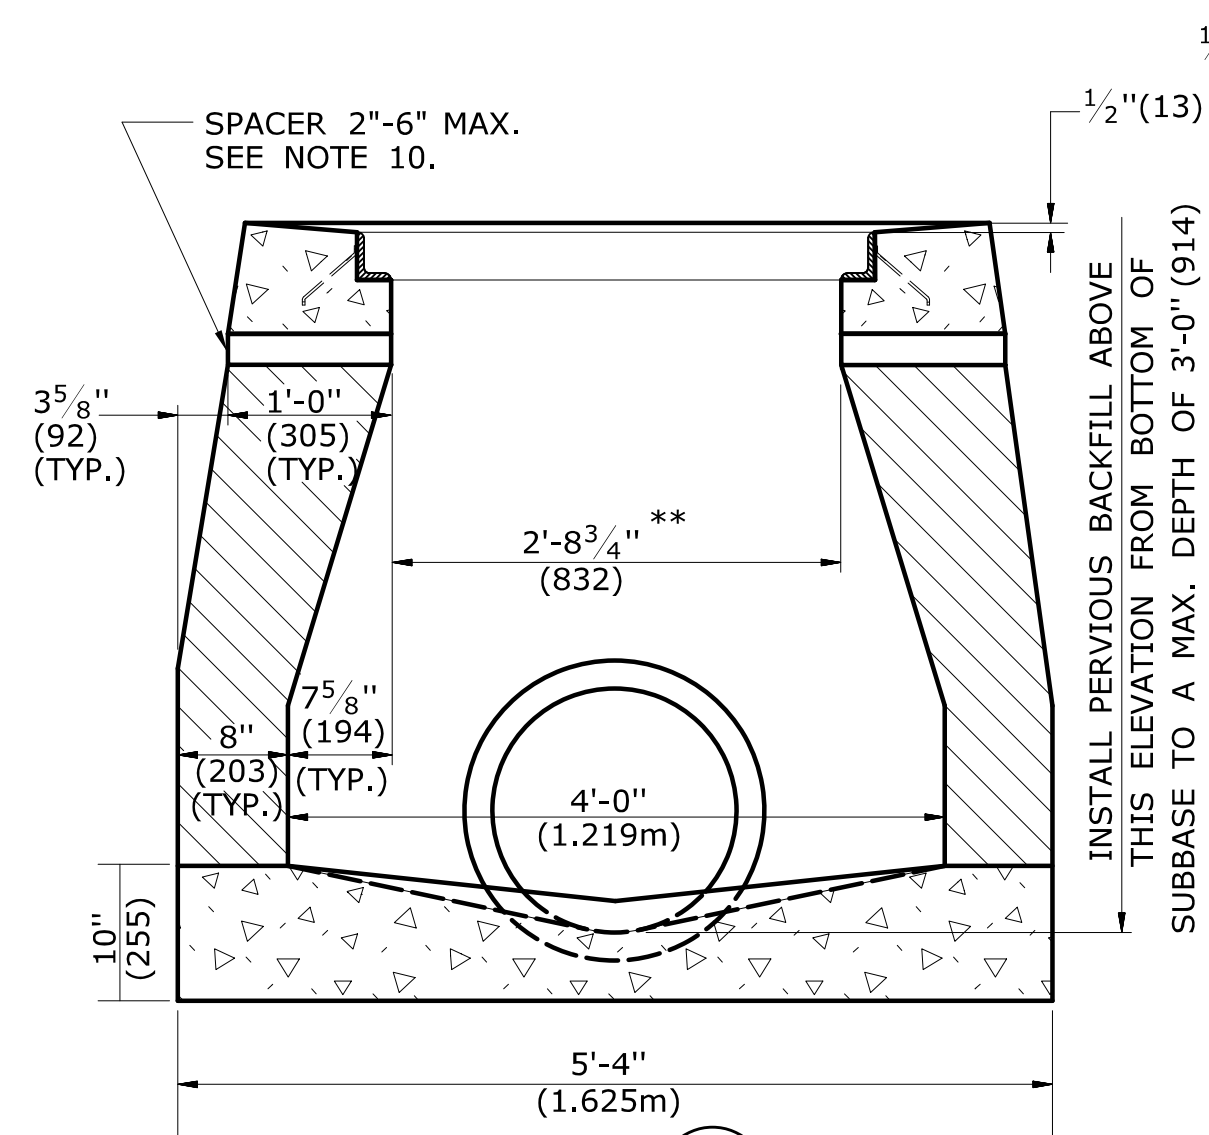TYPE "C" & "C-L" CATCH BASIN (TYPE "C" TOP SHOWN)




SECTION A

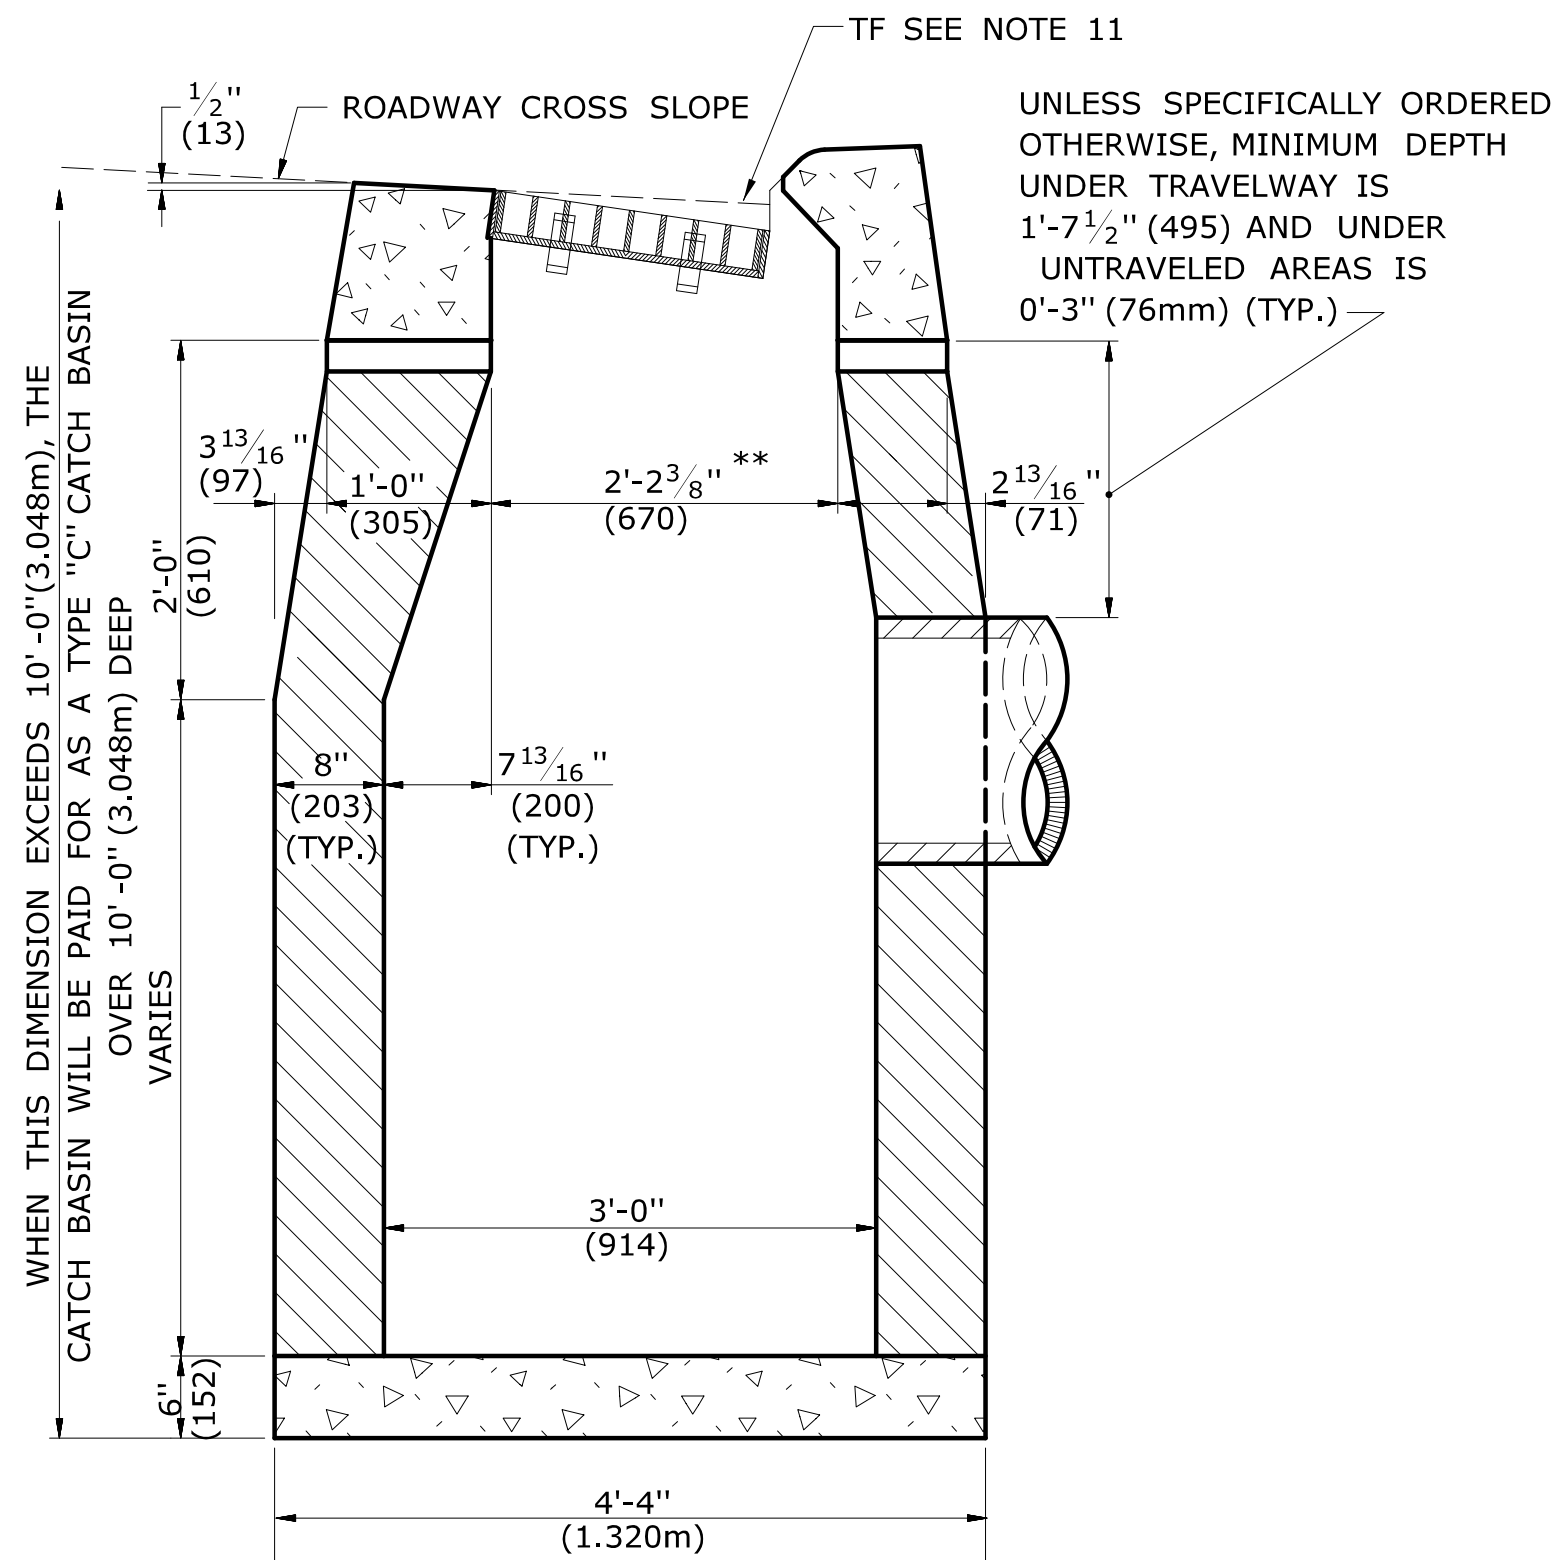TYPE "C" & "C-L" DROP INLET (TYPE "C-L" TOP SHOWN)



SECTION B

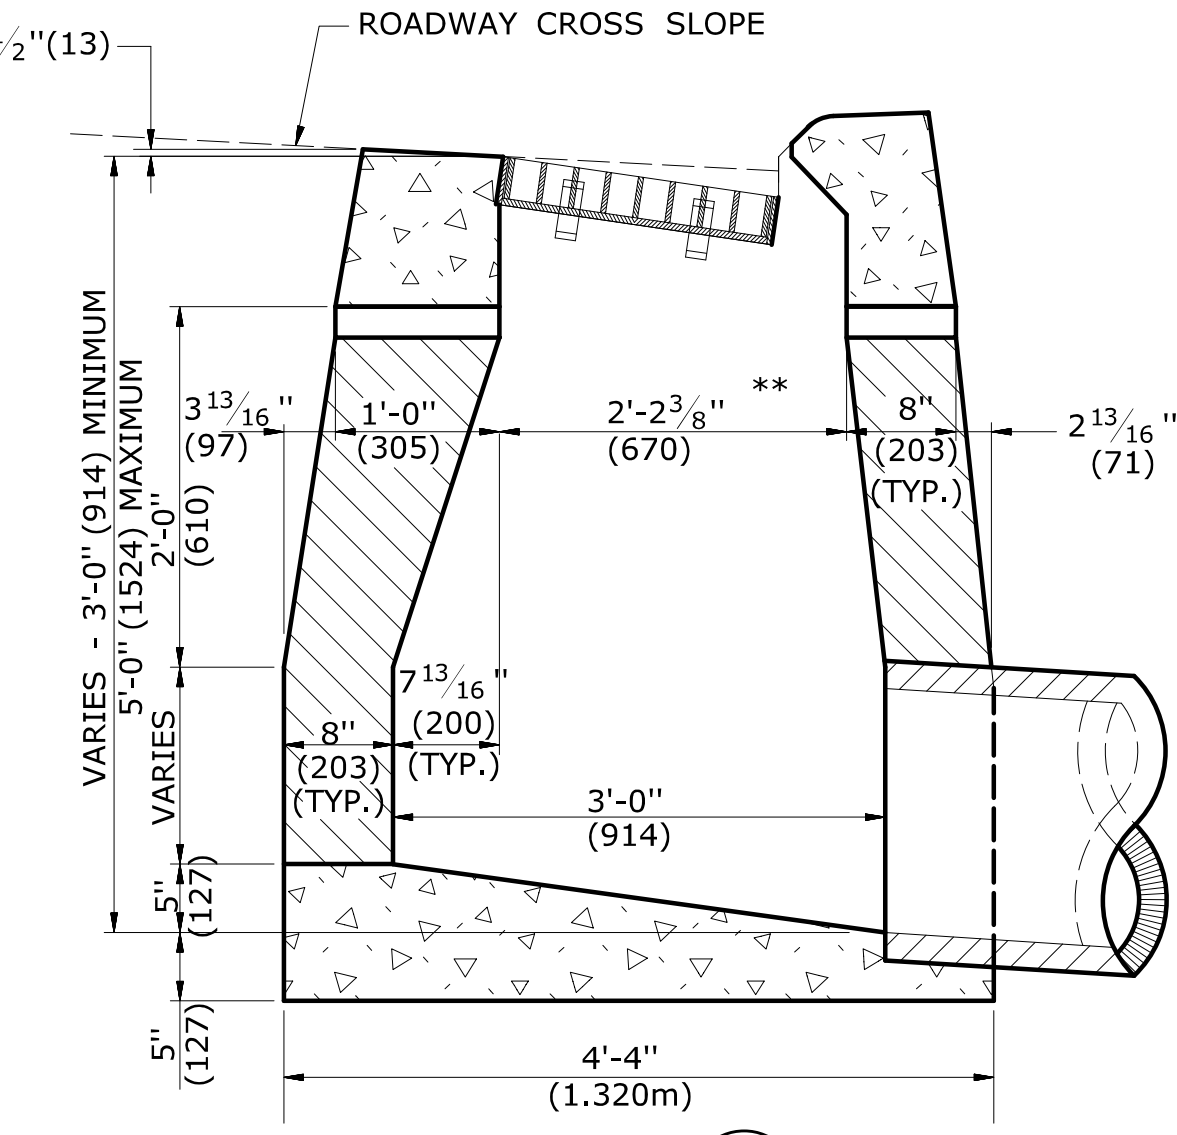TYPE "C" CATCH BASIN







SECTION B

TYPE "C" DROP INLET

TOWN OF BROOKFIELD, CT

URS CORPORATION 500 ENTERPRISE DRIVE, SUITE 3B ROCKY HILL, CT 06067 (860) 529-8882	PROJECT NAME: TOWN DISTRICT SIDEWALK AND ACCESS MANAGEMENT PLAN		
	SHEET TITLE: TYPE "C", "C-L" AND DROP INLET CATCH BASIN		
	FILE NAME:	PLOT DATE: 4/20/2016	DRAWING NO.: MDS-20
	PROJECT LEADER: SM	DRAWN BY: AG	SHEET NO.: 26
DESIGNED BY: AG		CHECKED BY: PG	

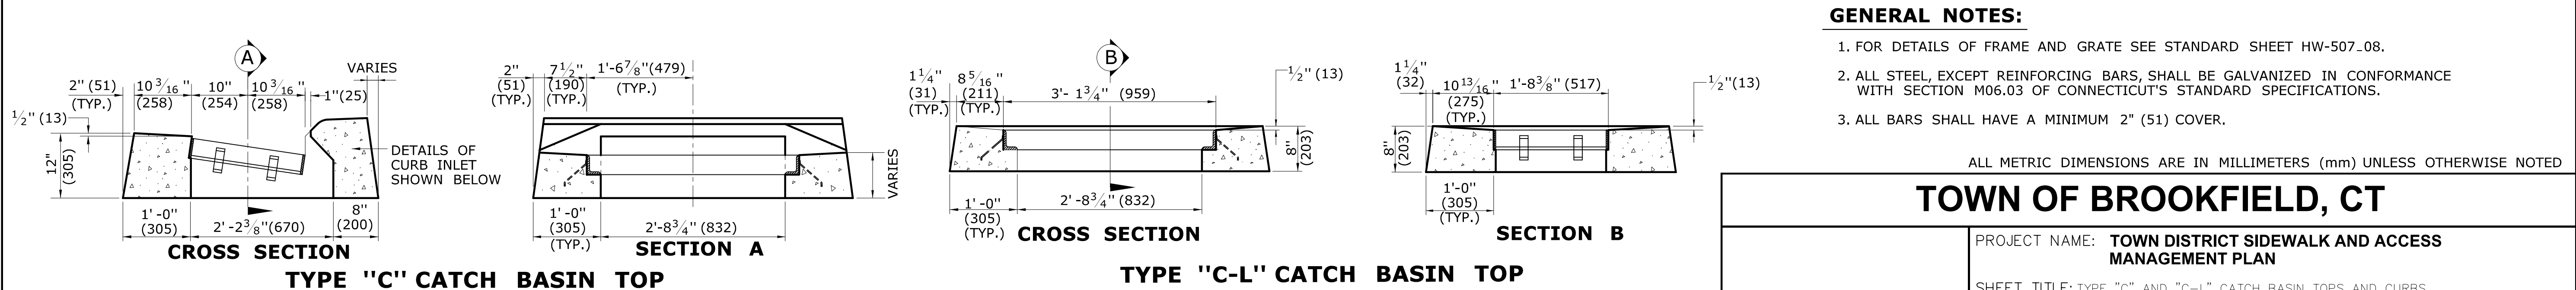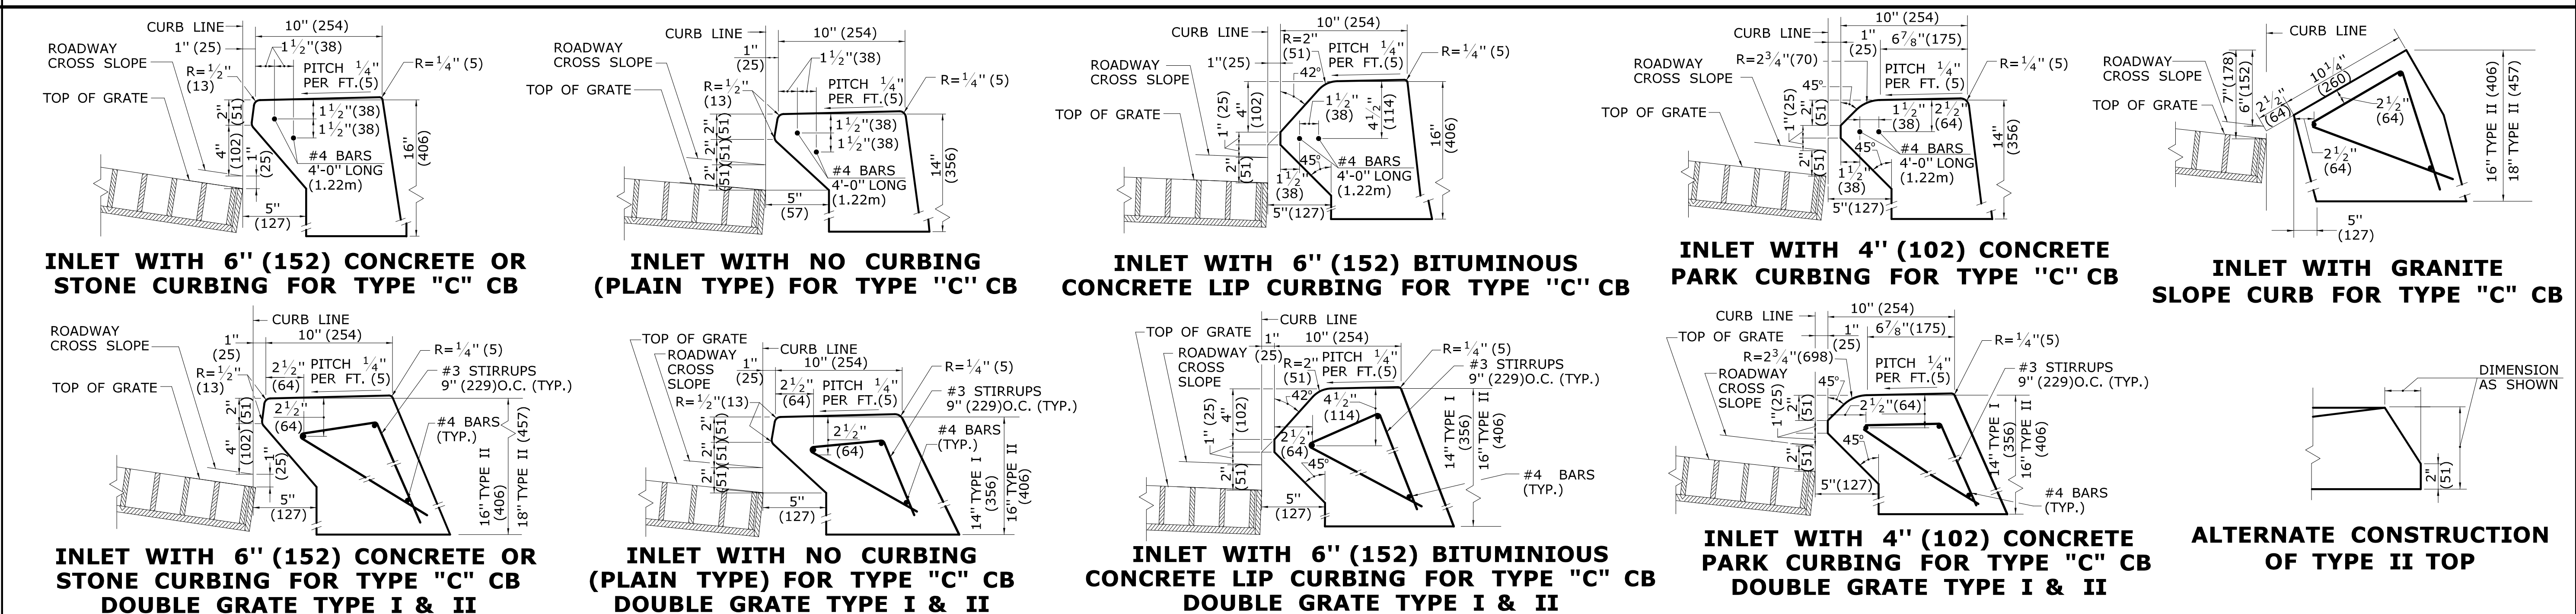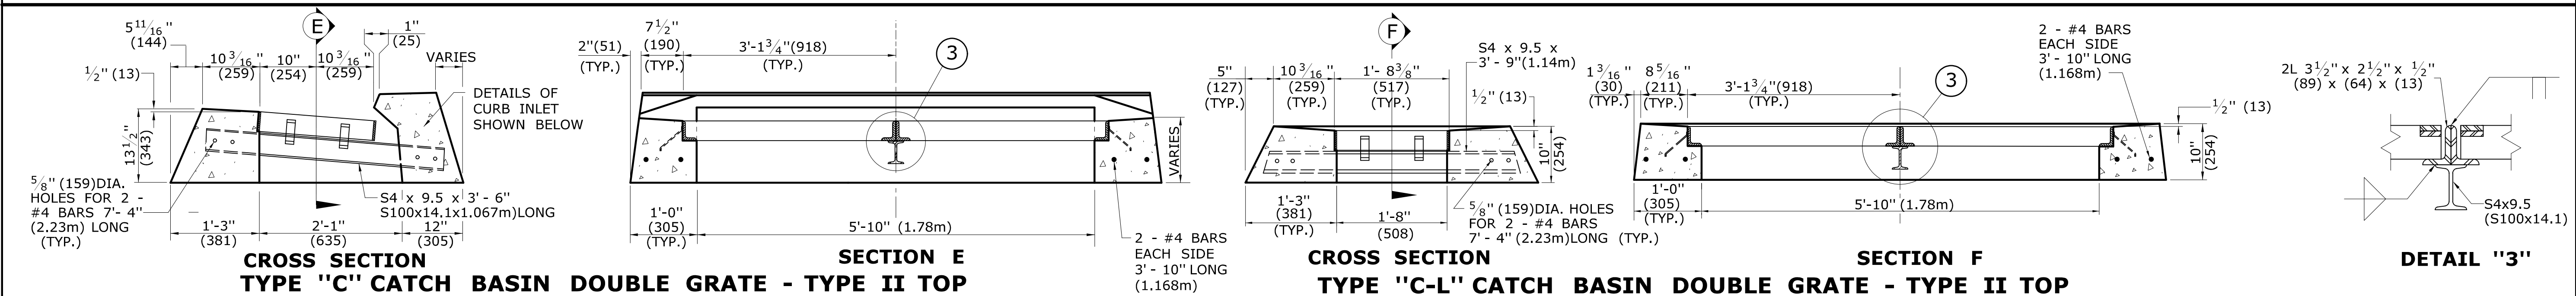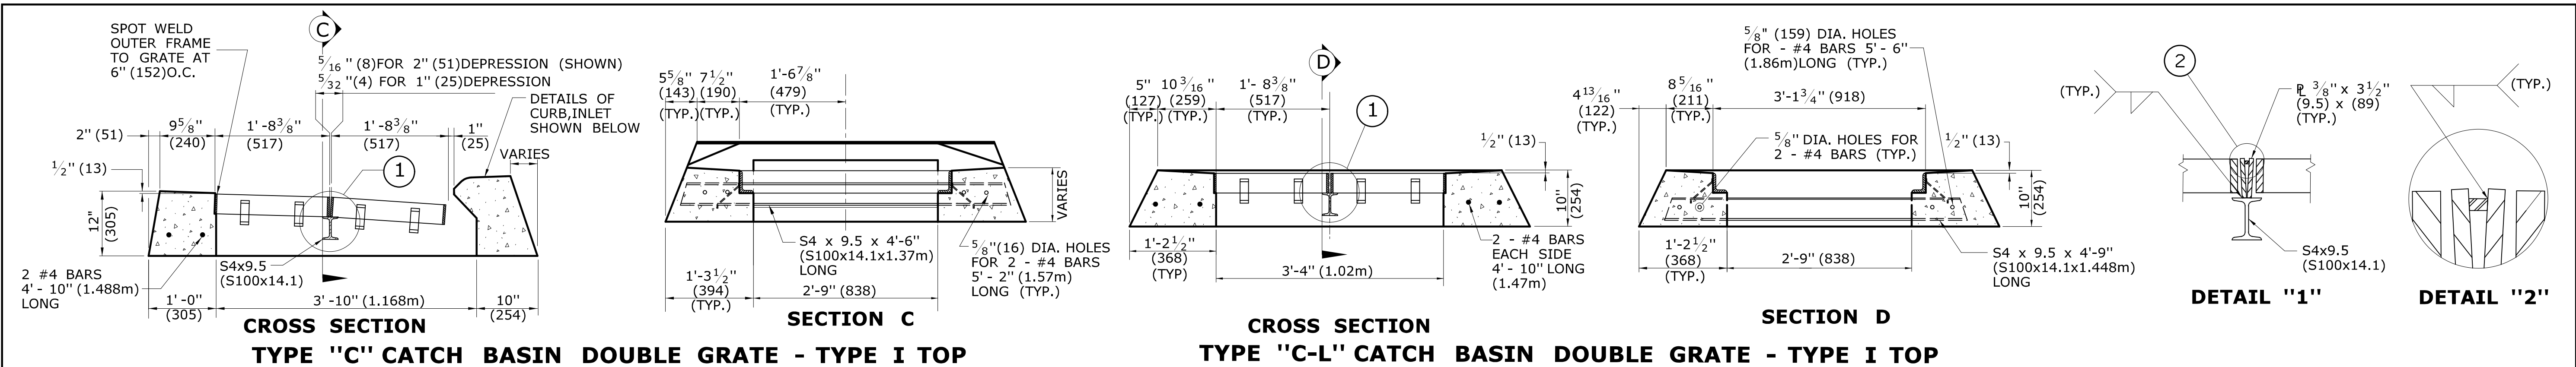

- GENERAL NOTES:**

1. FOR DETAILS OF FRAME AND GRATE SEE STANDARD SHEET HW-507-08.
2. ALL STEEL, EXCEPT REINFORCING BARS, SHALL BE GALVANIZED IN CONFORMANCE WITH SECTION M06.03 OF CONNECTICUT'S STANDARD SPECIFICATIONS.
3. ALL BARS SHALL HAVE A MINIMUM 2" (51) COVER.

ALL METRIC DIMENSIONS ARE IN MILLIMETERS (mm) UNLESS OTHERWISE NOTED

TOWN OF BROOKFIELD, CT

PROJECT NAME: **TOWN DISTRICT SIDEWALK AND ACCESS
MANAGEMENT PLAN**

SHEET TITLE: TYPE "C" AND "C-L" CATCH BASIN TOPS AND CURBS

FILE NAME:

PROJECT LEADER: SM

DESIGNED BY: AG


PLOT DATE: 4/20/2016

DRAWN BY: AG

CHECKED BY: PG


DRAWING NO.:	MDS-21
SHEET NO.:	27
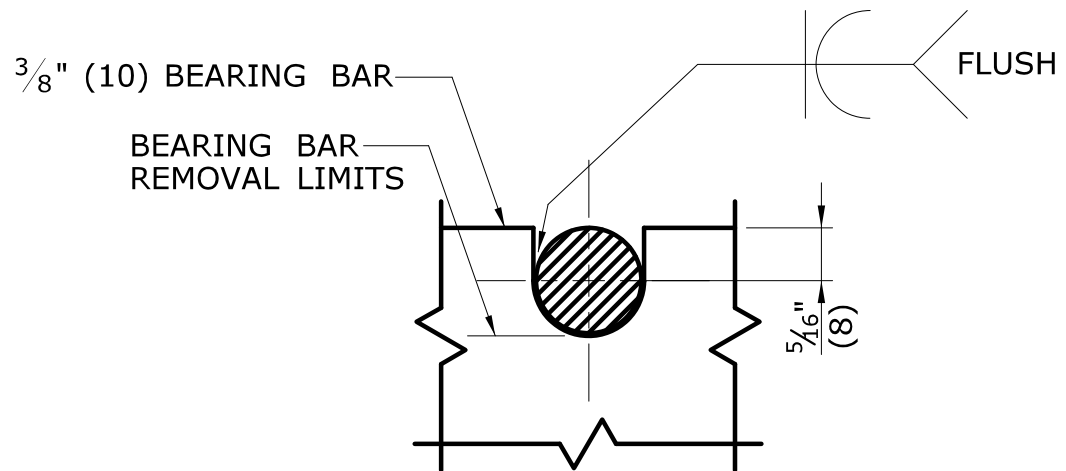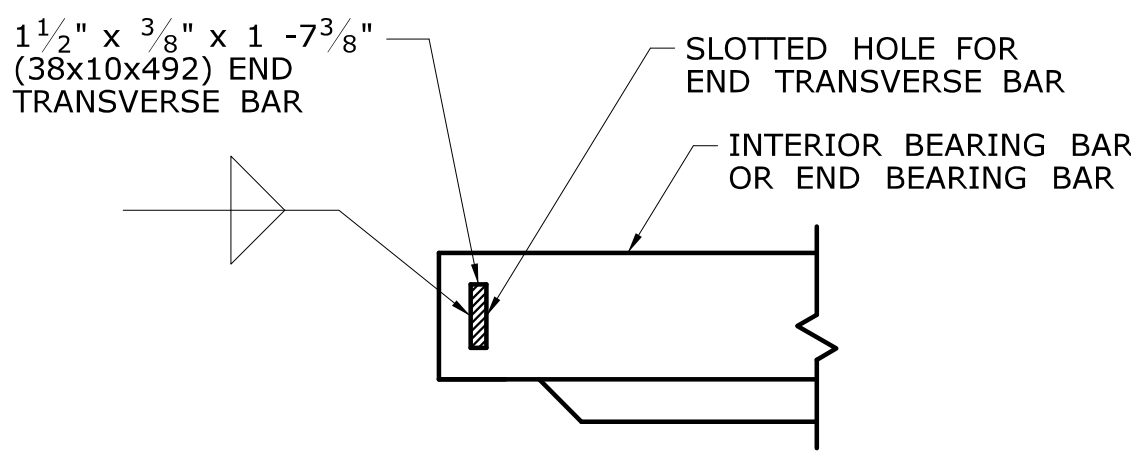
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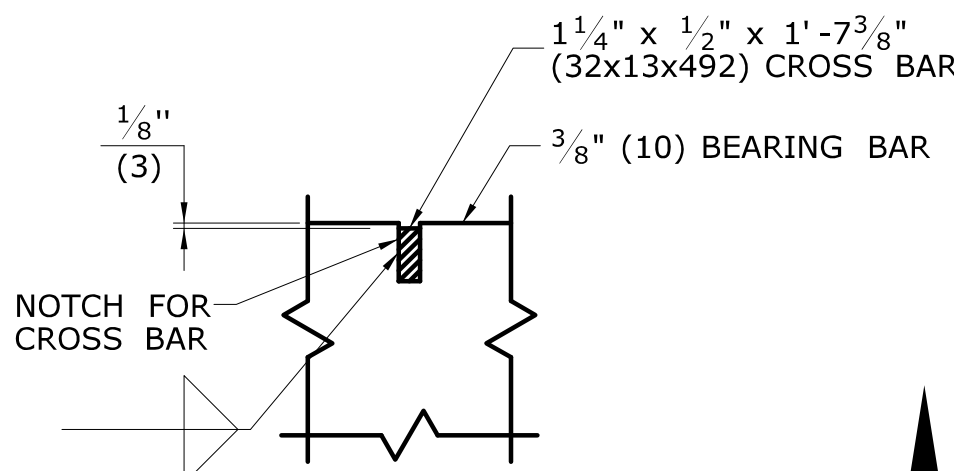


NOTE:
5/8" (16) DIA. ROUND BAR SHALL CONTACT BEARING BAR AT BOTTOM AND BE FLUSH AT TOP.

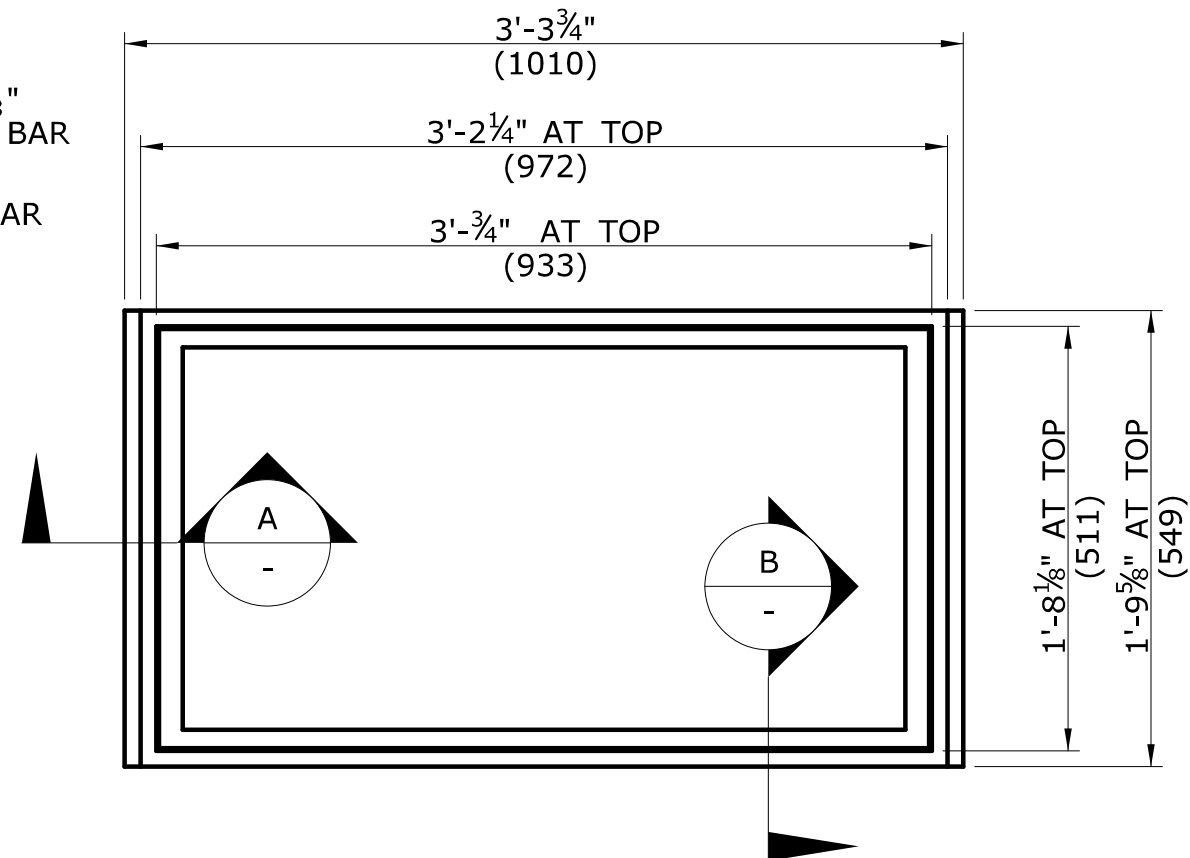
**ROUND BAR ATTACHMENT
CATCH BASIN GRATE TYPE A**



**END TRANSVERSE BAR ATTACHMENT
CATCH BASIN GRATE TYPE A & B**




**CROSS BAR ATTACHMENT
CATCH BASIN GRATE TYPE B**




PLAN

GENERAL NOTES:

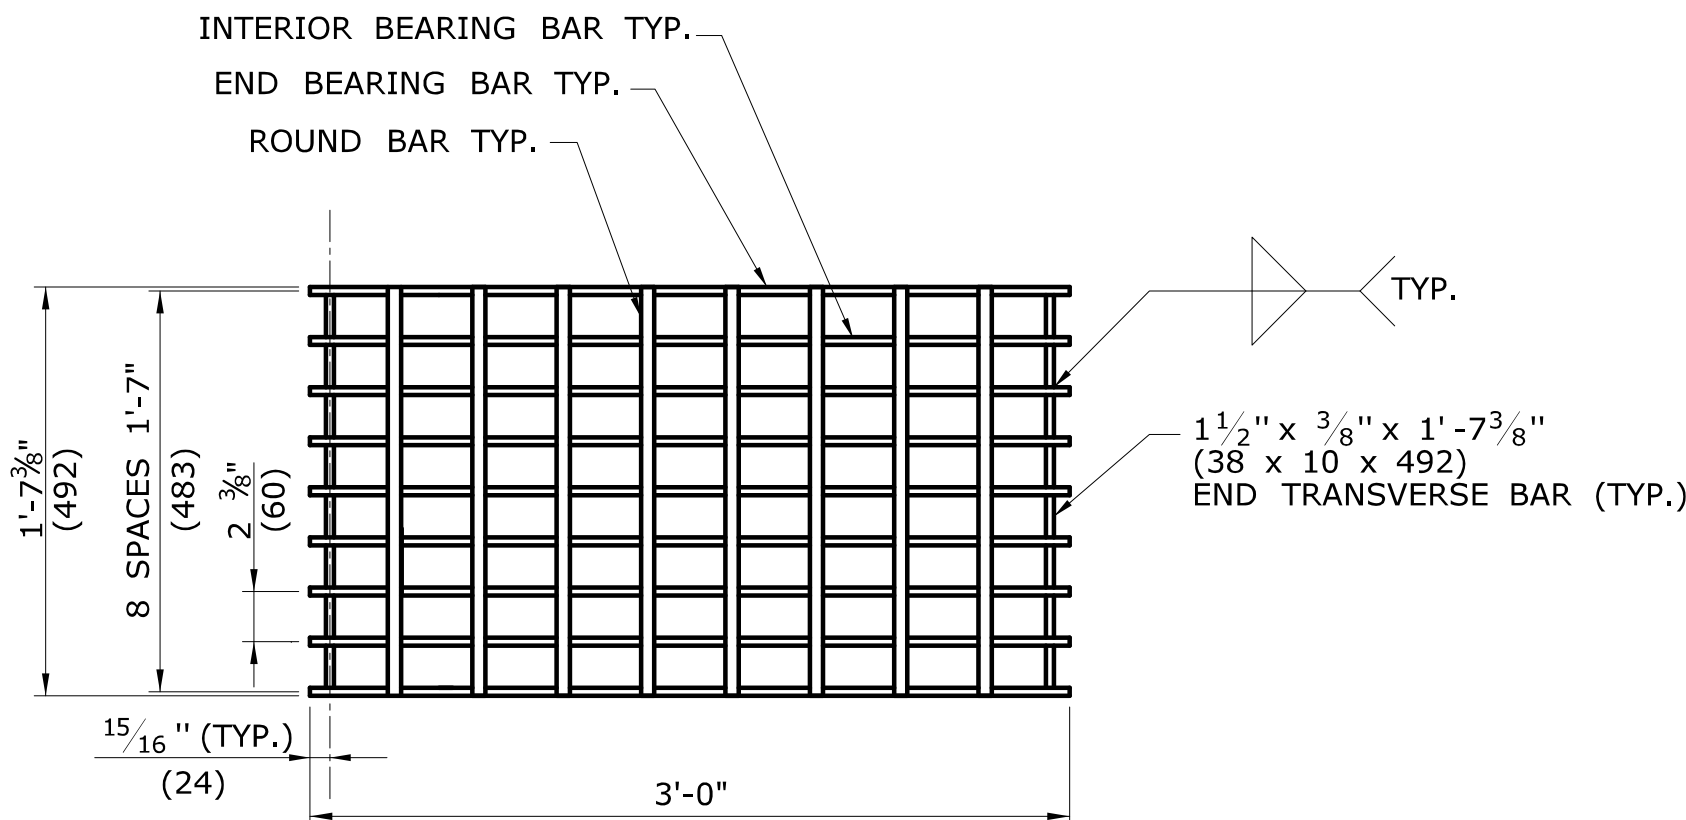
- STEEL OR CAST IRON SHALL BE USED FOR FRAMES. STEEL SHALL BE USED FOR TYPE "A" & "B" GRATES.
- TYPE "A" GRATES SHALL BE USED ON ALL ROADWAYS WHERE BICYCLE TRAFFIC IS ALLOWED OR AS DIRECTED BY THE ENGINEER.
- TYPE "B" GRATES SHALL BE USED ON ALL LIMITED ACCESS HIGHWAYS, RAMPS AND WHERE BICYCLE TRAFFIC IS NOT ALLOWED OR AS DIRECTED BY THE ENGINEER.
- STEEL FRAMES AND GRATES SHALL BE GALVANIZED IN ACCORDANCE WITH ARTICLE M.06.03.
- DO NOT GALVANIZE CAST IRON FRAMES.
- DIMENSIONAL TOLERANCES SHALL BE $\pm 1/16$ " (1.6).
- ALL STEEL BARS SHALL BE WELDED AT ALL INTERSECTIONS.
- ALL WELDING SHALL CONFORM TO THE REQUIREMENTS OF AWS STRUCTURAL WELDING CODE, D1.1.




PLAN

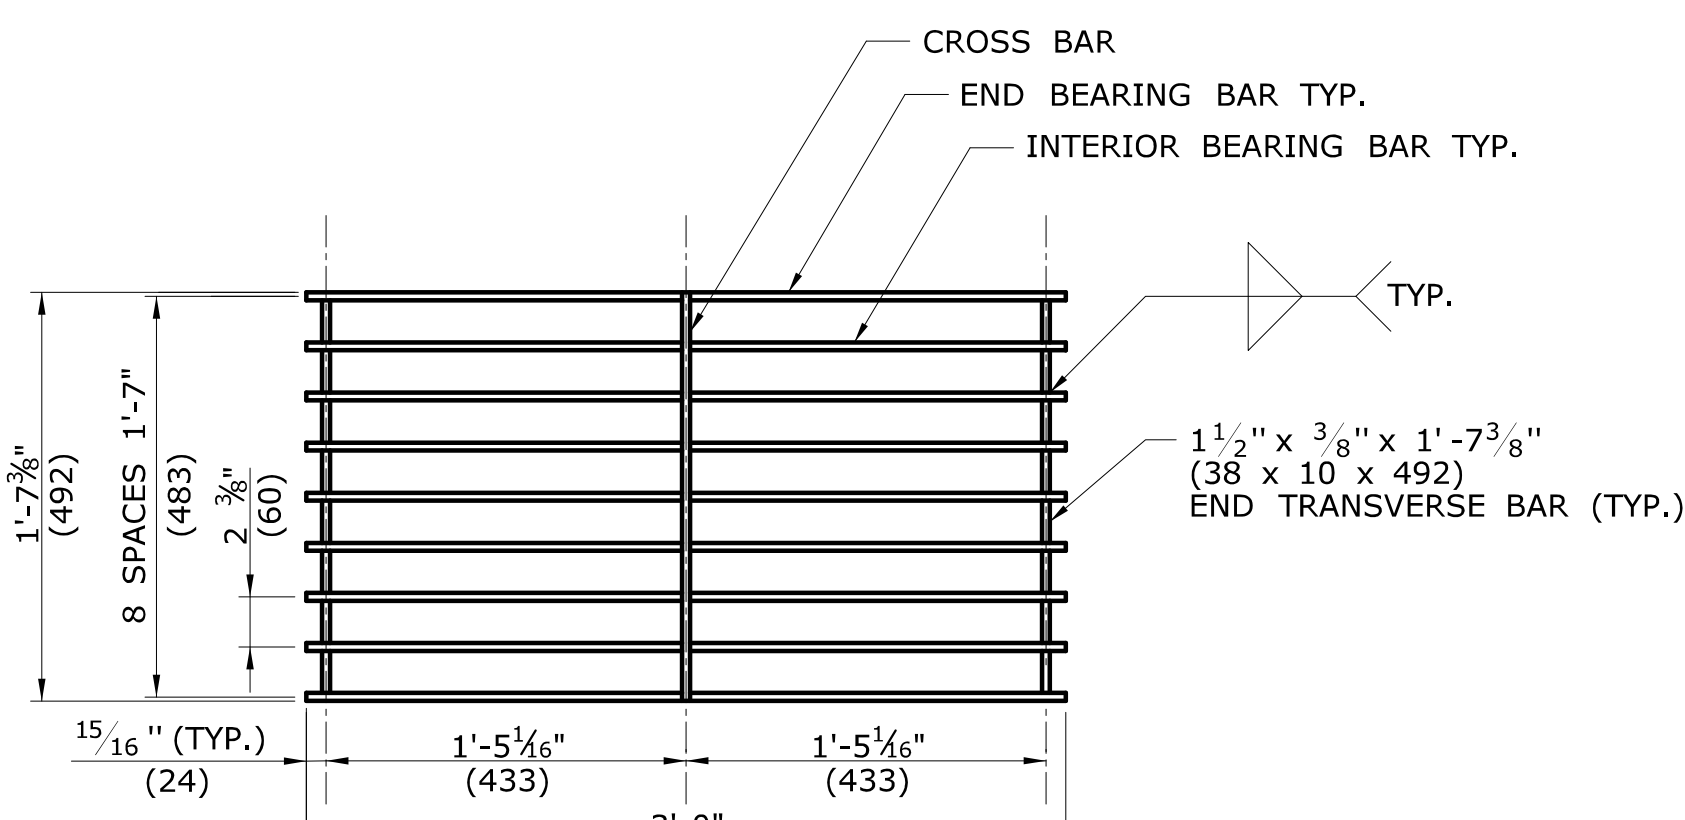


PLAN

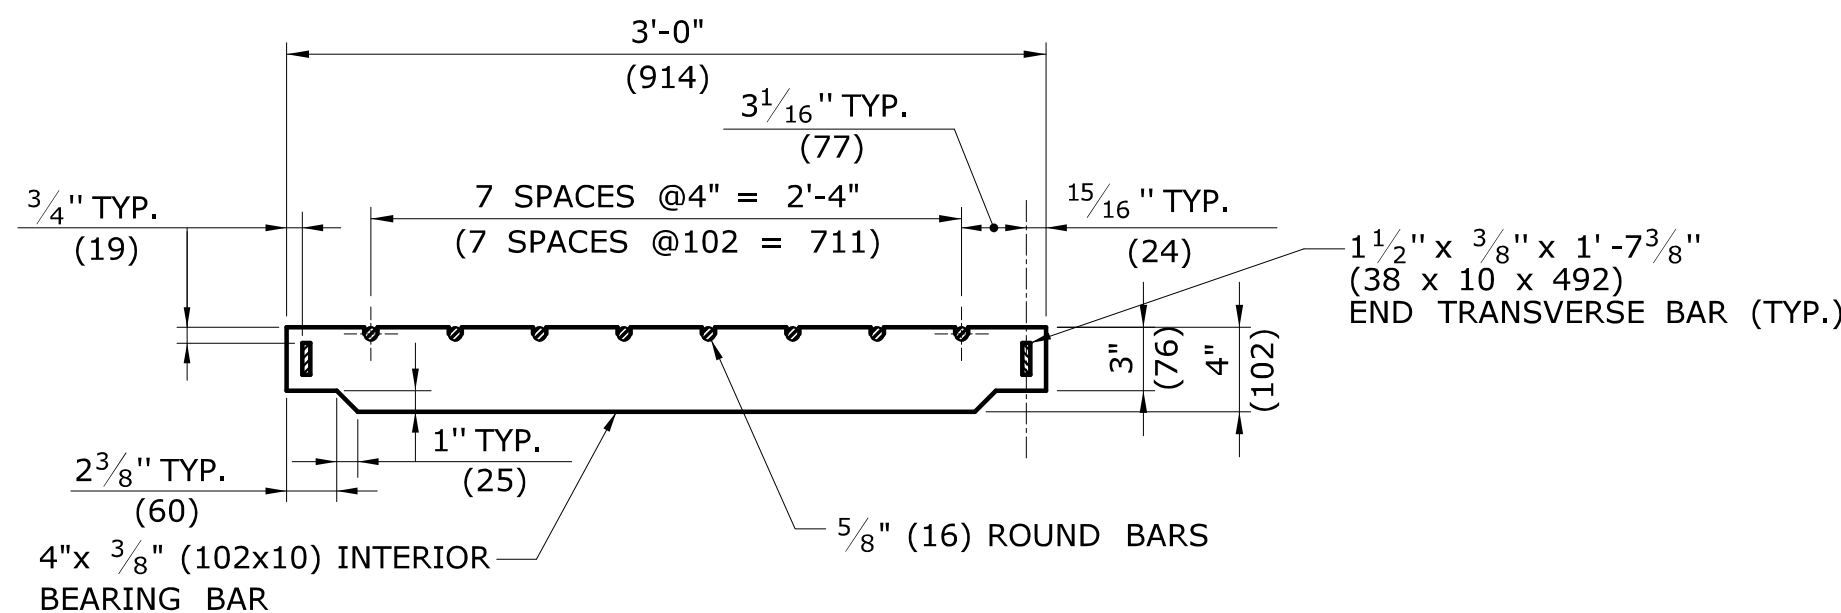


ELEVATION- INTERIOR BEARING BAR

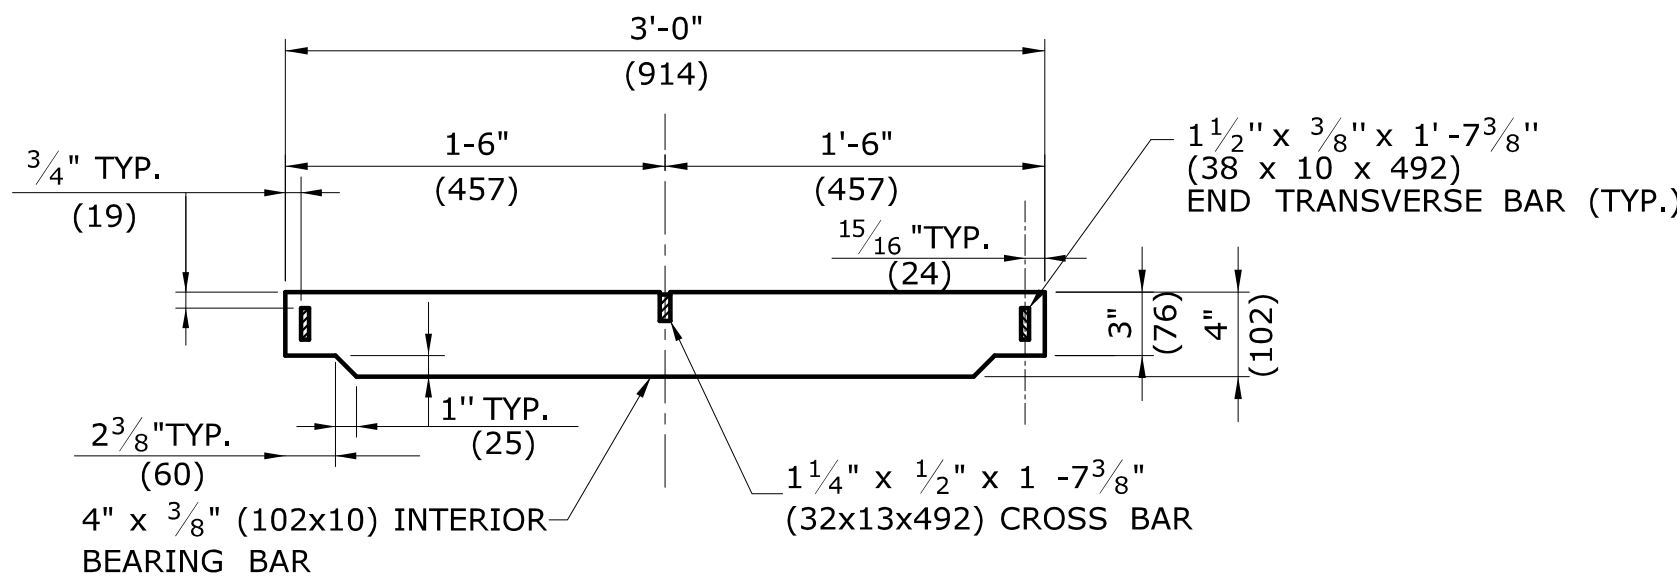


ELEVATION- INTERIOR BEARING BAR

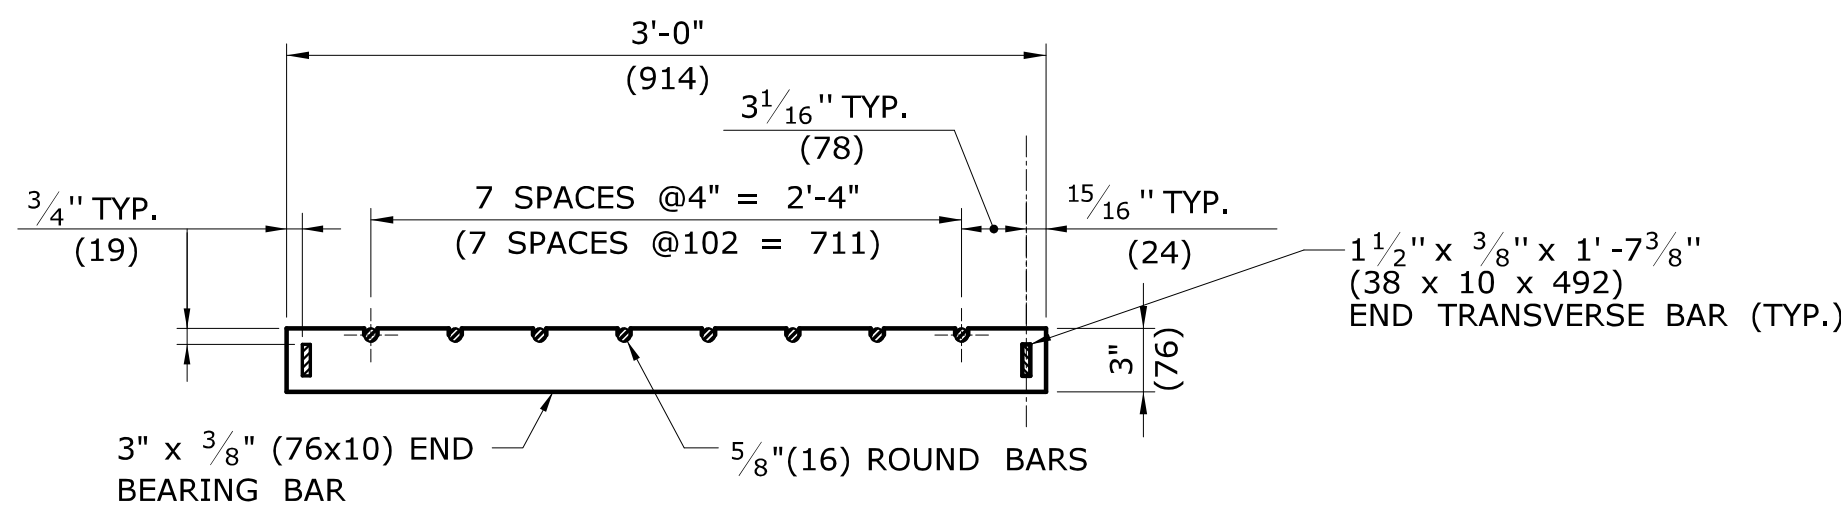

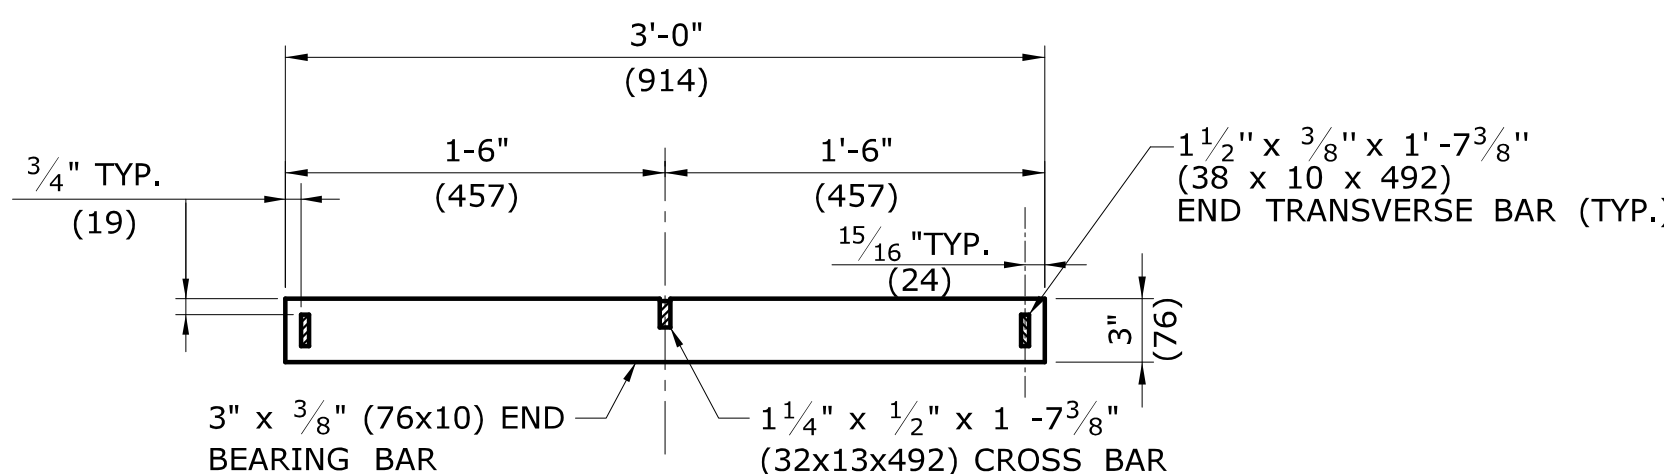
**ELEVATION- END BEARING BAR
CATCH BASIN GRATE TYPE A**



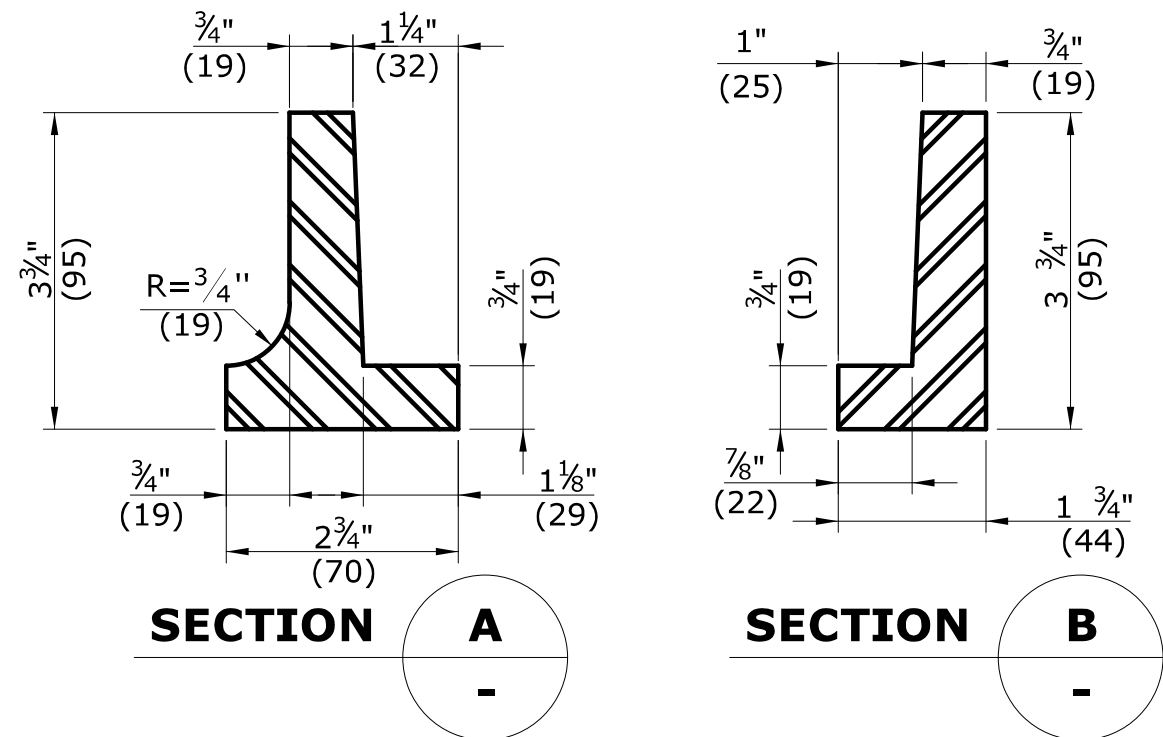**ELEVATION- END BEARING BAR
CATCH BASIN GRATE TYPE B**



CAST IRON FRAME ALTERNATE

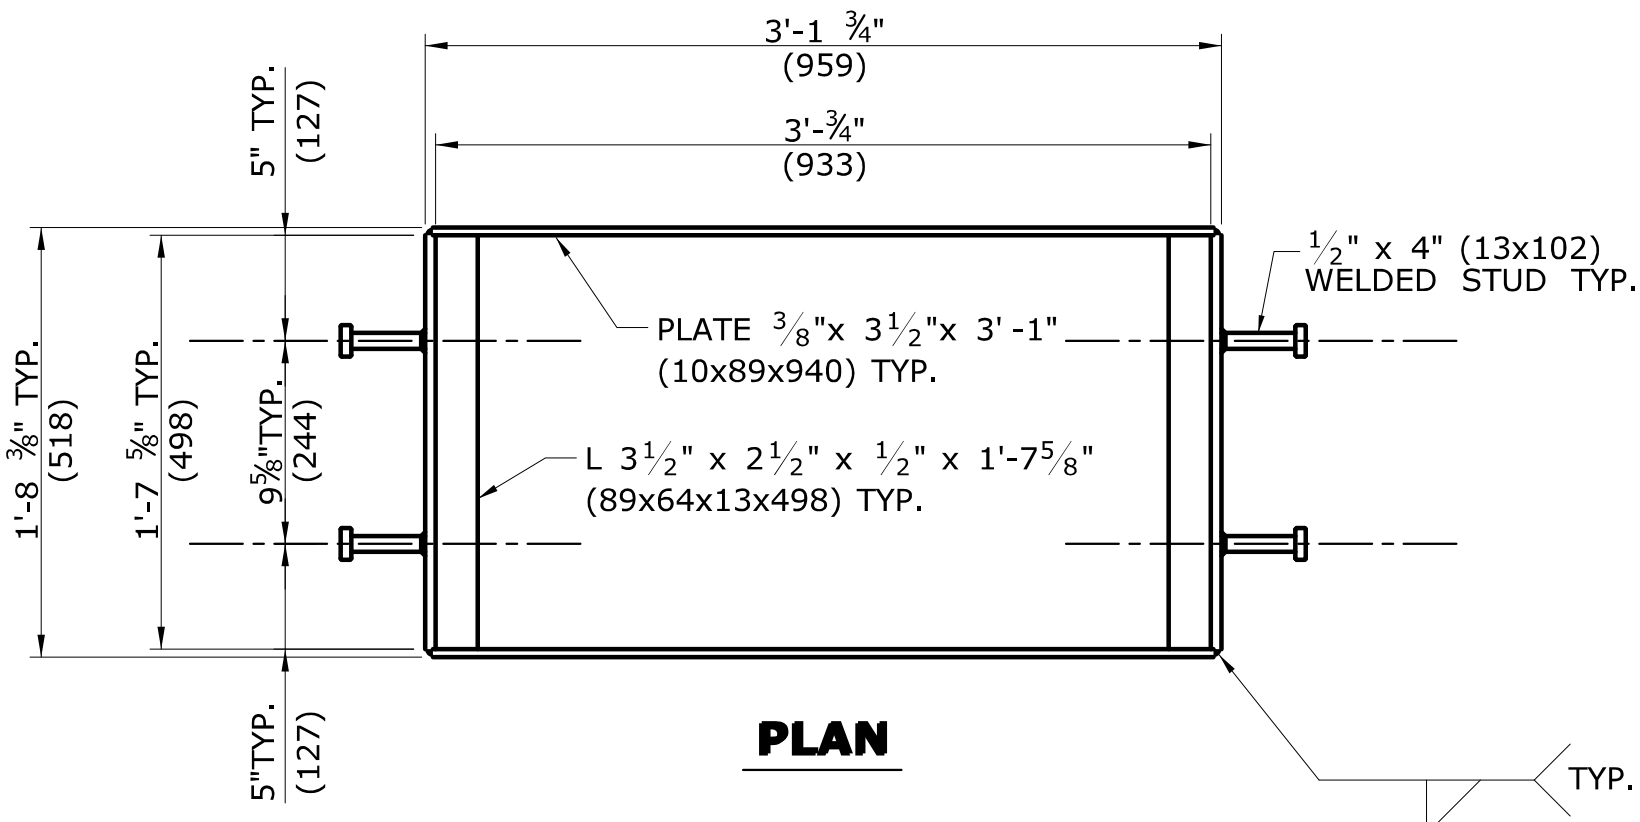

PLAN




**WELDED STUD ANCHOR DETAILS
STEEL FRAME**

ALL METRIC DIMENSIONS ARE IN MILLIMETERS (mm) UNLESS OTHERWISE NOTED


TOWN OF BROOKFIELD, CT

PROJECT NAME: TOWN DISTRICT SIDEWALK AND ACCESS MANAGEMENT PLAN			
SHEET TITLE: CATCH BASIN FRAMES AND GRATES			
URS CORPORATION 500 ENTERPRISE DRIVE, SUITE 3B ROCKY HILL, CT 06067 (860) 529-8882	FILE NAME:	PLOT DATE: 4/20/2016	DRAWING NO.: MDS-22
	PROJECT LEADER: SM	DRAWN BY: AG	SHEET NO.: 28
	DESIGNED BY: AG	CHECKED BY: PG	
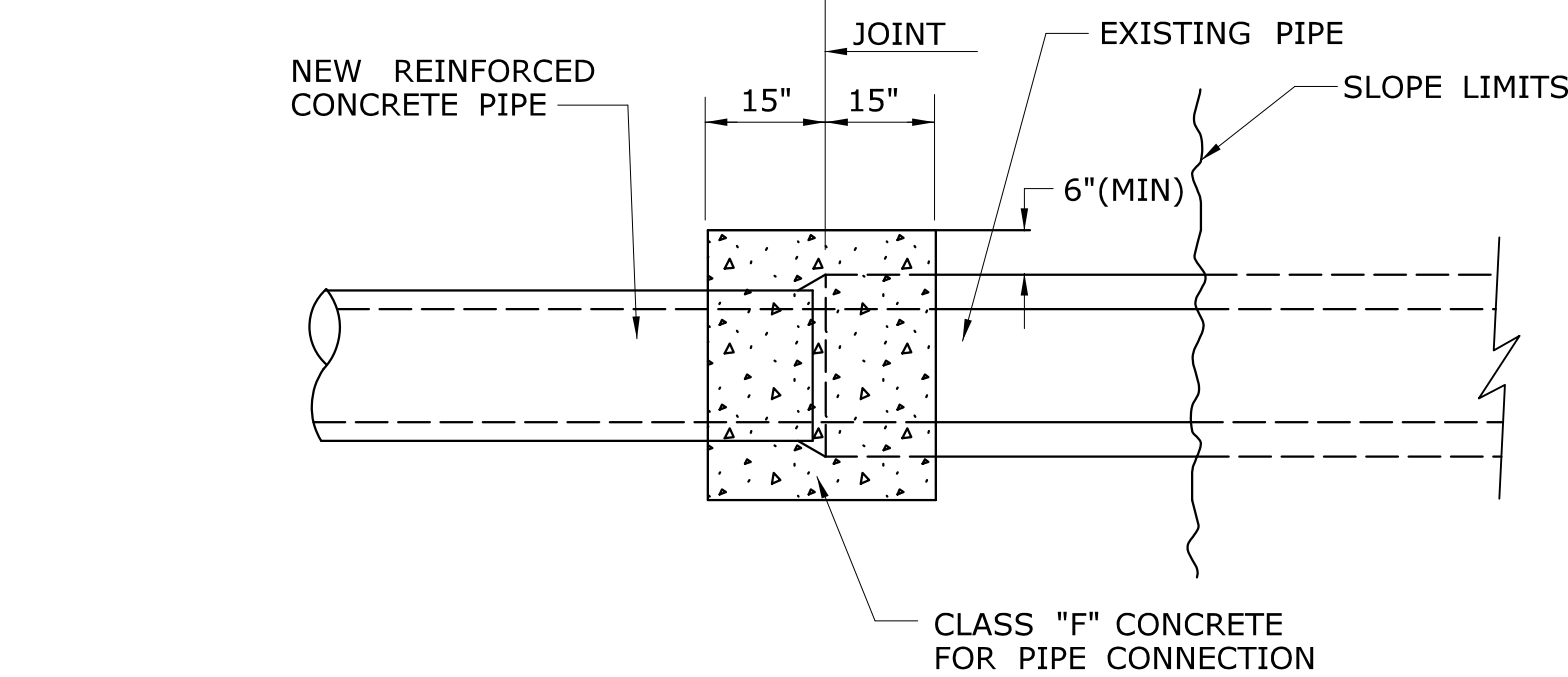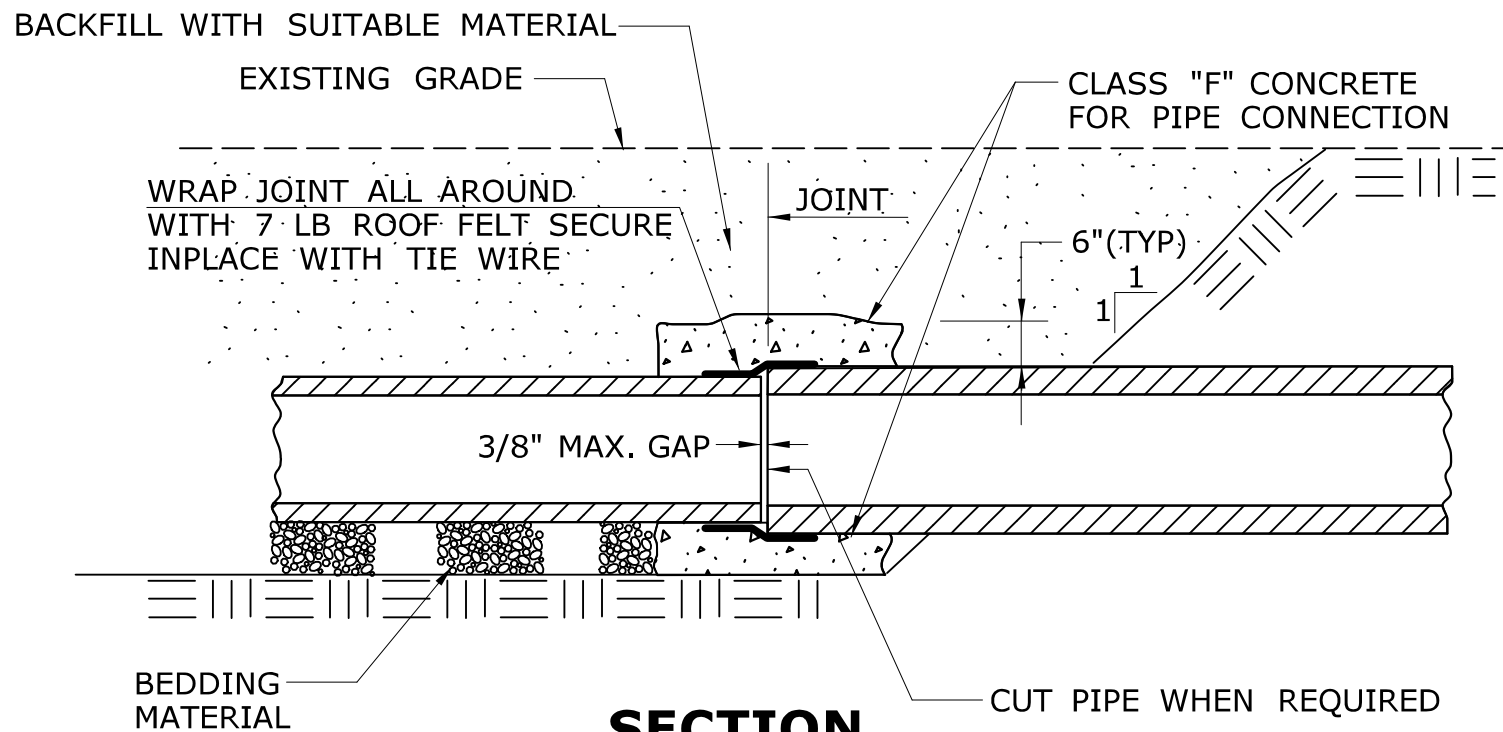
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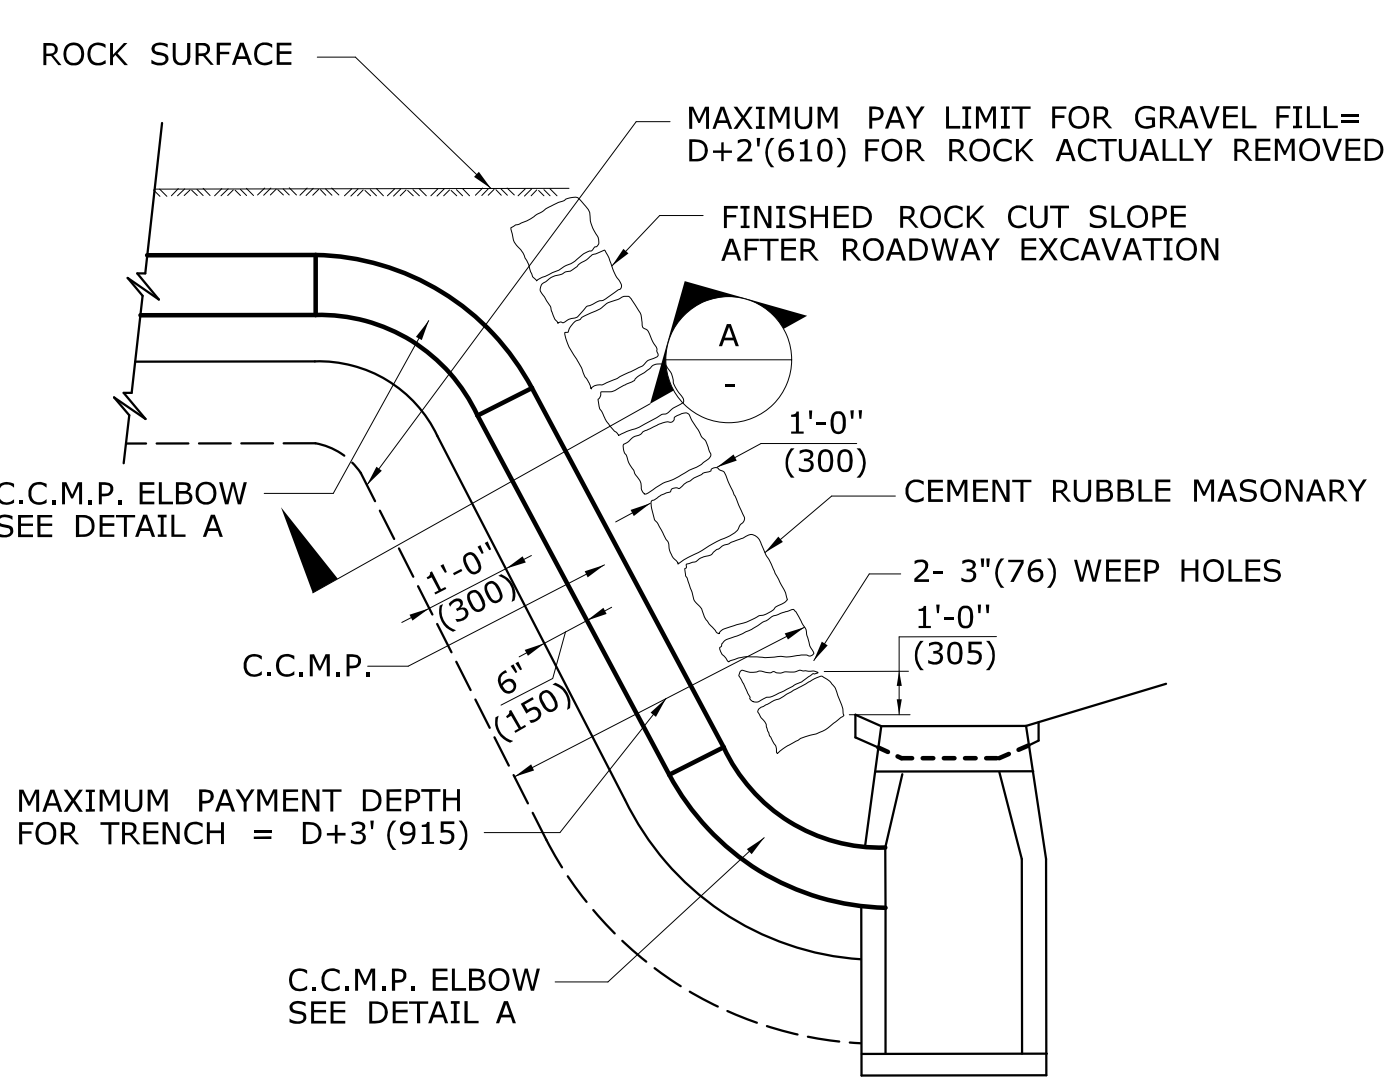
PLAN




SECTION
CONCRETE PIPE CONNECTION

NOTES:


1. "CONCRETE PIPE CONNECTION" IS INTENDED FOR USE WHERE A REINFORCED CONCRETE PIPE REPAIR OR MODIFICATION IS NEEDED SOMEWHERE WITHIN A PIPE RUN WHERE A BELL/SPIGOT JOINT CANNOT BE ACHIEVED.
2. MAINTAIN INTERIOR ALIGNMENT OF PIPE AT JOINTS UNTIL CONCRETE IS PROPERLY CURED.
3. BACKFILL OF PIPE REPAIR WITH SUITABLE MATERIAL MAY NOT TAKE PLACE UNTIL CONCRETE IS PROPERLY CURED.
4. CONTRACTOR SHALL MAINTAIN LINE AND GRADE OF PIPE REPAIR OR MODIFICATION BY METHODS APPROVED BY THE ENGINEER.
5. HOLES OR GAPS AT JOINT LARGER THAN 3/8" SHALL BE FILLED OR WRAPPED TO PREVENT CONCRETE FROM ENTERING PIPE.
6. TRENCH EXCAVATION SHALL BE TO THE MAXIMUM EXTENT NEEDED TO PERFORM WORK.



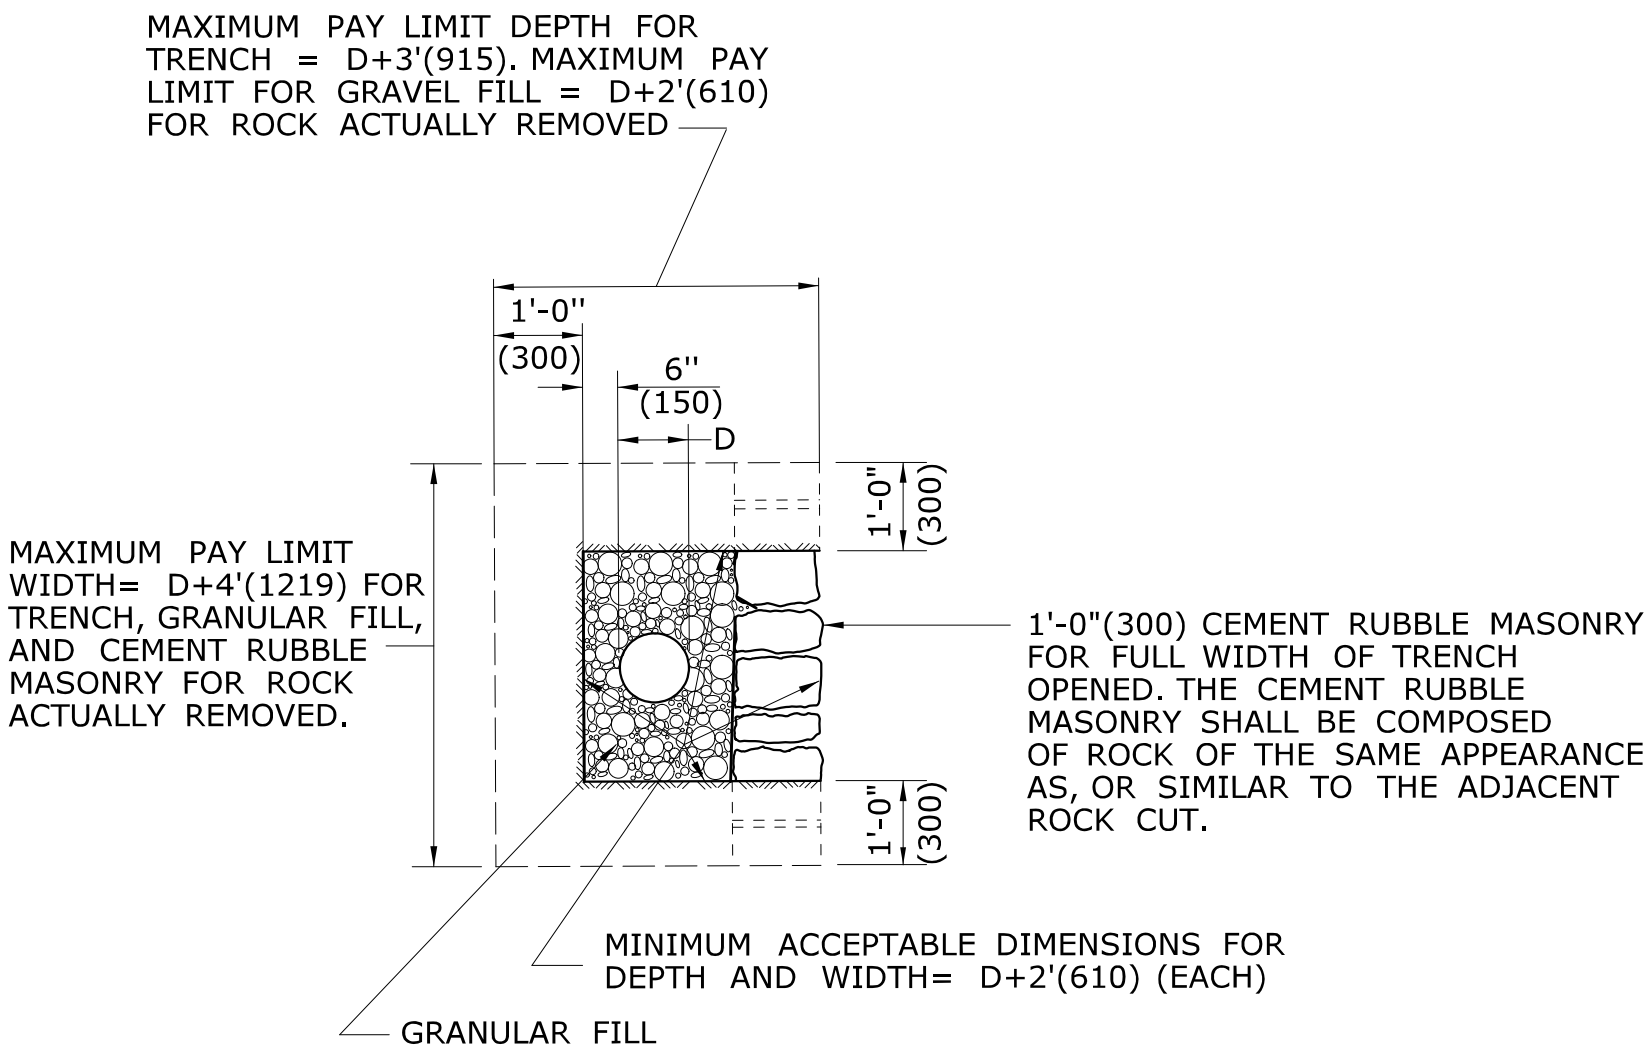TYPICAL INSTALLATION OF C.C.M.P. IN ROCK SLOPE




SECTION
A

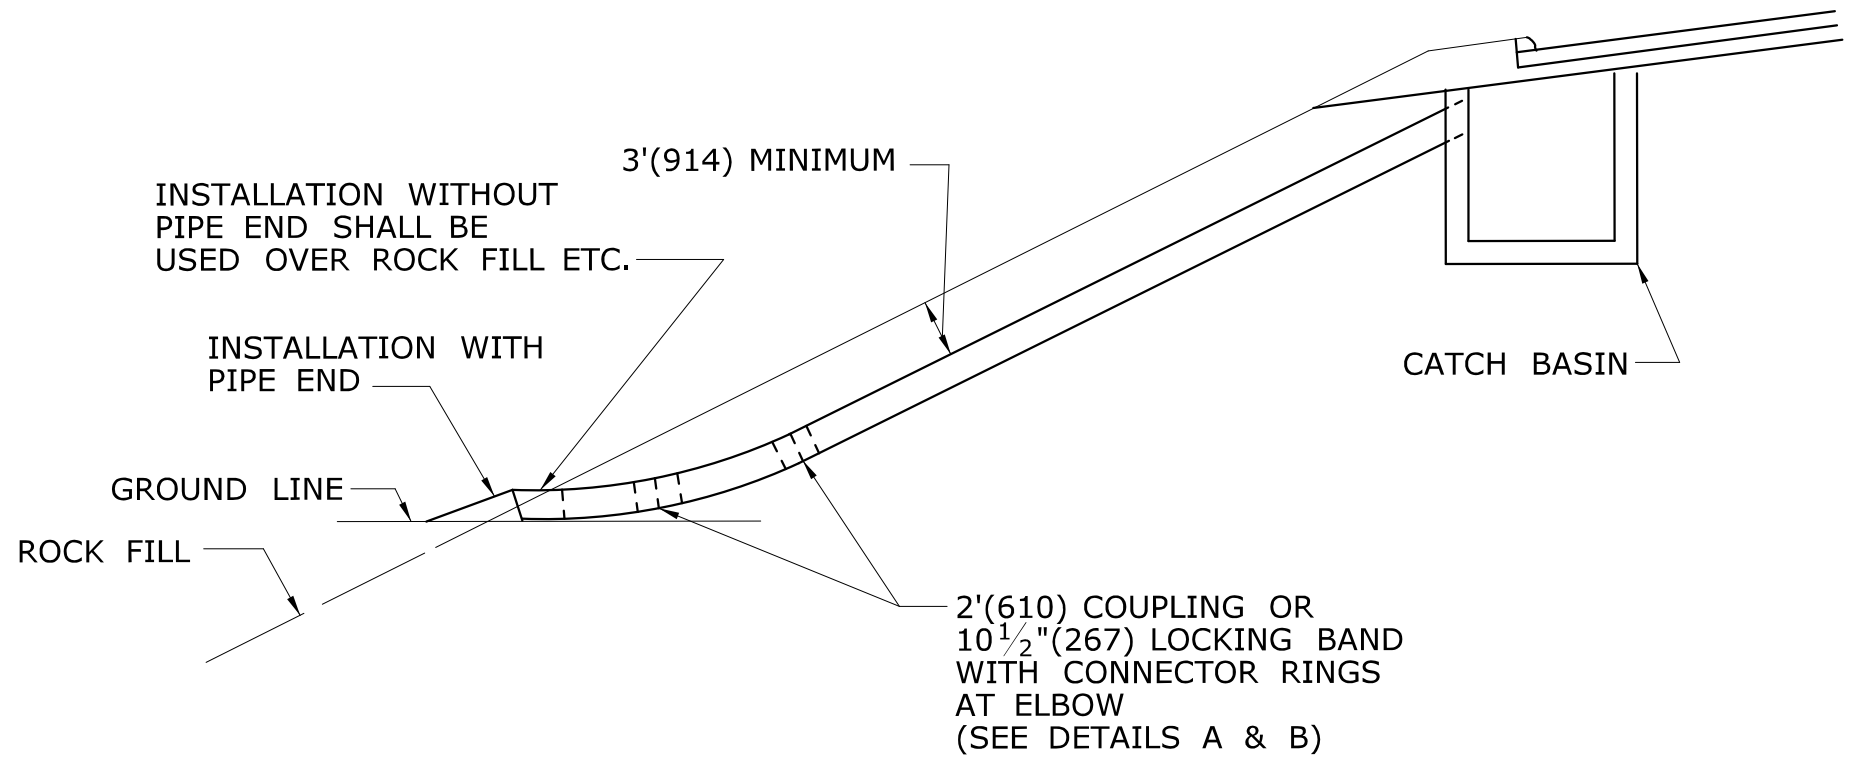

TYPICAL INSTALLATION OF C.C.M.P. ELBOW IN FILL SLOPE


TABLE C
CONNECTOR RINGS

PIPE DIAMETER	LENGTH OF RING
12" (300)	52" (1321)
15" (381)	61" (1549)
18" (457)	71" (1803)
21" (533)	80" (2032)
24" (610)	90" (2286)
30" (762)	108" (2743)
36" (915)	128" (3251)
42" (1066)	147" (3734)
48" (1219)	166" (4216)

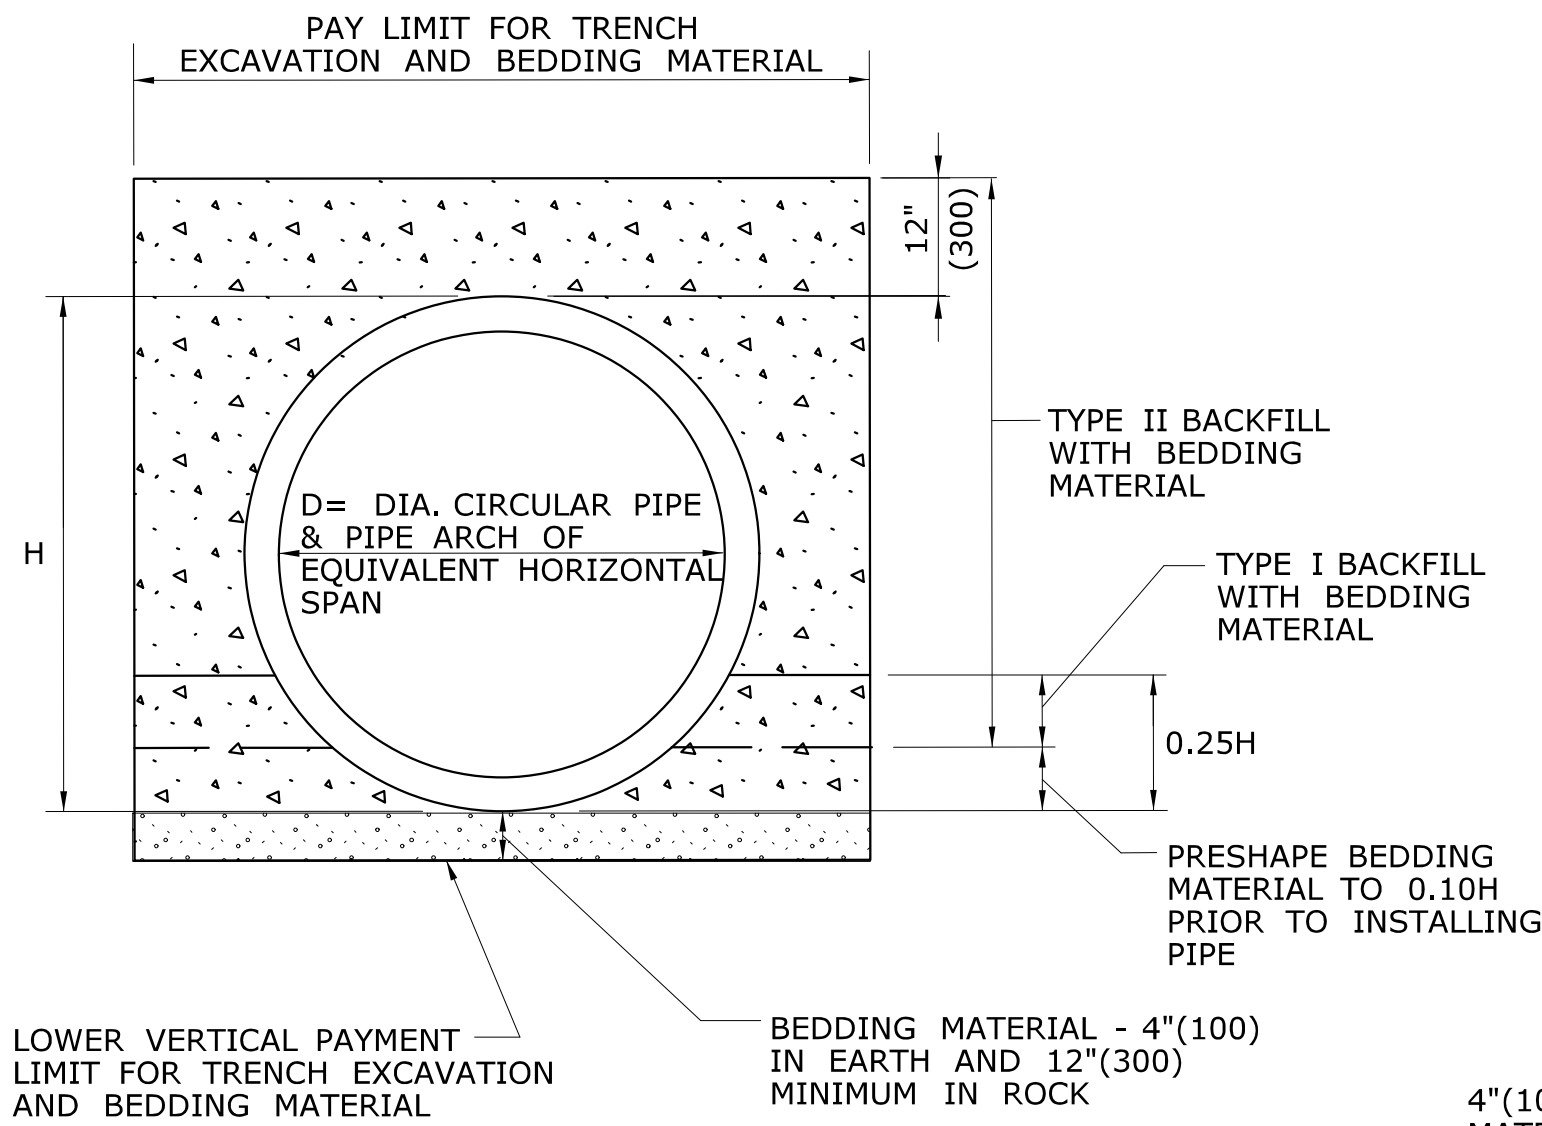


PIPE TRENCH DETAIL

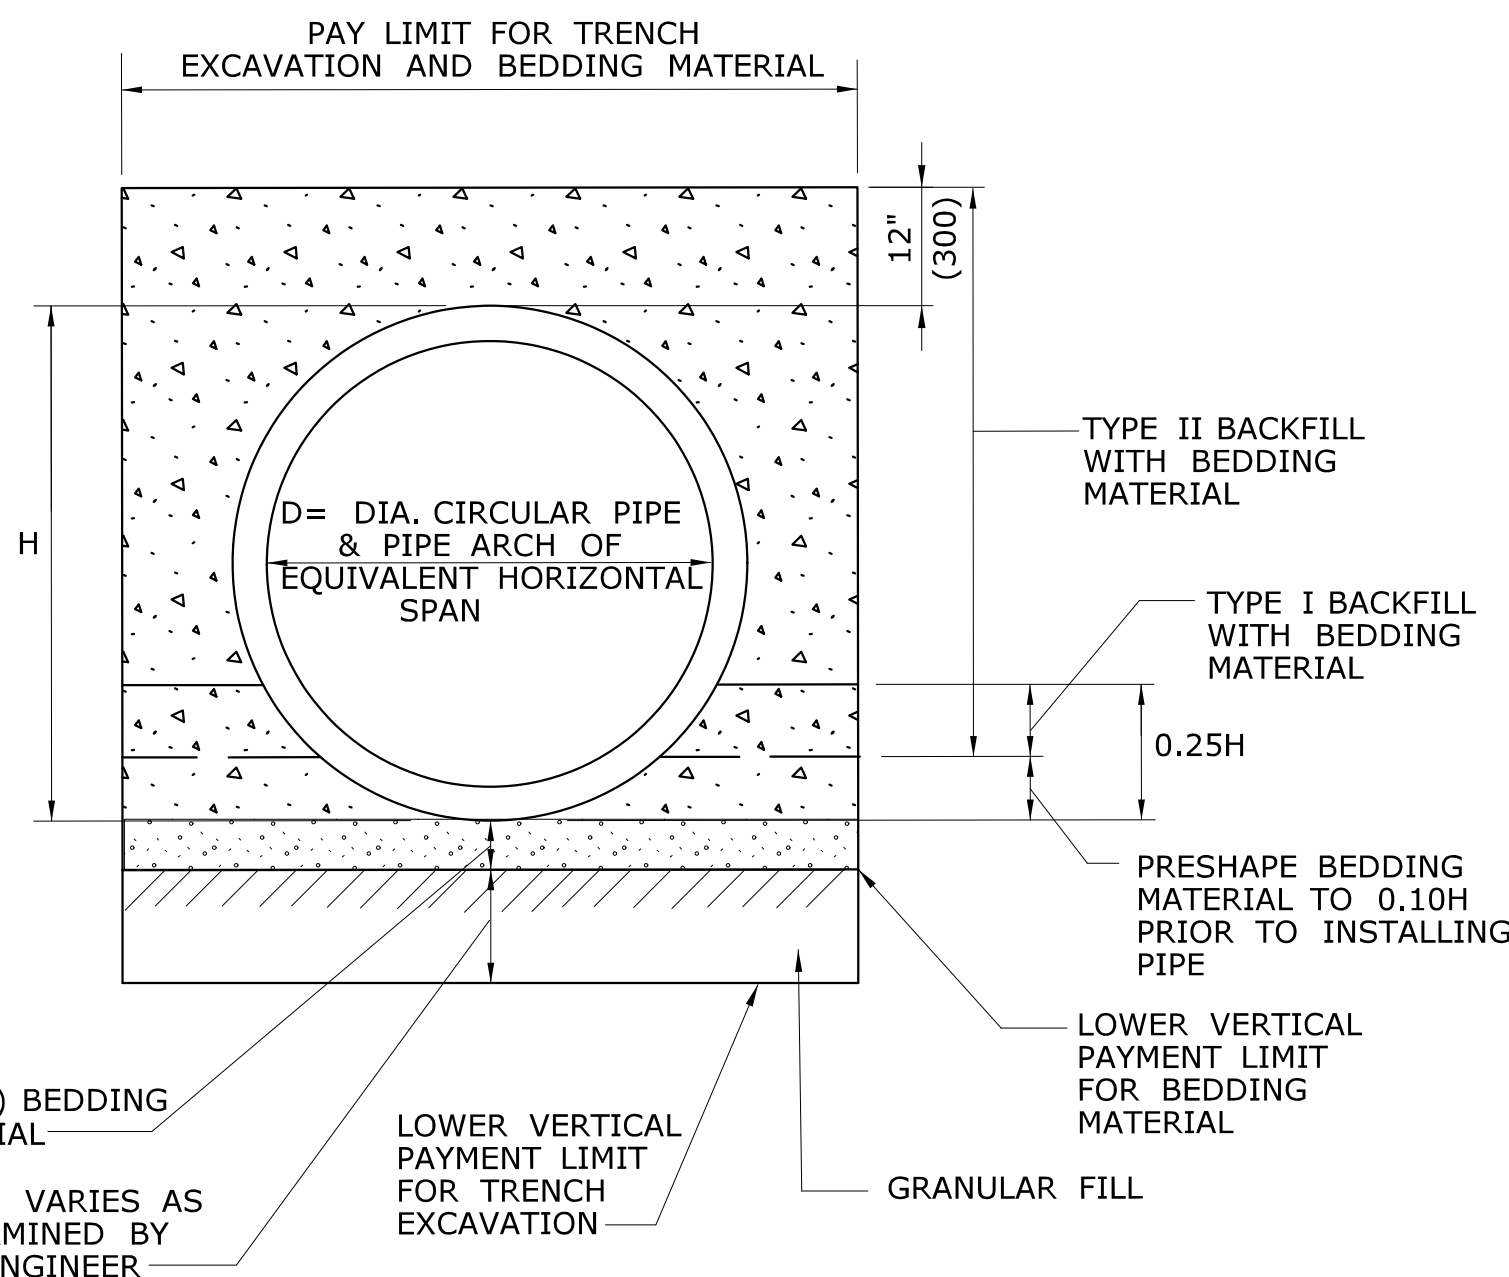
WHERE GRANULAR FILL IS NOT USED



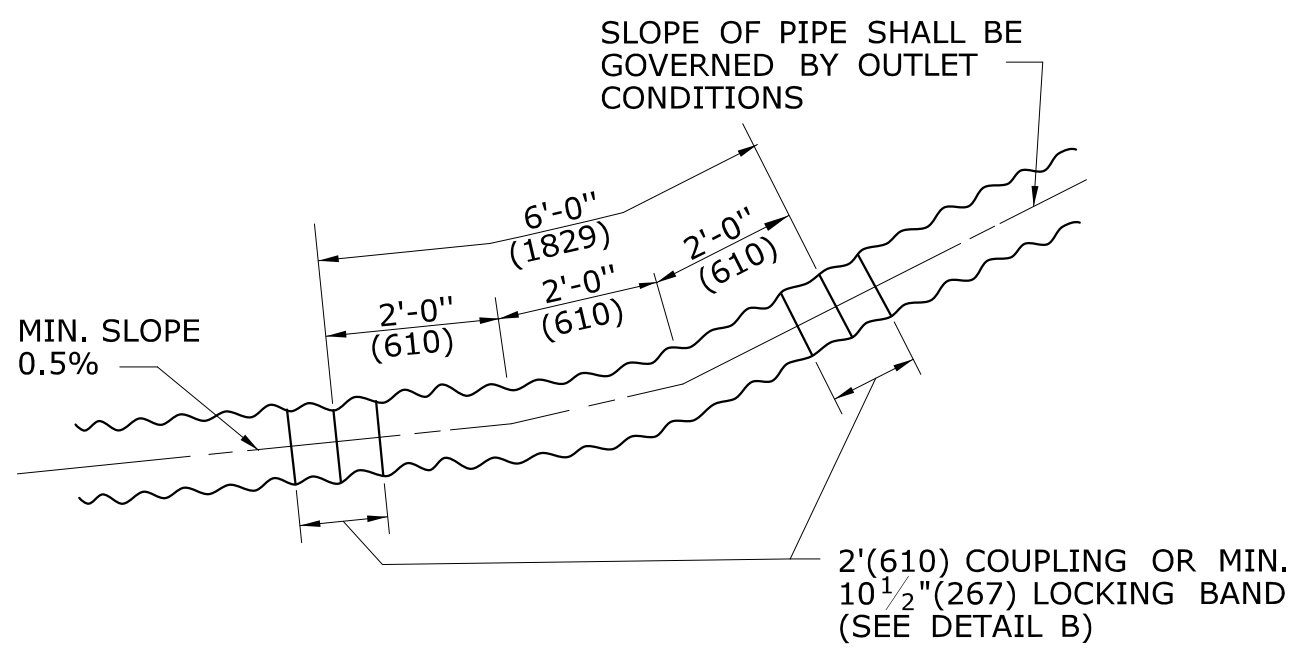PIPE TRENCH DETAIL
WHERE GRANULAR FILL
IS USED AS BEDDING



DETAIL A
C.C.M.P. ELBOW AND COUPLING

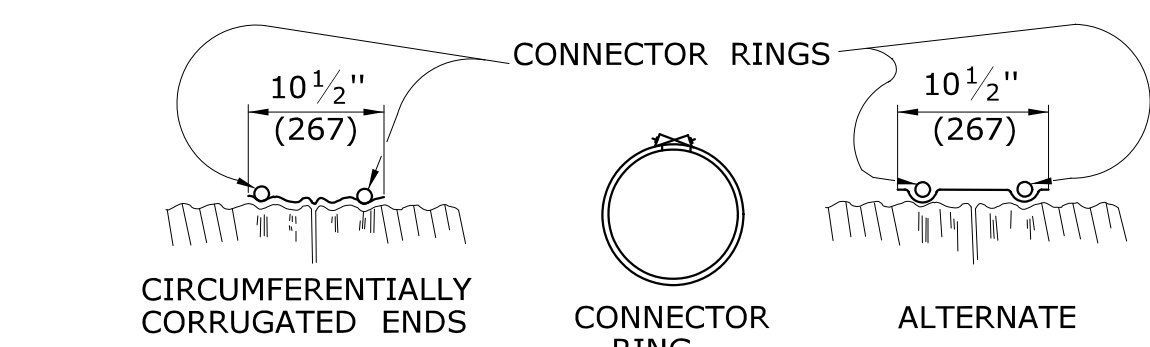

DETAIL B
ELBOW DIMENSIONS

ALL METRIC DIMENSIONS ARE IN MILLIMETERS (mm) UNLESS OTHERWISE NOTED

TOWN OF BROOKFIELD, CT

PROJECT NAME: TOWN DISTRICT SIDEWALK AND ACCESS MANAGEMENT PLAN

SHEET TITLE: C.C.M. PIPE INSTALLATIONS IN FILL & ROCK SLOPES & PIPE DETAILS


FILE NAME:	PLOT DATE: 4/20/2016	DRAWING NO.: MDS-23
PROJECT LEADER: SM	DRAWN BY: AG	SHEET NO.: 29
DESIGNED BY: AG	CHECKED BY: PG	

URS CORPORATION
500 ENTERPRISE DRIVE, SUITE 3B
ROCKY HILL, CT 06067
(860) 529-8882


GENERAL NOTES:

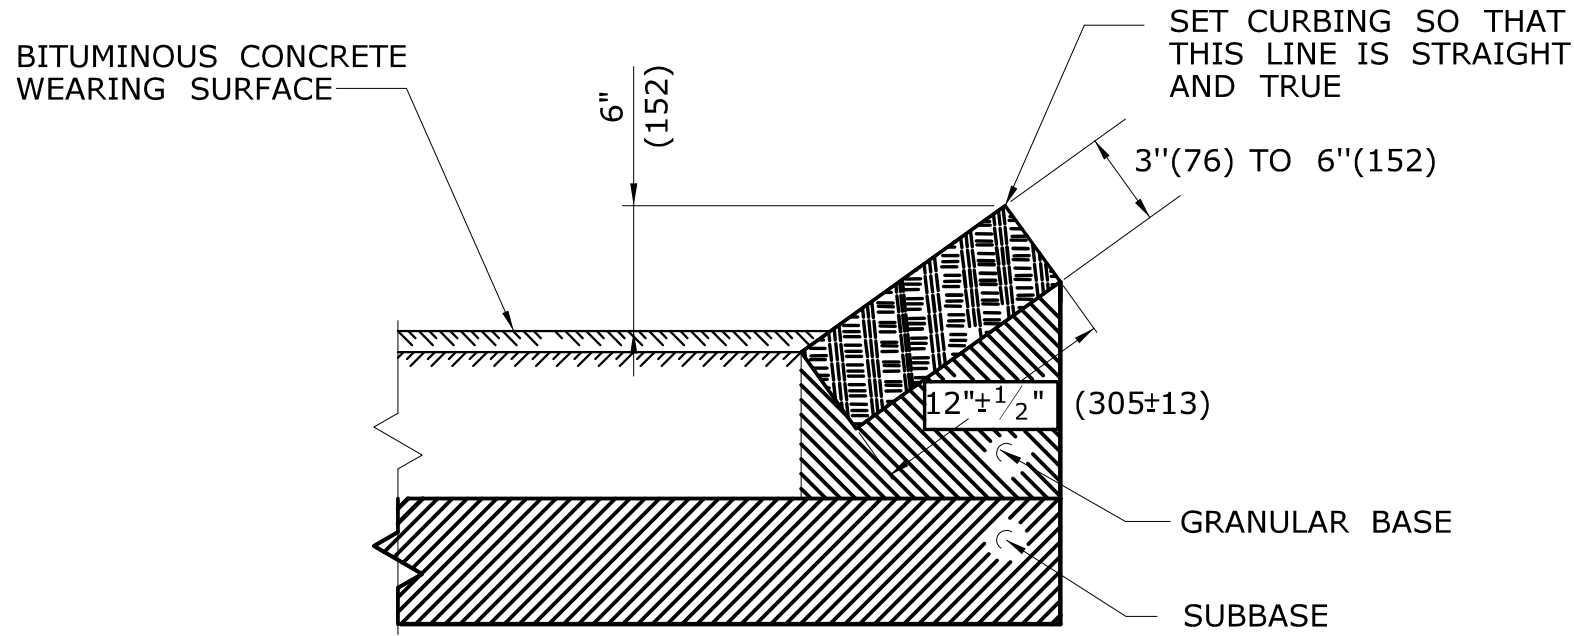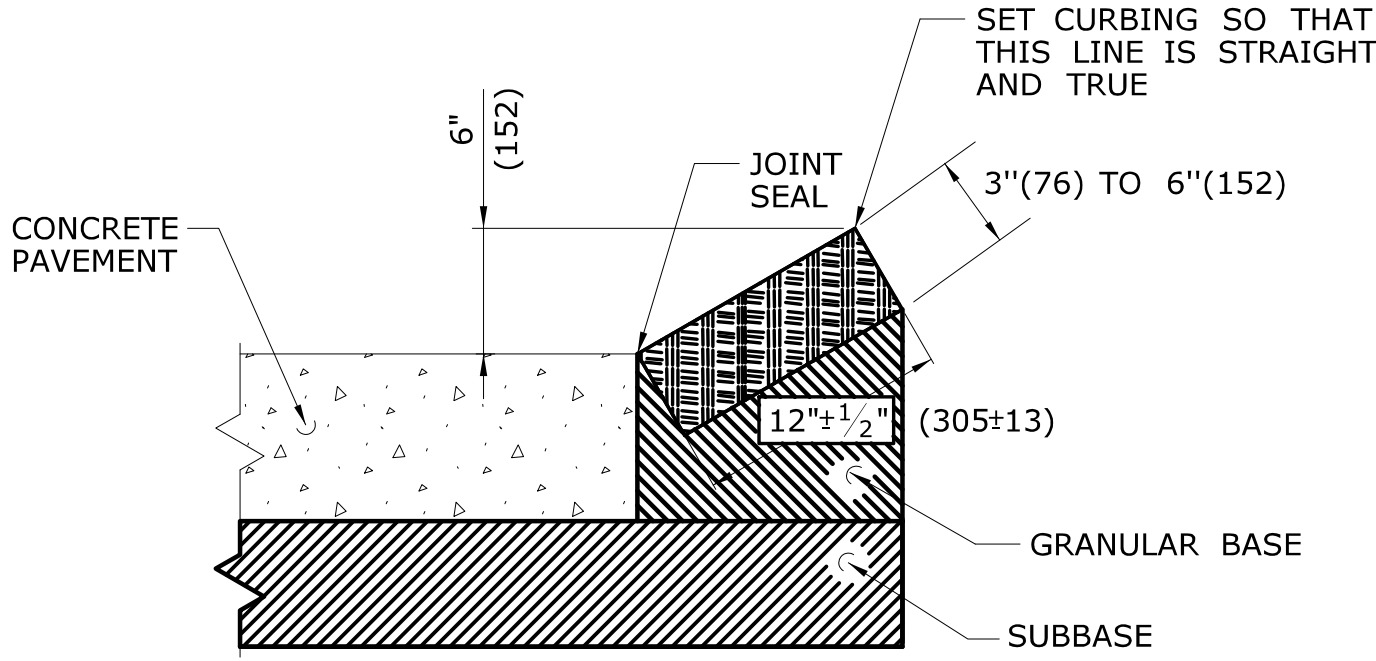1. ROCK REMOVED BEYOND THE MAXIMUM PAY LIMIT SHOWN SHALL BE REPLACED WITH CEMENT RUBBLE MASONRY AND GRANULAR FILL.
2. FILL, AS REQUIRED TO CLOSE THE OPENING AS SHOWN ON THE PLANS, WILL BE AT THE CONTRACTORS EXPENSE. HOWEVER, THE PAY LIMIT LINES MAY BE MODIFIED TO COINCIDE WITH NATURAL FAULTS OR FISSURES OF ROCK AS THE ENGINEER MAY DETERMINE.
3. COATED CORRUGATED METAL PIPE (C.C.M.P.)

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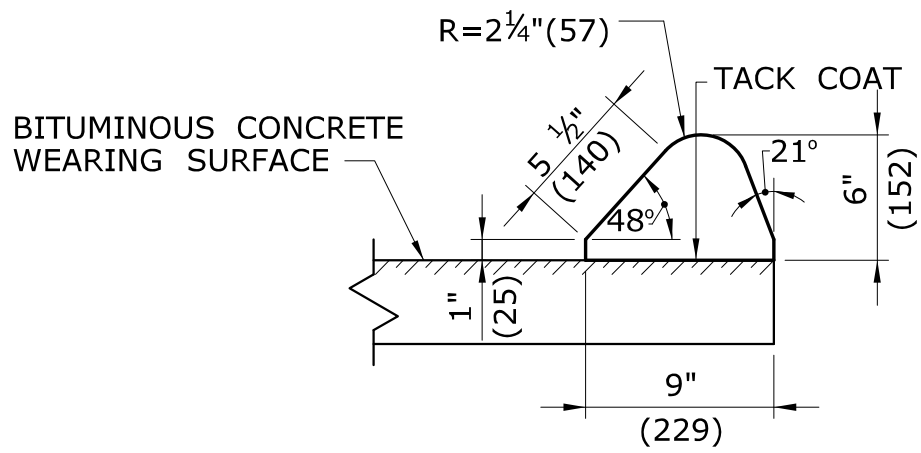
TYPICAL SECTION SHOWING SLOPE CURBING SET ADJACENT TO BITUMINOUS CONCRETE SURFACES




TYPICAL SECTION SHOWING SLOPE CURBING SET ADJACENT TO CONCRETE SURFACES

GRANITE SLOPE CURBING


1/2" (13) MORTAR JOINT REQUIRED



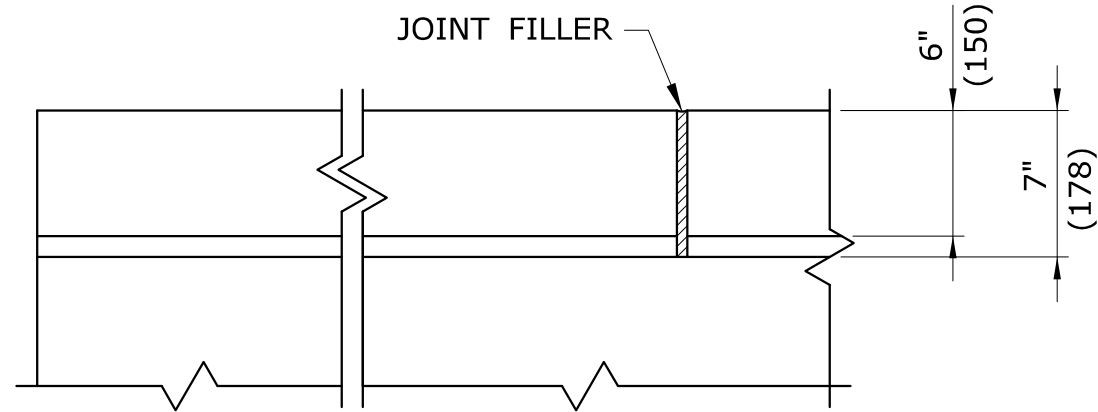6" (150) BITUMINOUS CONCRETE LIP CURBING




PLAN

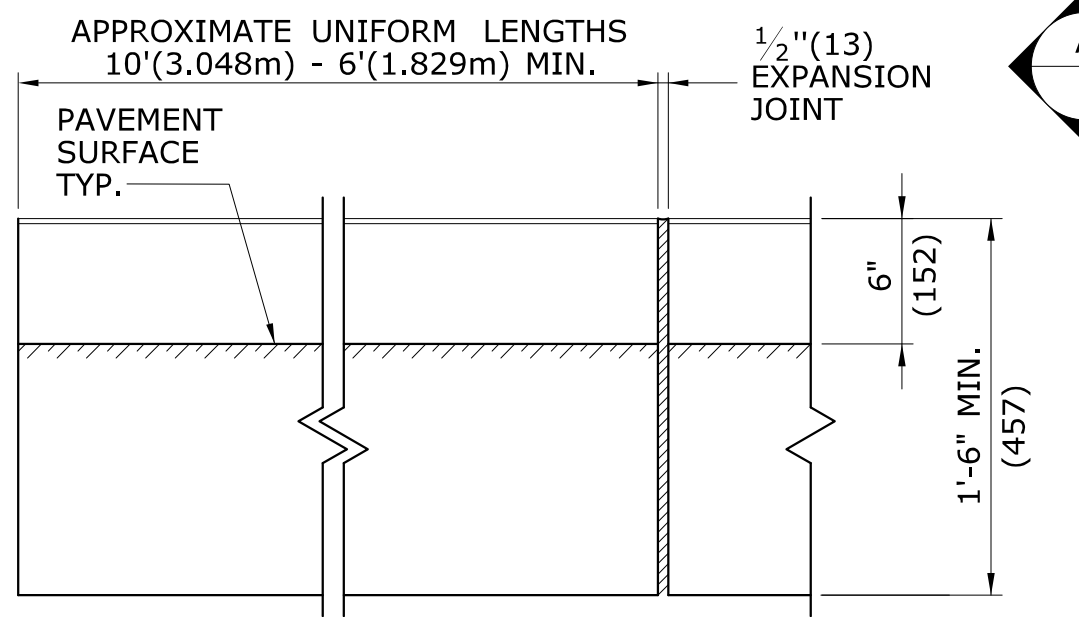


ELEVATION

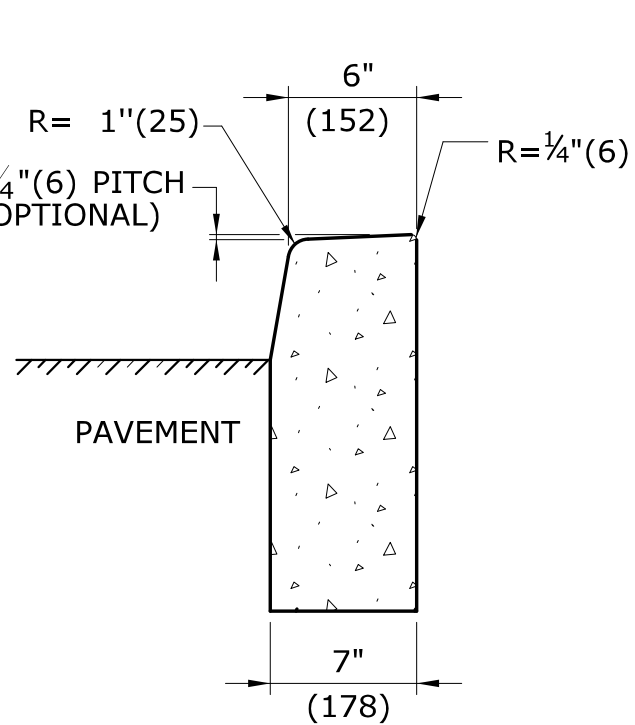
6" (150) CONCRETE CURBING




SECTION A

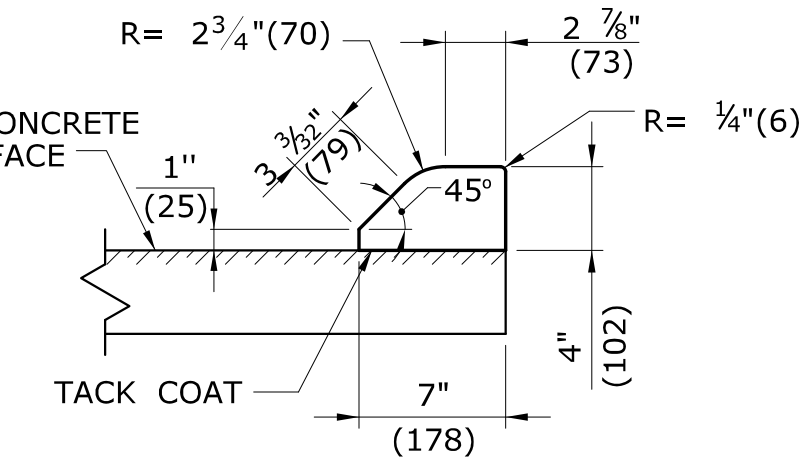

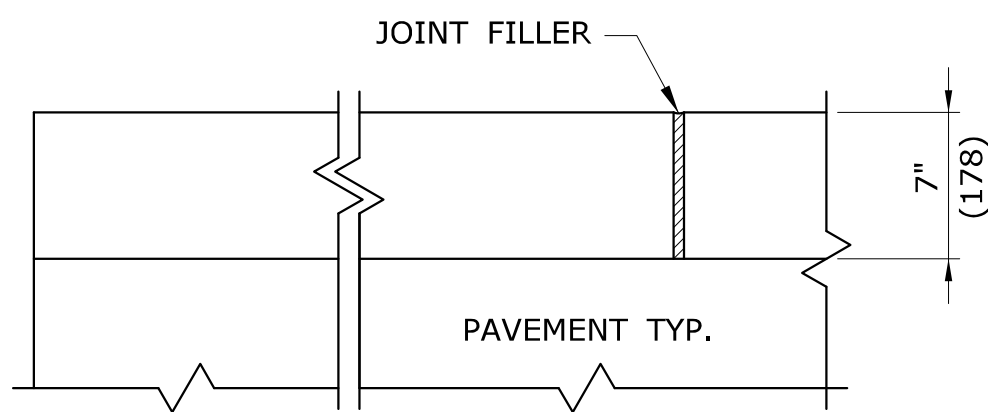4" (100) BITUMINOUS CONCRETE PARK CURBING




PLAN

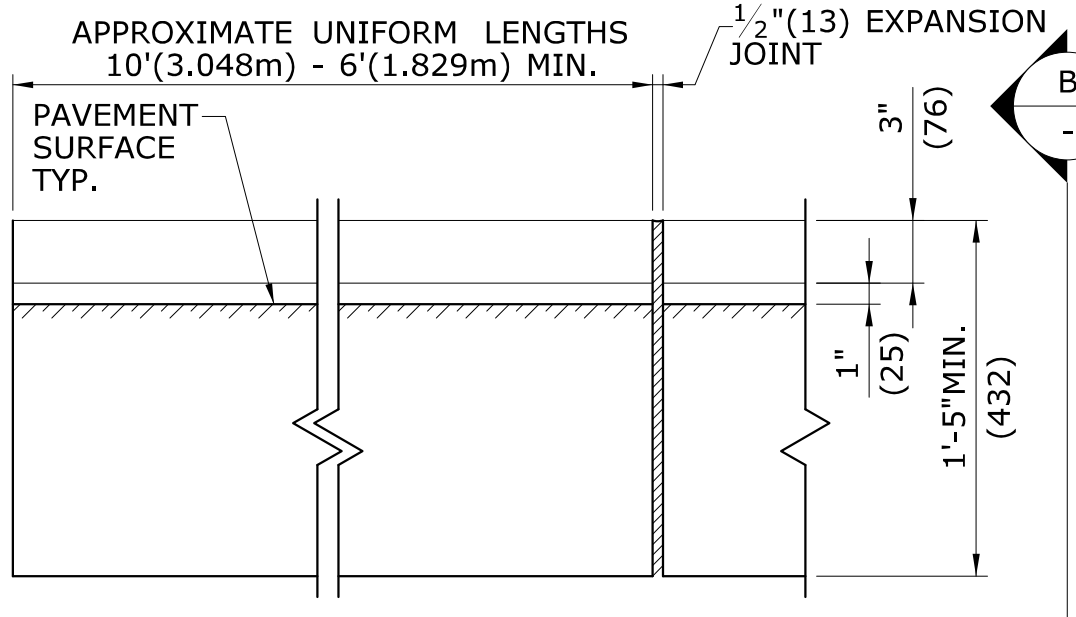


ELEVATION

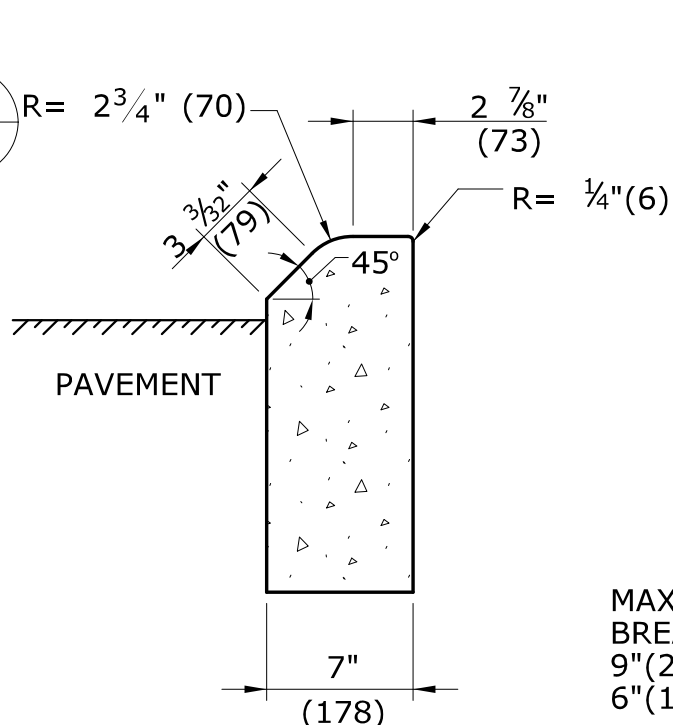4" (100) CONCRETE PARK CURBING



SECTION B

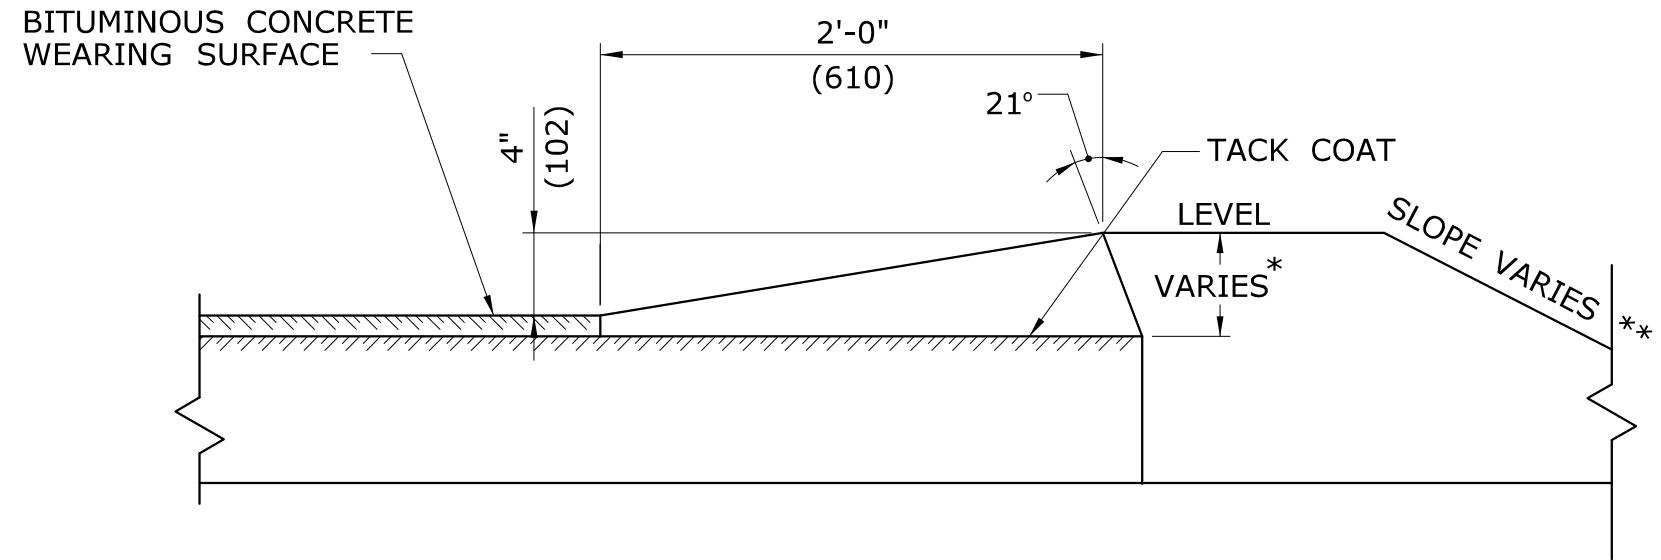


NOTE:

1. ALL CONSTRUCTION DIMENSIONS ARE NOMINAL.


* THIS DIMENSION VARIES WITH THE THICKNESS OF THE TOP COURSE AND SLOPE OF SHOULDER.

** SEE TYPICAL SECTIONS FOR PROJECT. IN FILL AREAS 2'(610) LEVEL BEHIND THE CURB IS REQUIRED.

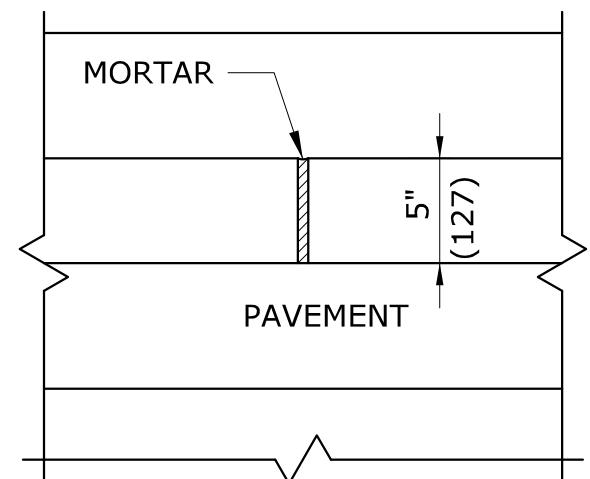BITUMINOUS CONCRETE BERM




PLAN

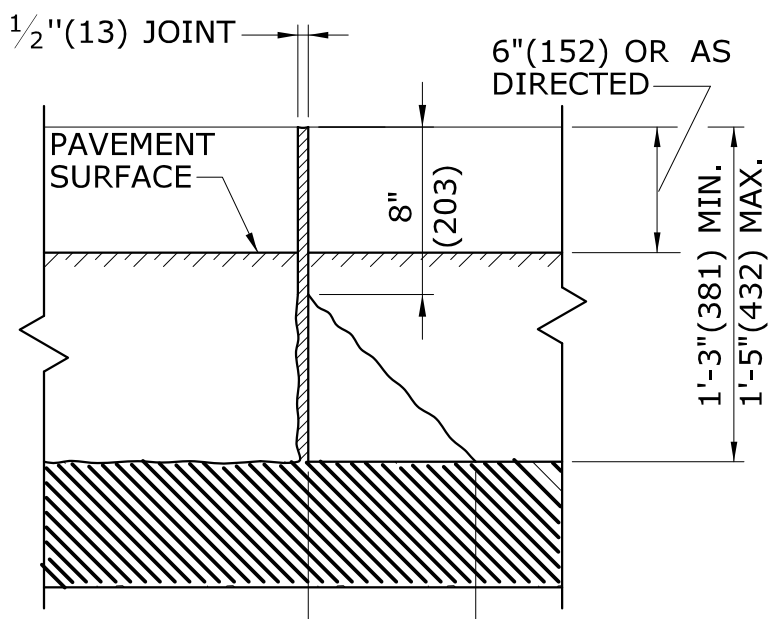

ELEVATION

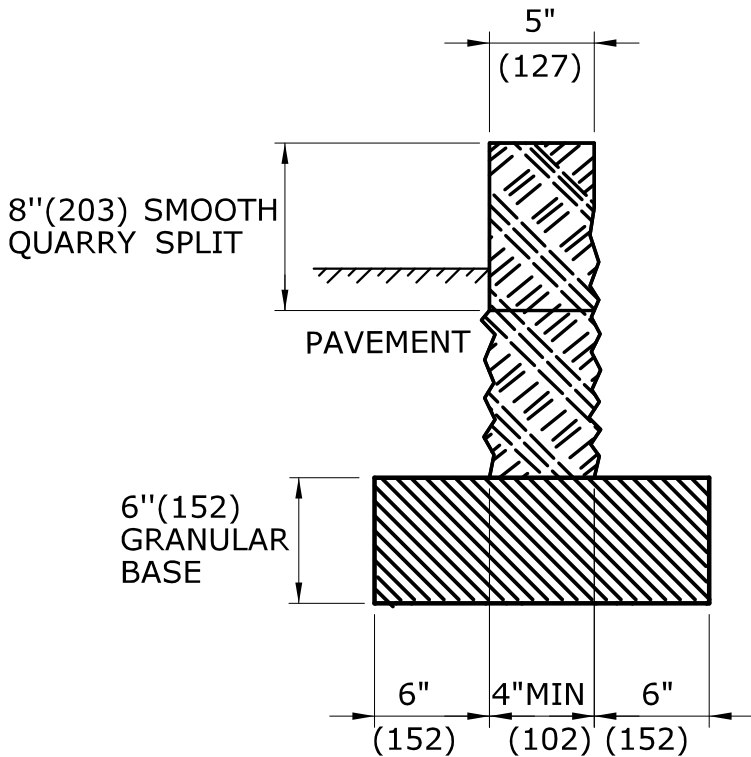MAXIMUM ALLOWABLE BREAK BACK IS 9"(229) FOR CURB LENGTHS OF 6'(1.829m) OR MORE, 6"(152) FOR CURB LENGTHS LESS THAN 6'(1.829m)



SECTION C

GRANITE STONE CURBING

ALL METRIC DIMENSIONS ARE IN MILLIMETERS (mm) UNLESS OTHERWISE NOTED

TOWN OF BROOKFIELD, CT

PROJECT NAME: TOWN DISTRICT SIDEWALK AND ACCESS MANAGEMENT PLAN

SHEET TITLE: CURBING

URS CORPORATION
500 ENTERPRISE DRIVE, SUITE 3B
ROCKY HILL, CT 06067
(860) 529-8882

FILE NAME:
PROJECT LEADER: SM
DESIGNED BY: AG


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DRAWN BY: AG
CHECKED BY: PG

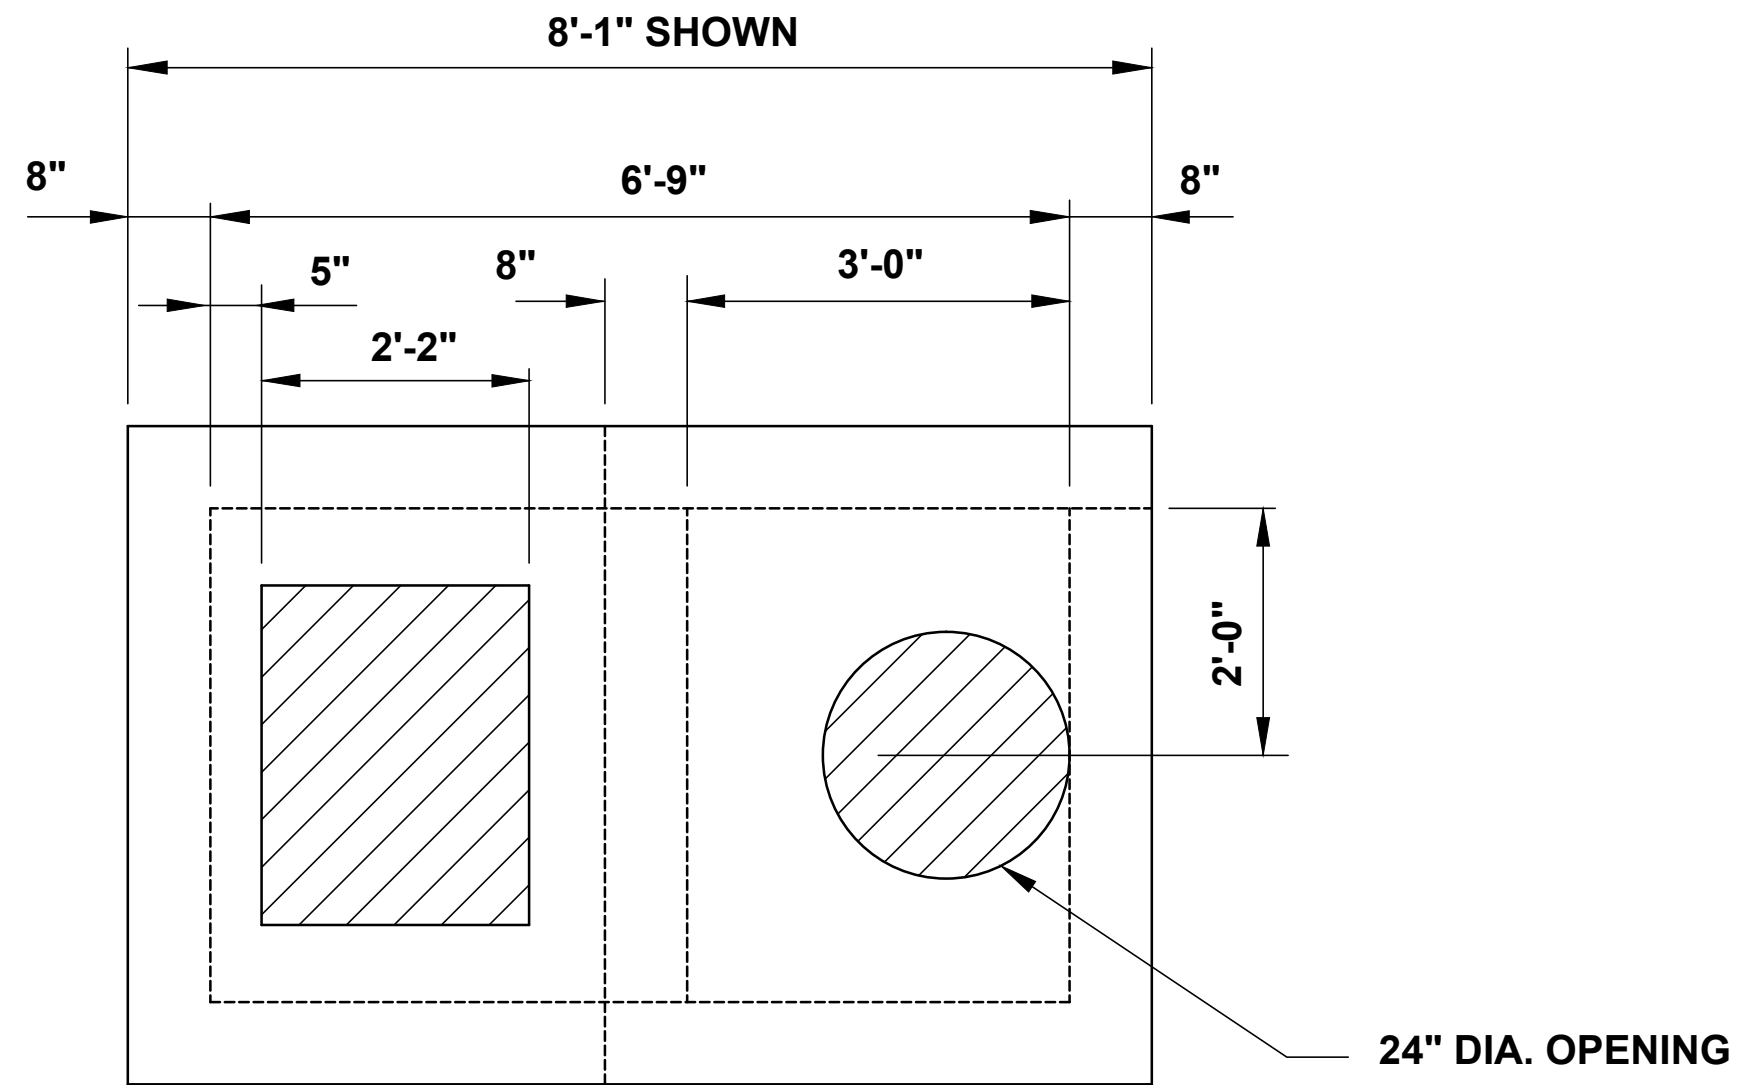DRAWING NO.: MDS-24
SHEET NO.: 30

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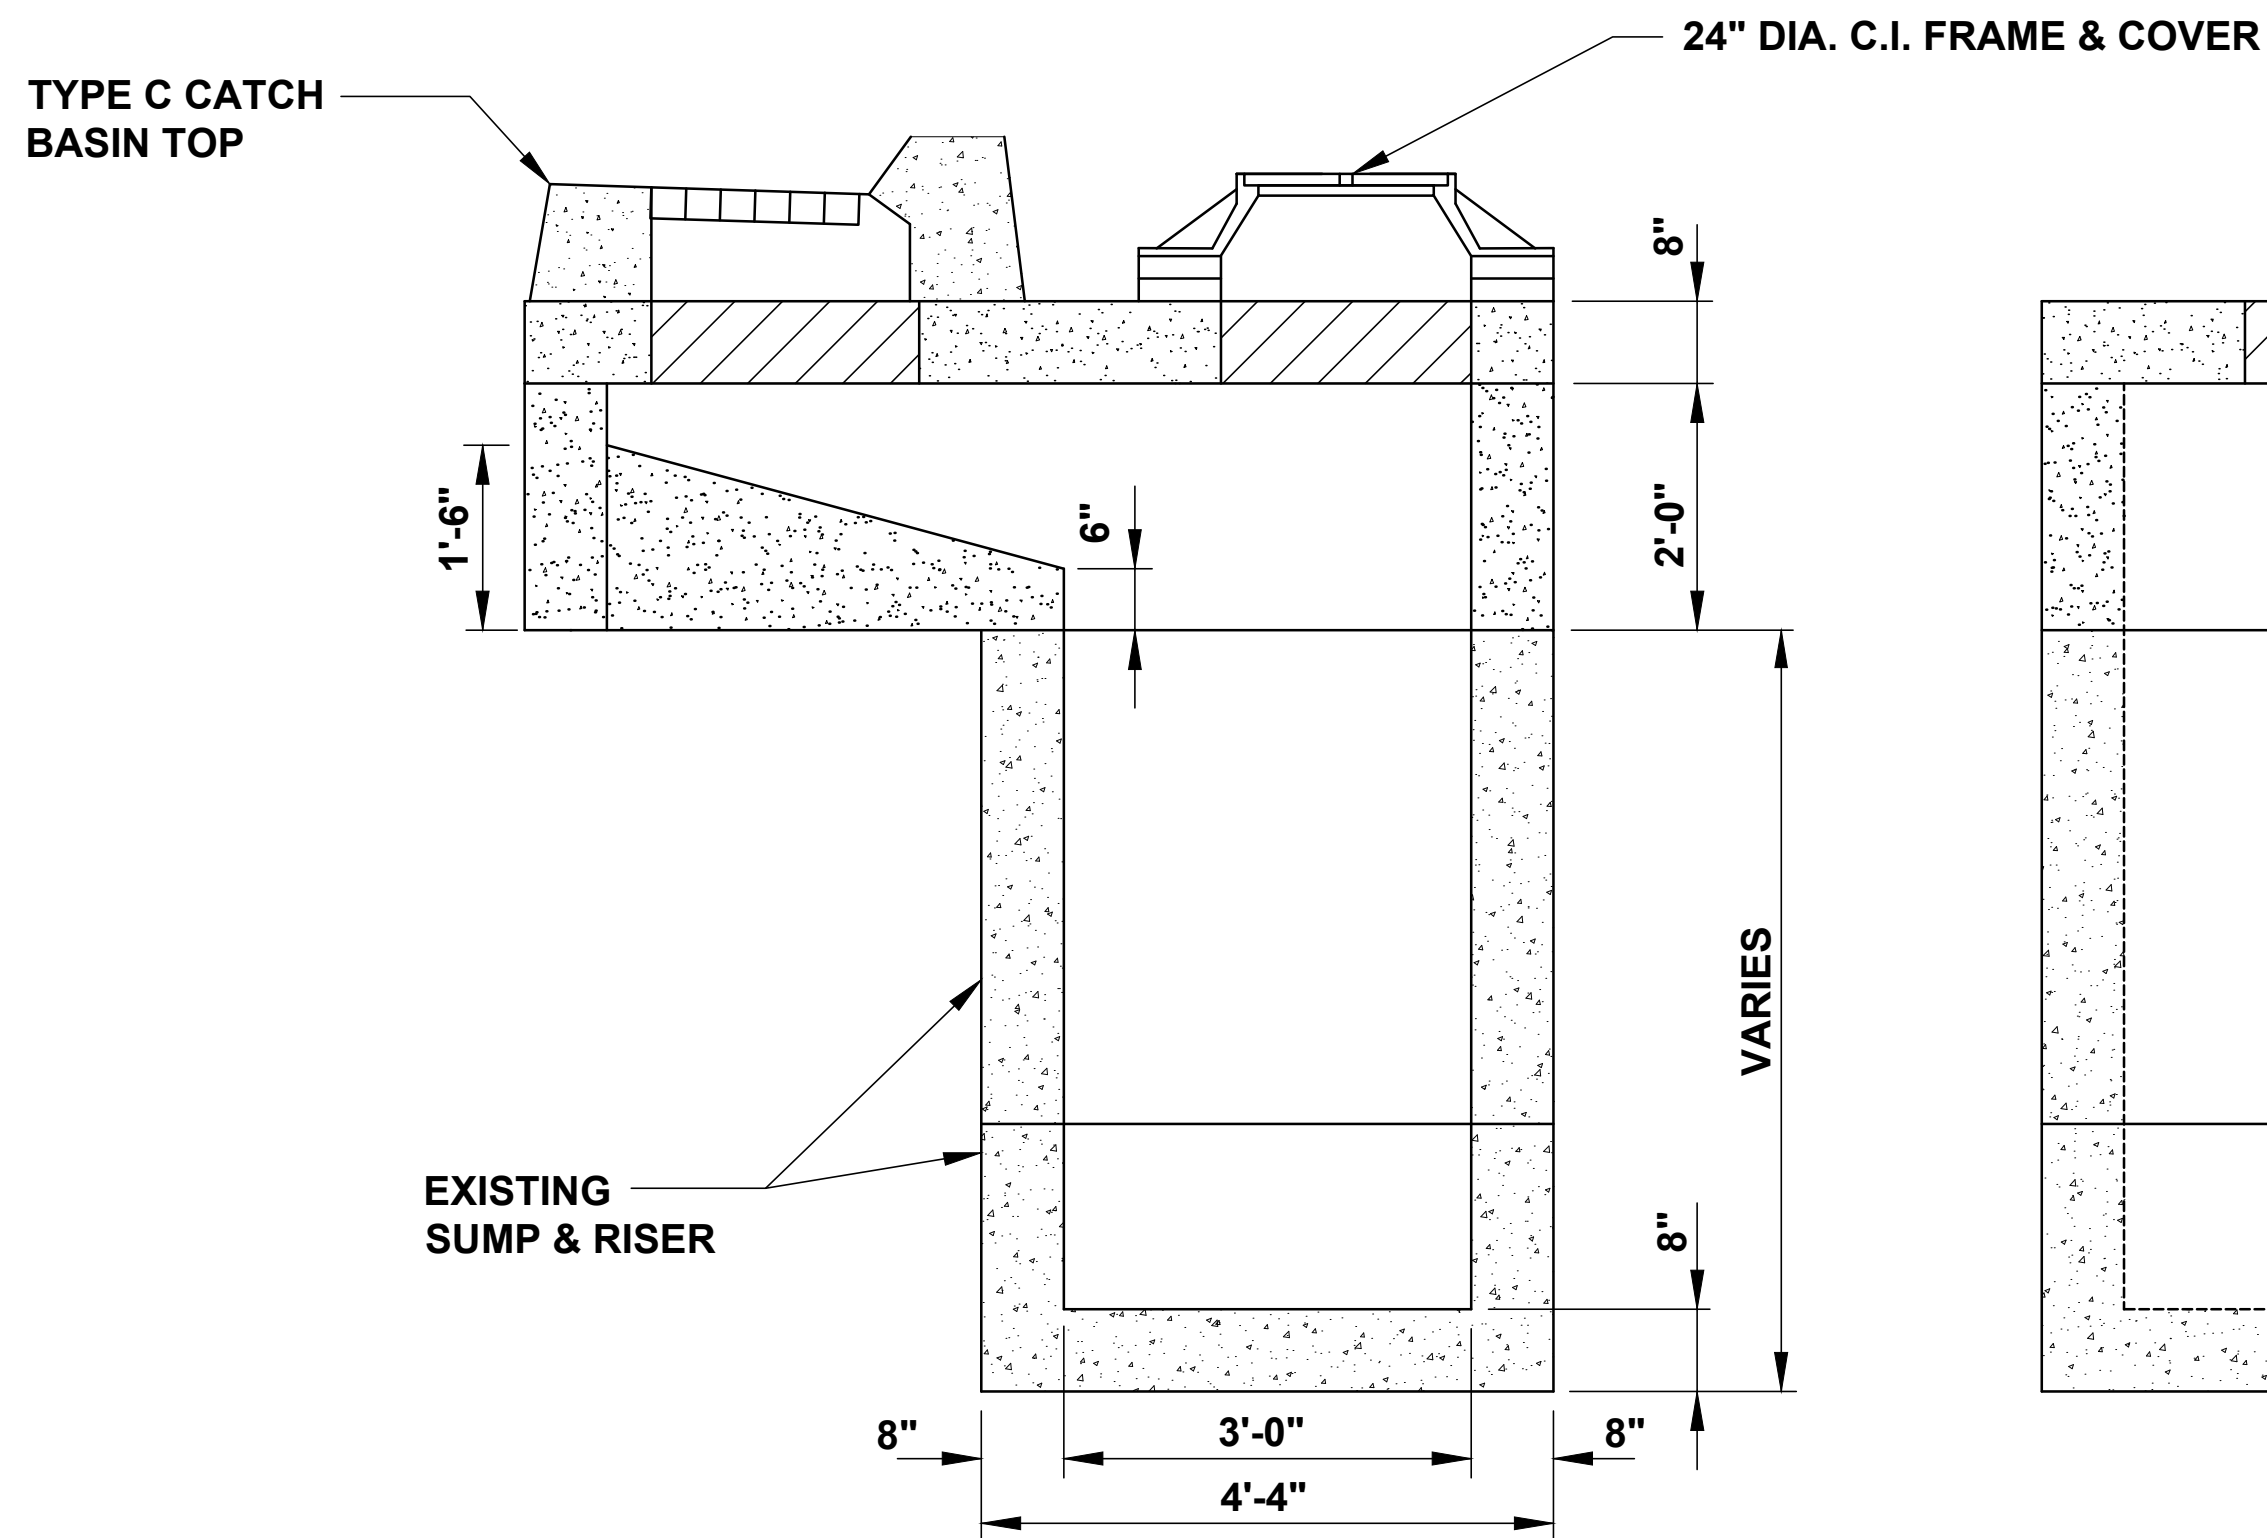
NOTES:

1. REINFORCING STEEL WELDED WIRE FABRIC CONFORM TO LATEST ASTM SPECIFICATION A185.
2. REINFORCING STEEL DEFORMED BARS CONFORM TO LATEST ASTM SPECIFICATION A615, GRADE 60.
3. CONCRETE COMPRESSIVE STRENGTH - 4,000 PSI AT 28 DAYS SELF COMPACTING CONCRETE MIX.
4. METHOD OF MANUFACTURE: WET CAST.
5. DESIGN LOAD: AASHTO H-20.

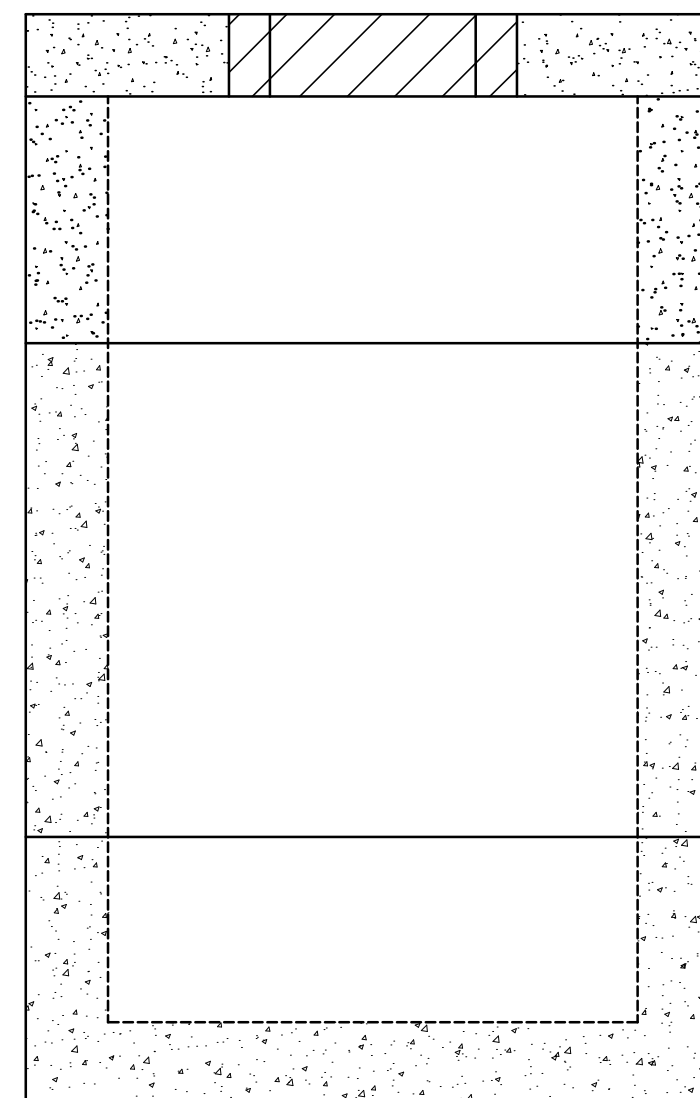


PLAN VIEW

(SHOWN W/O CATCH BASIN TOP)



CROSS SECTION



END VIEW

OFFSET TYPE "C" CATCH BASIN

(FEDERAL ROAD STA. 104+59.6, 16.3' RT)
NOT TO SCALE

TOWN OF BROOKFIELD, CT

PROJECT NAME: TOWN DISTRICT SIDEWALK AND ACCESS
MANAGEMENT PLAN

SHEET TITLE: MISCELLANEOUS DETAILS

FILE NAME: ----

PROJECT LEADER: SM
DESIGNED BY: AG

PLOT DATE: 4/20/2016


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CHECKED BY: PG

DRAWING NO.: MDS-25

SHEET NO.: 31

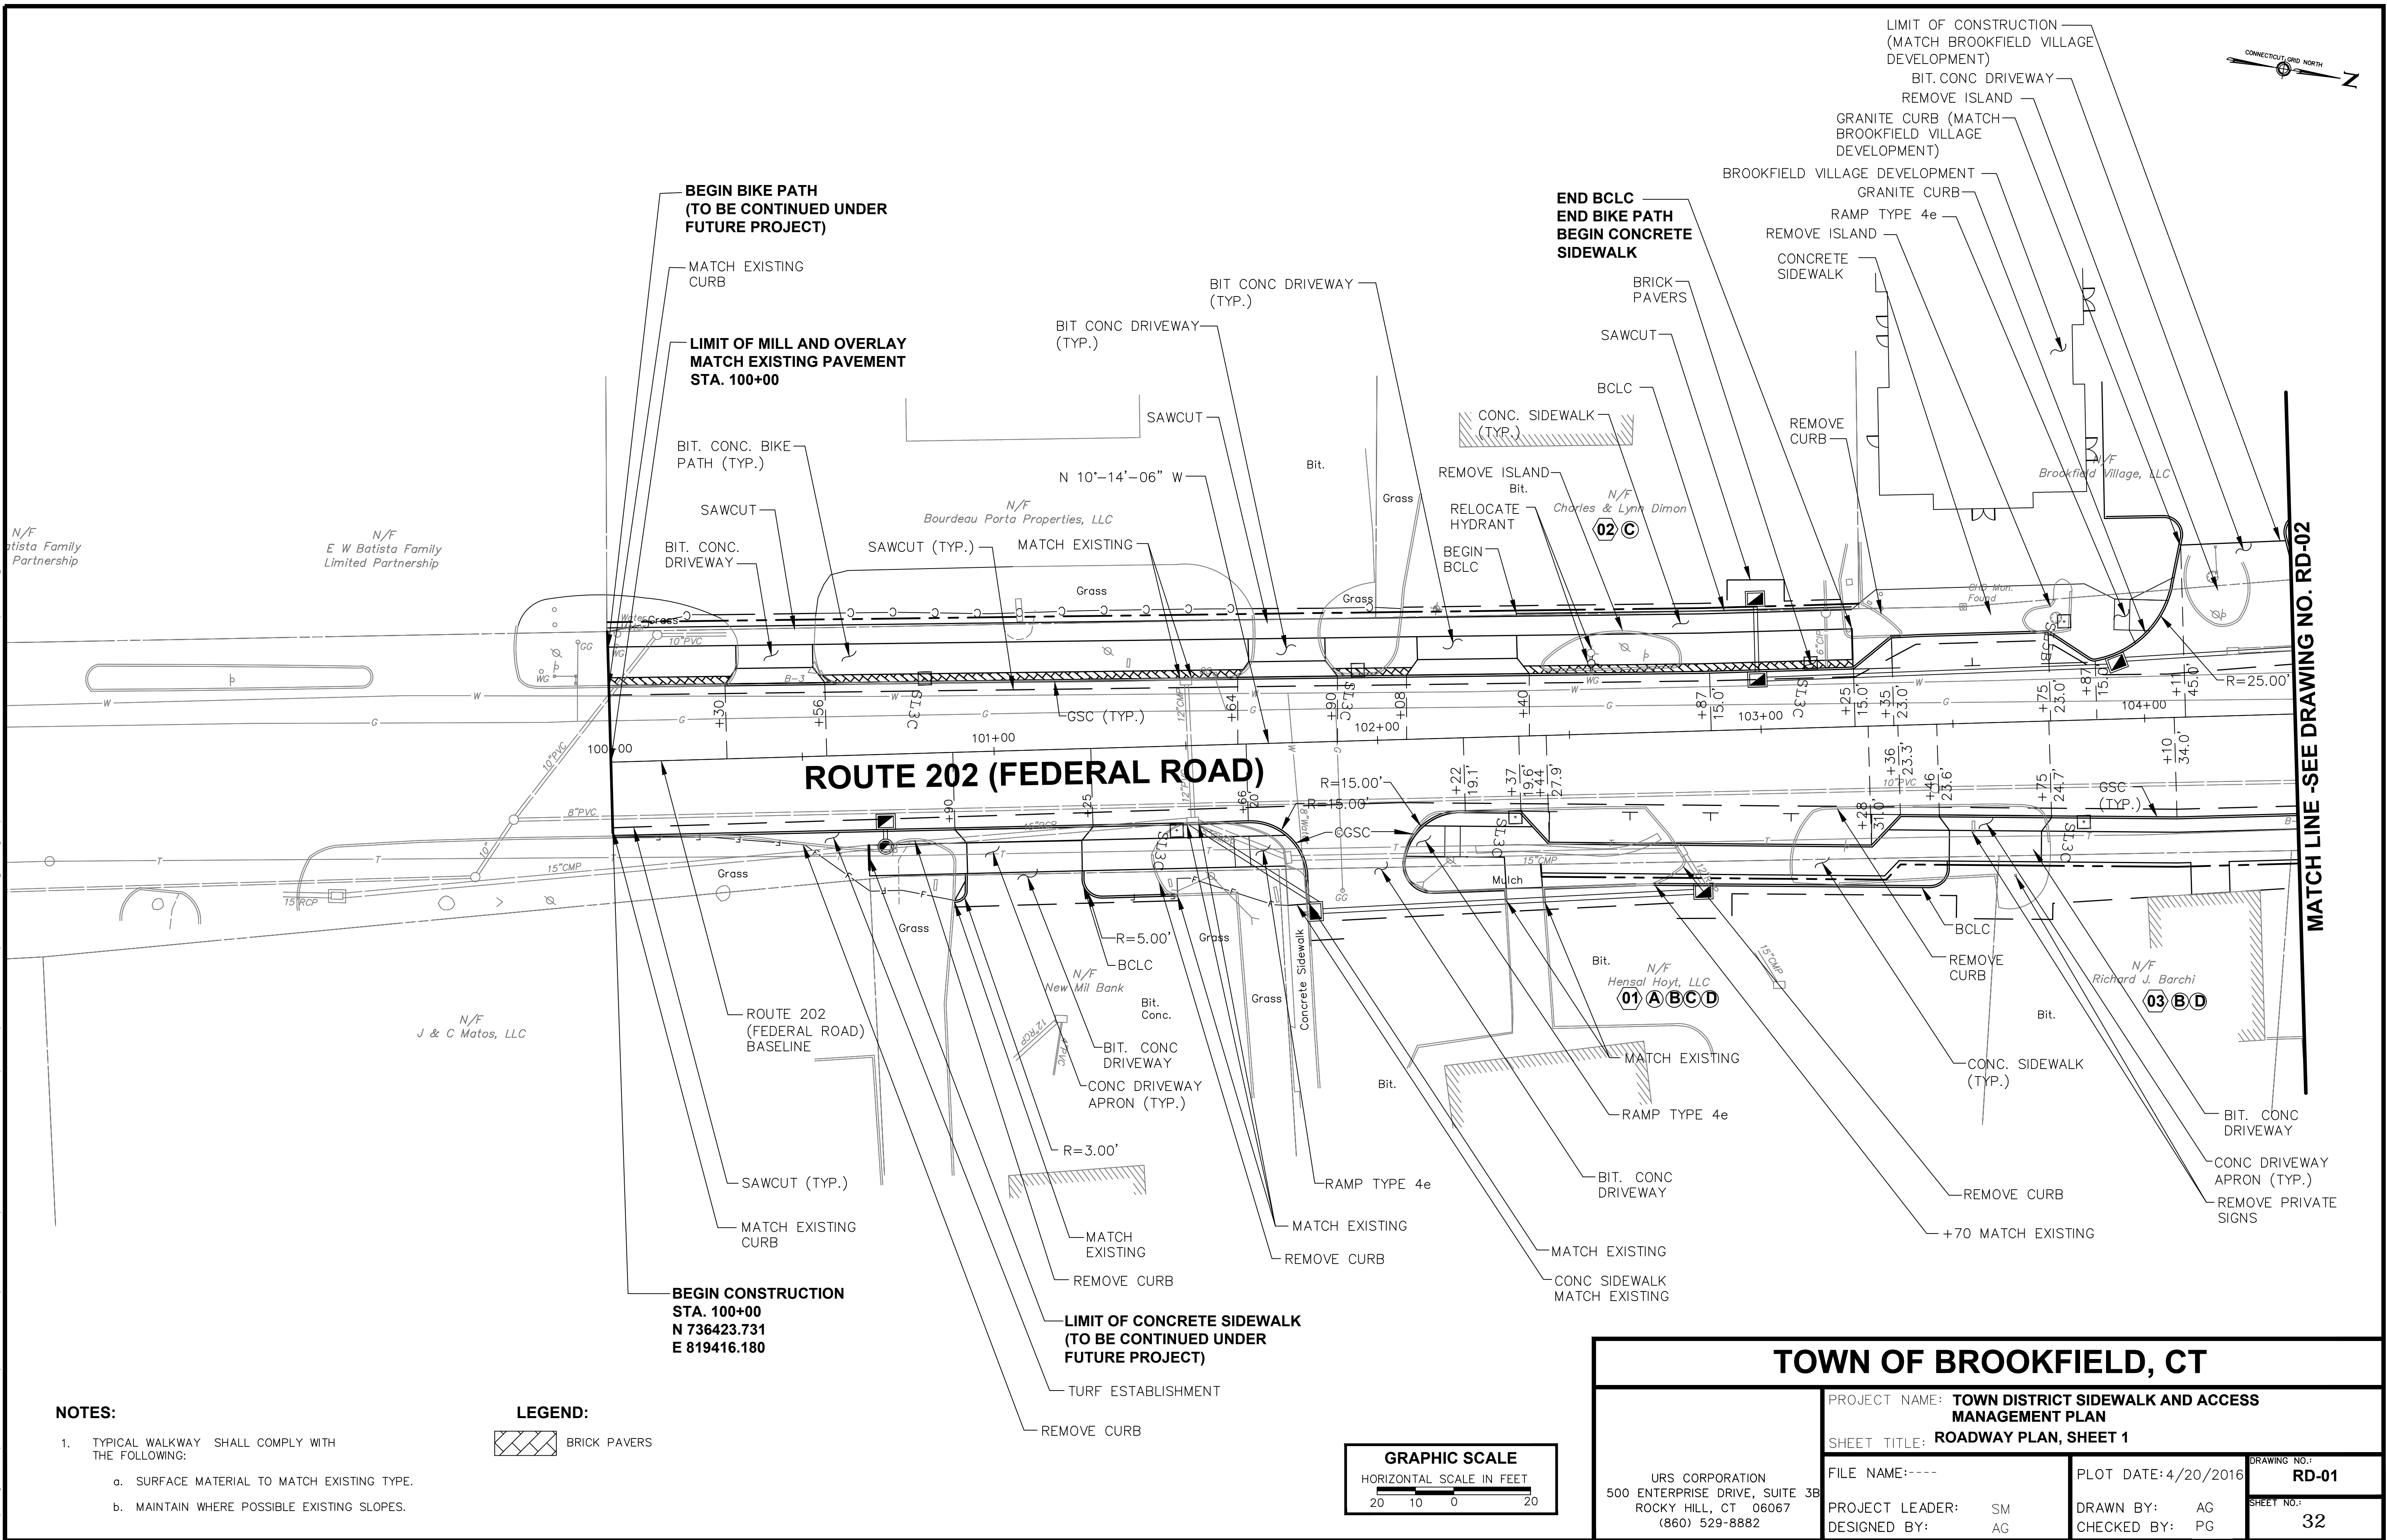AECOM
500 ENTERPRISE DRIVE, SUITE 3B
ROCKY HILL, CT 06067
(860) 529-8882

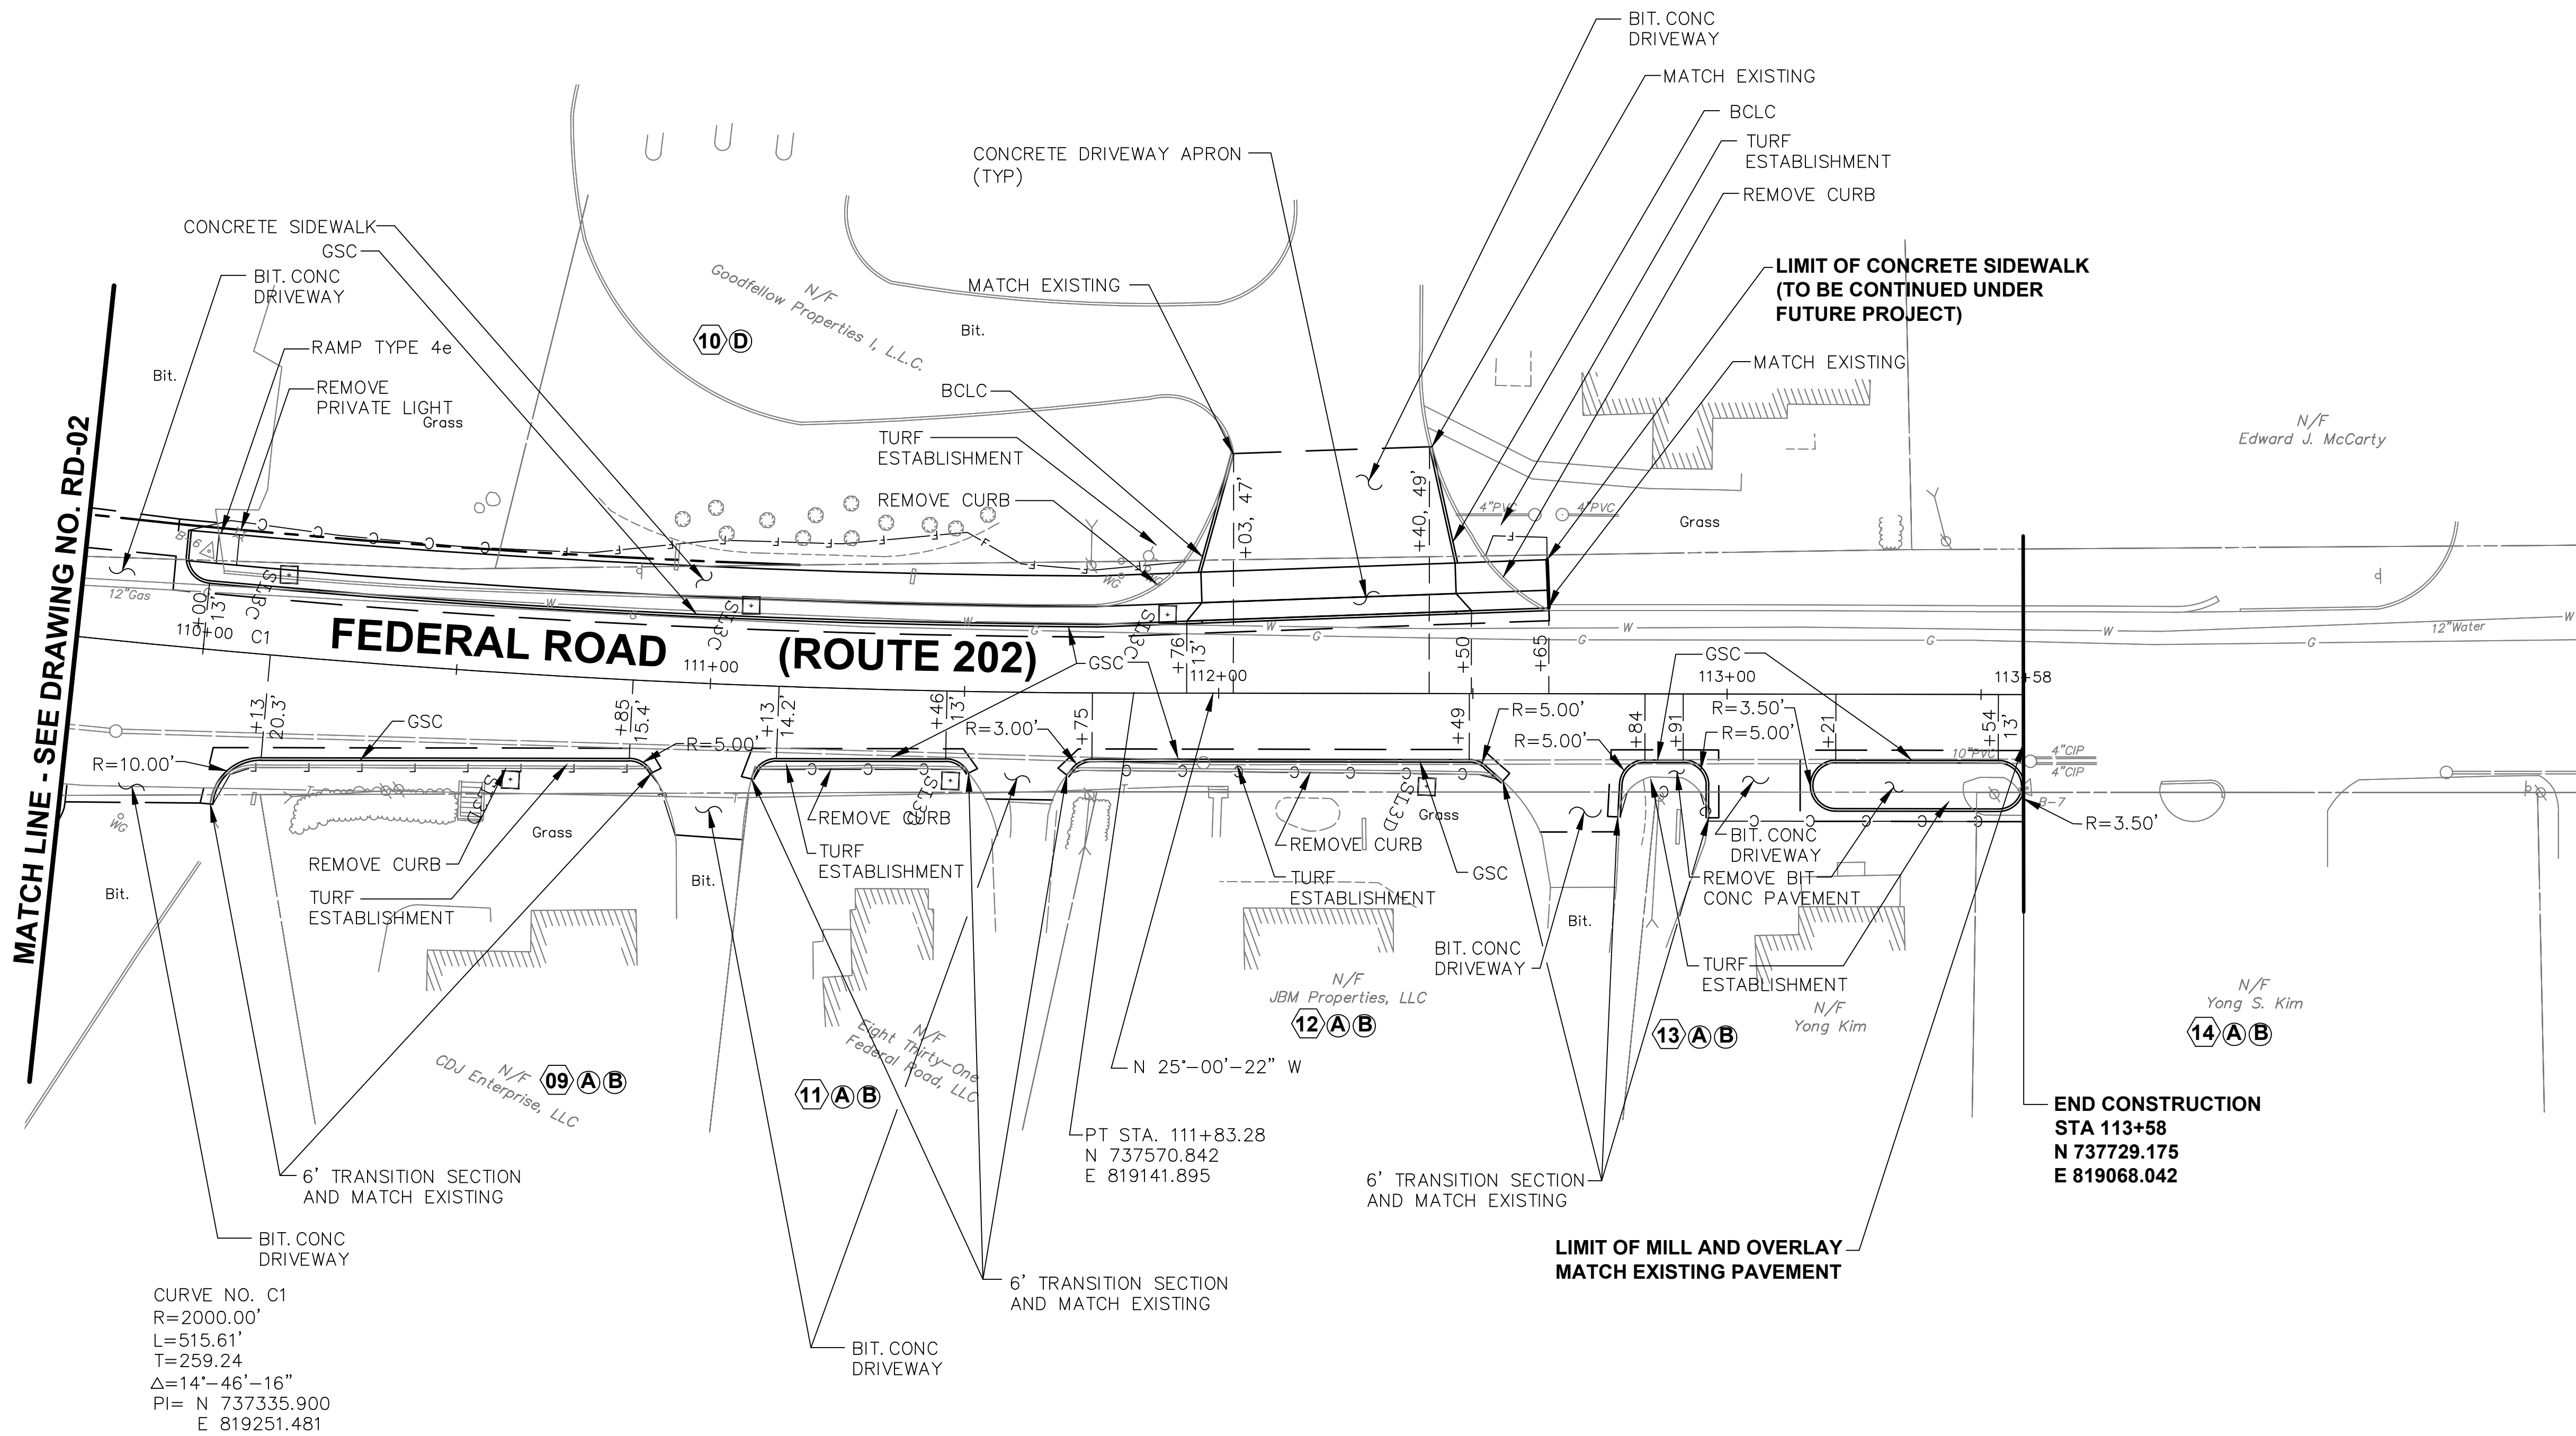
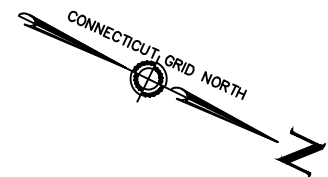
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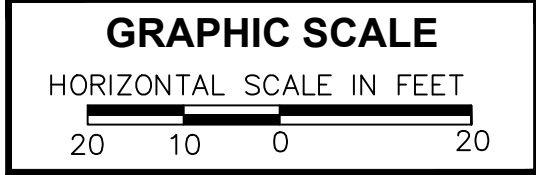
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NOTES:

1. TYPICAL WALKWAY SHALL COMPLY WITH THE FOLLOWING:
 - a. SURFACE MATERIAL TO MATCH EXISTING TYPE.
 - b. MAINTAIN WHERE POSSIBLE EXISTING SLOPES.



TOWN OF BROOKFIELD, CT

PROJECT NAME: **TOWN DISTRICT SIDEWALK AND ACCESS MANAGEMENT PLAN**

SHEET TITLE: **ROADWAY PLAN, SHEET 3**

FILE NAME:----

PLOT DATE: 4/20/2016

DRAWING NO.: **RD-03**


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DESIGNED BY: AG

DRAWN BY: AG
CHECKED BY: PG

SHEET NO.: **34**

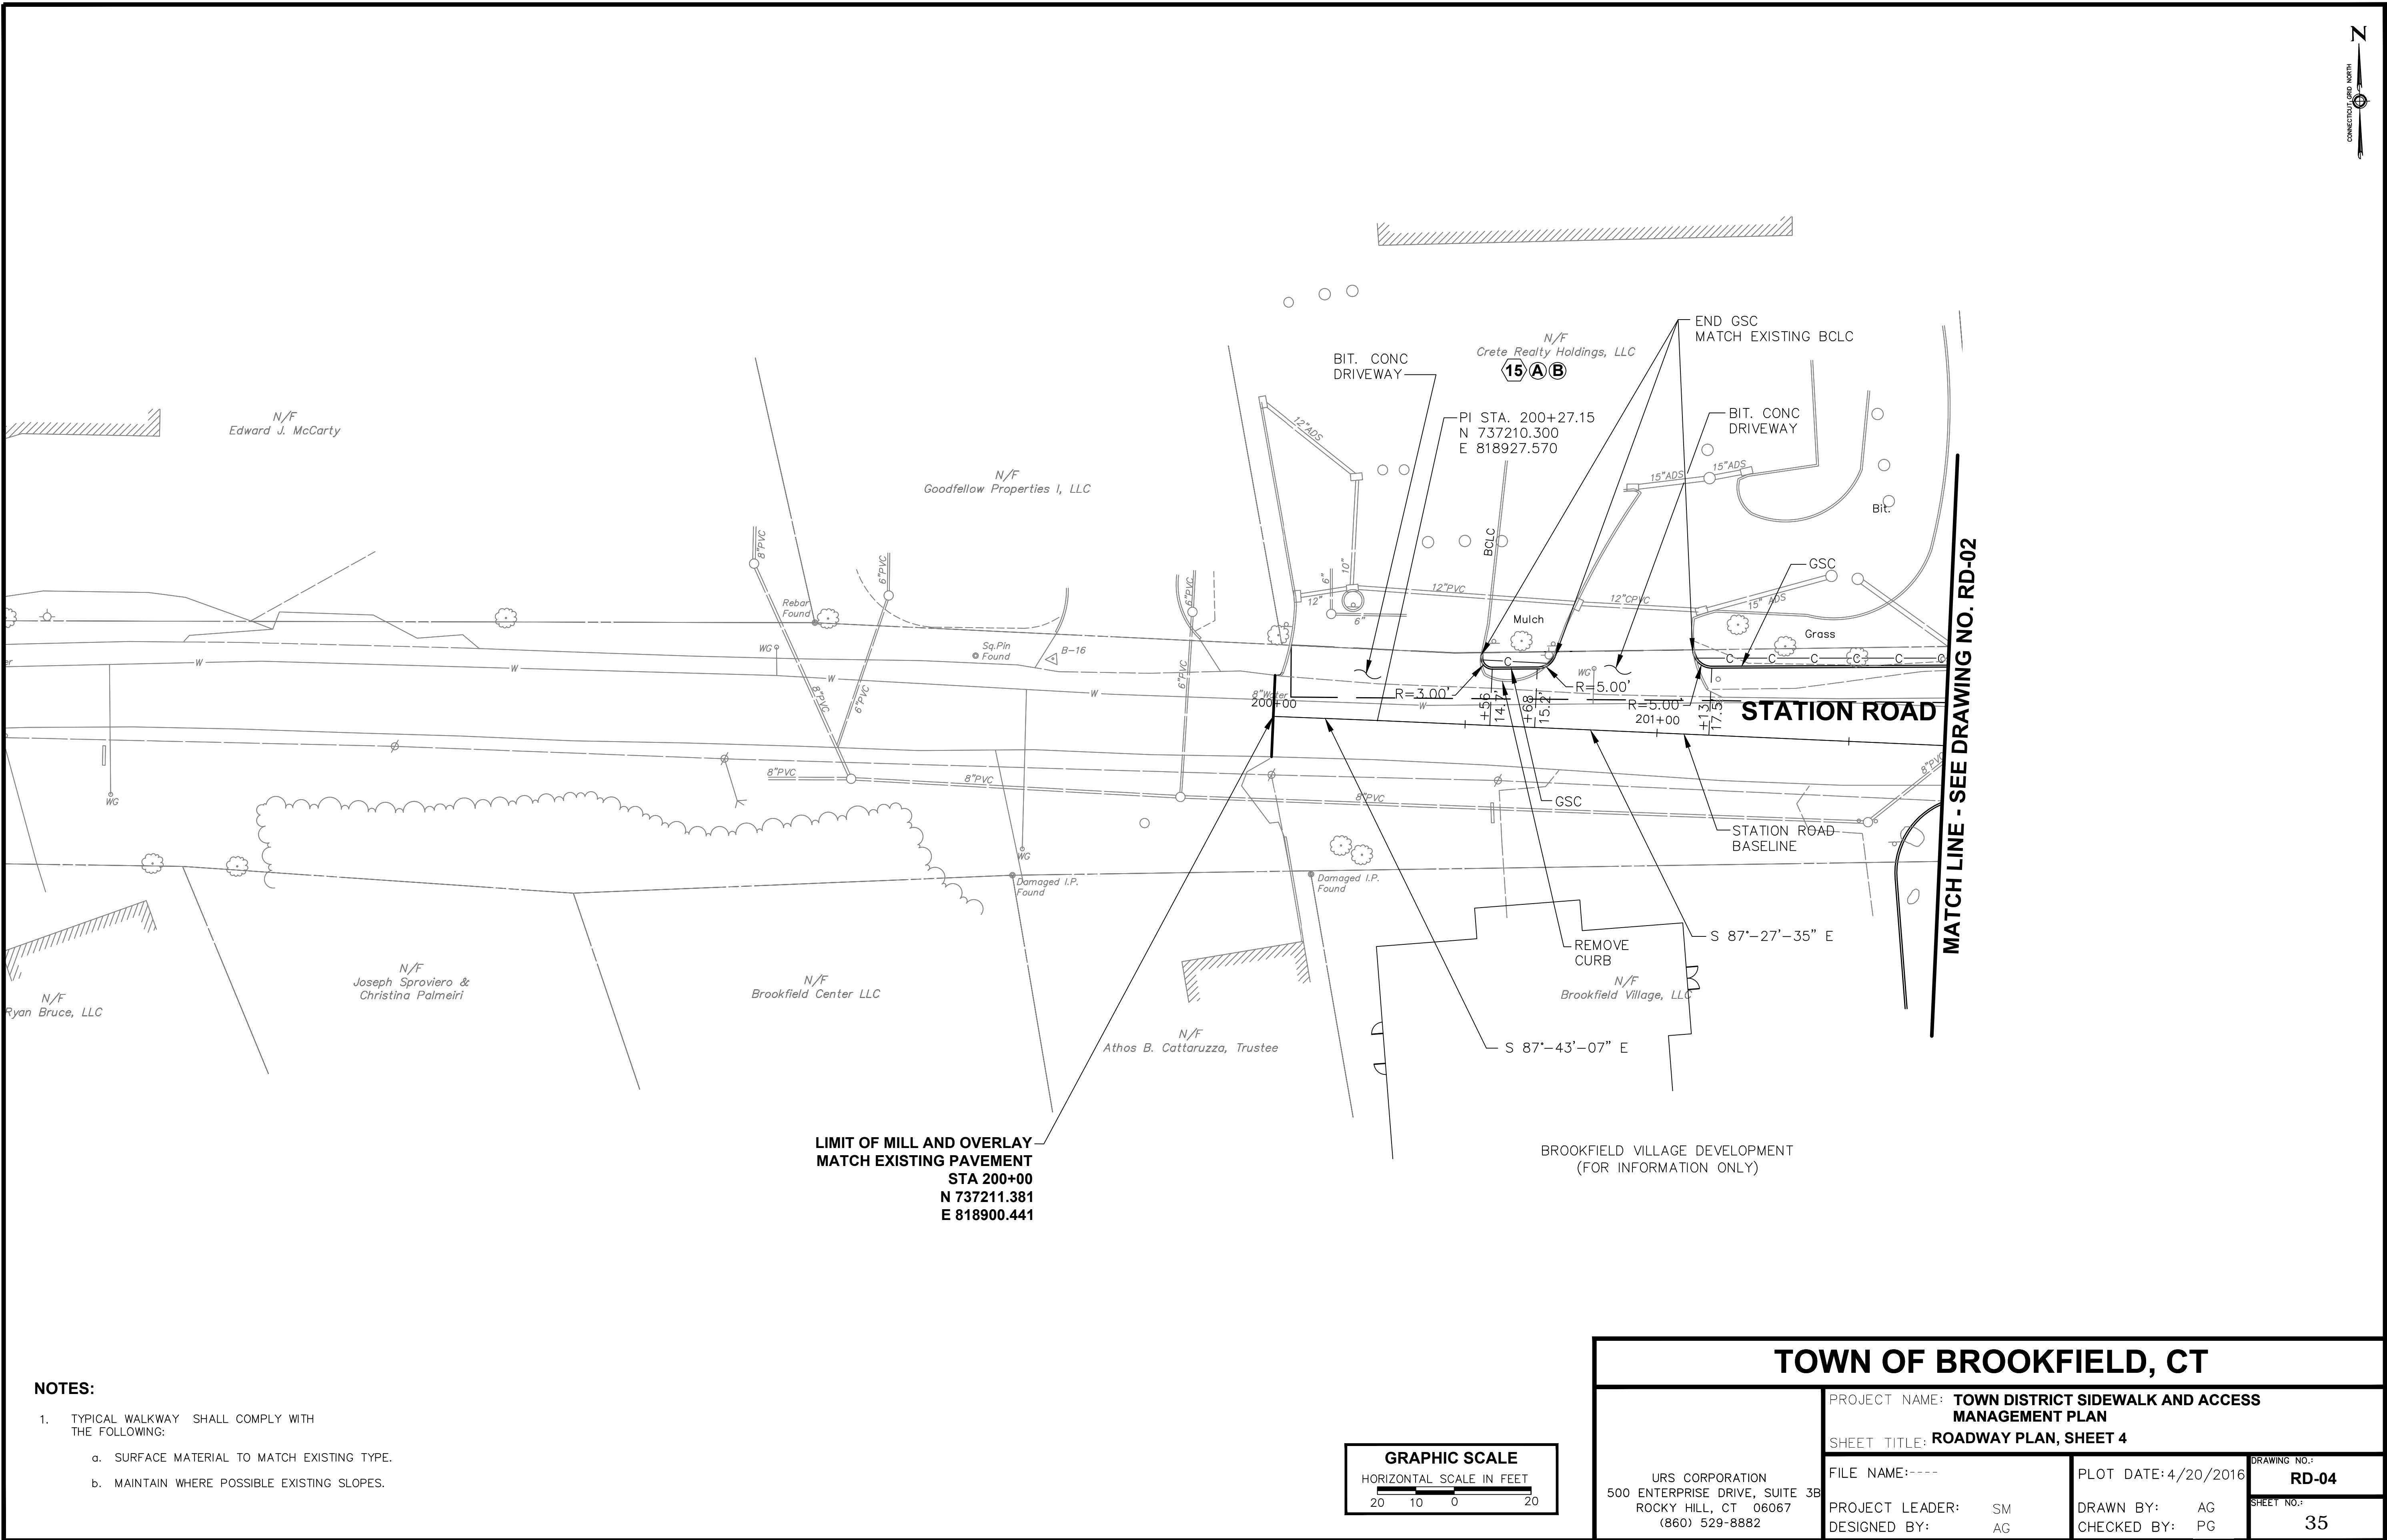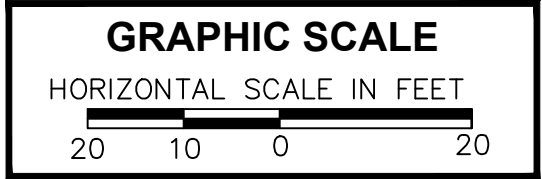
URS CORPORATION
500 ENTERPRISE DRIVE, SUITE 3B
ROCKY HILL, CT 06067
(860) 529-8882

4/15/2015 10:17 AM
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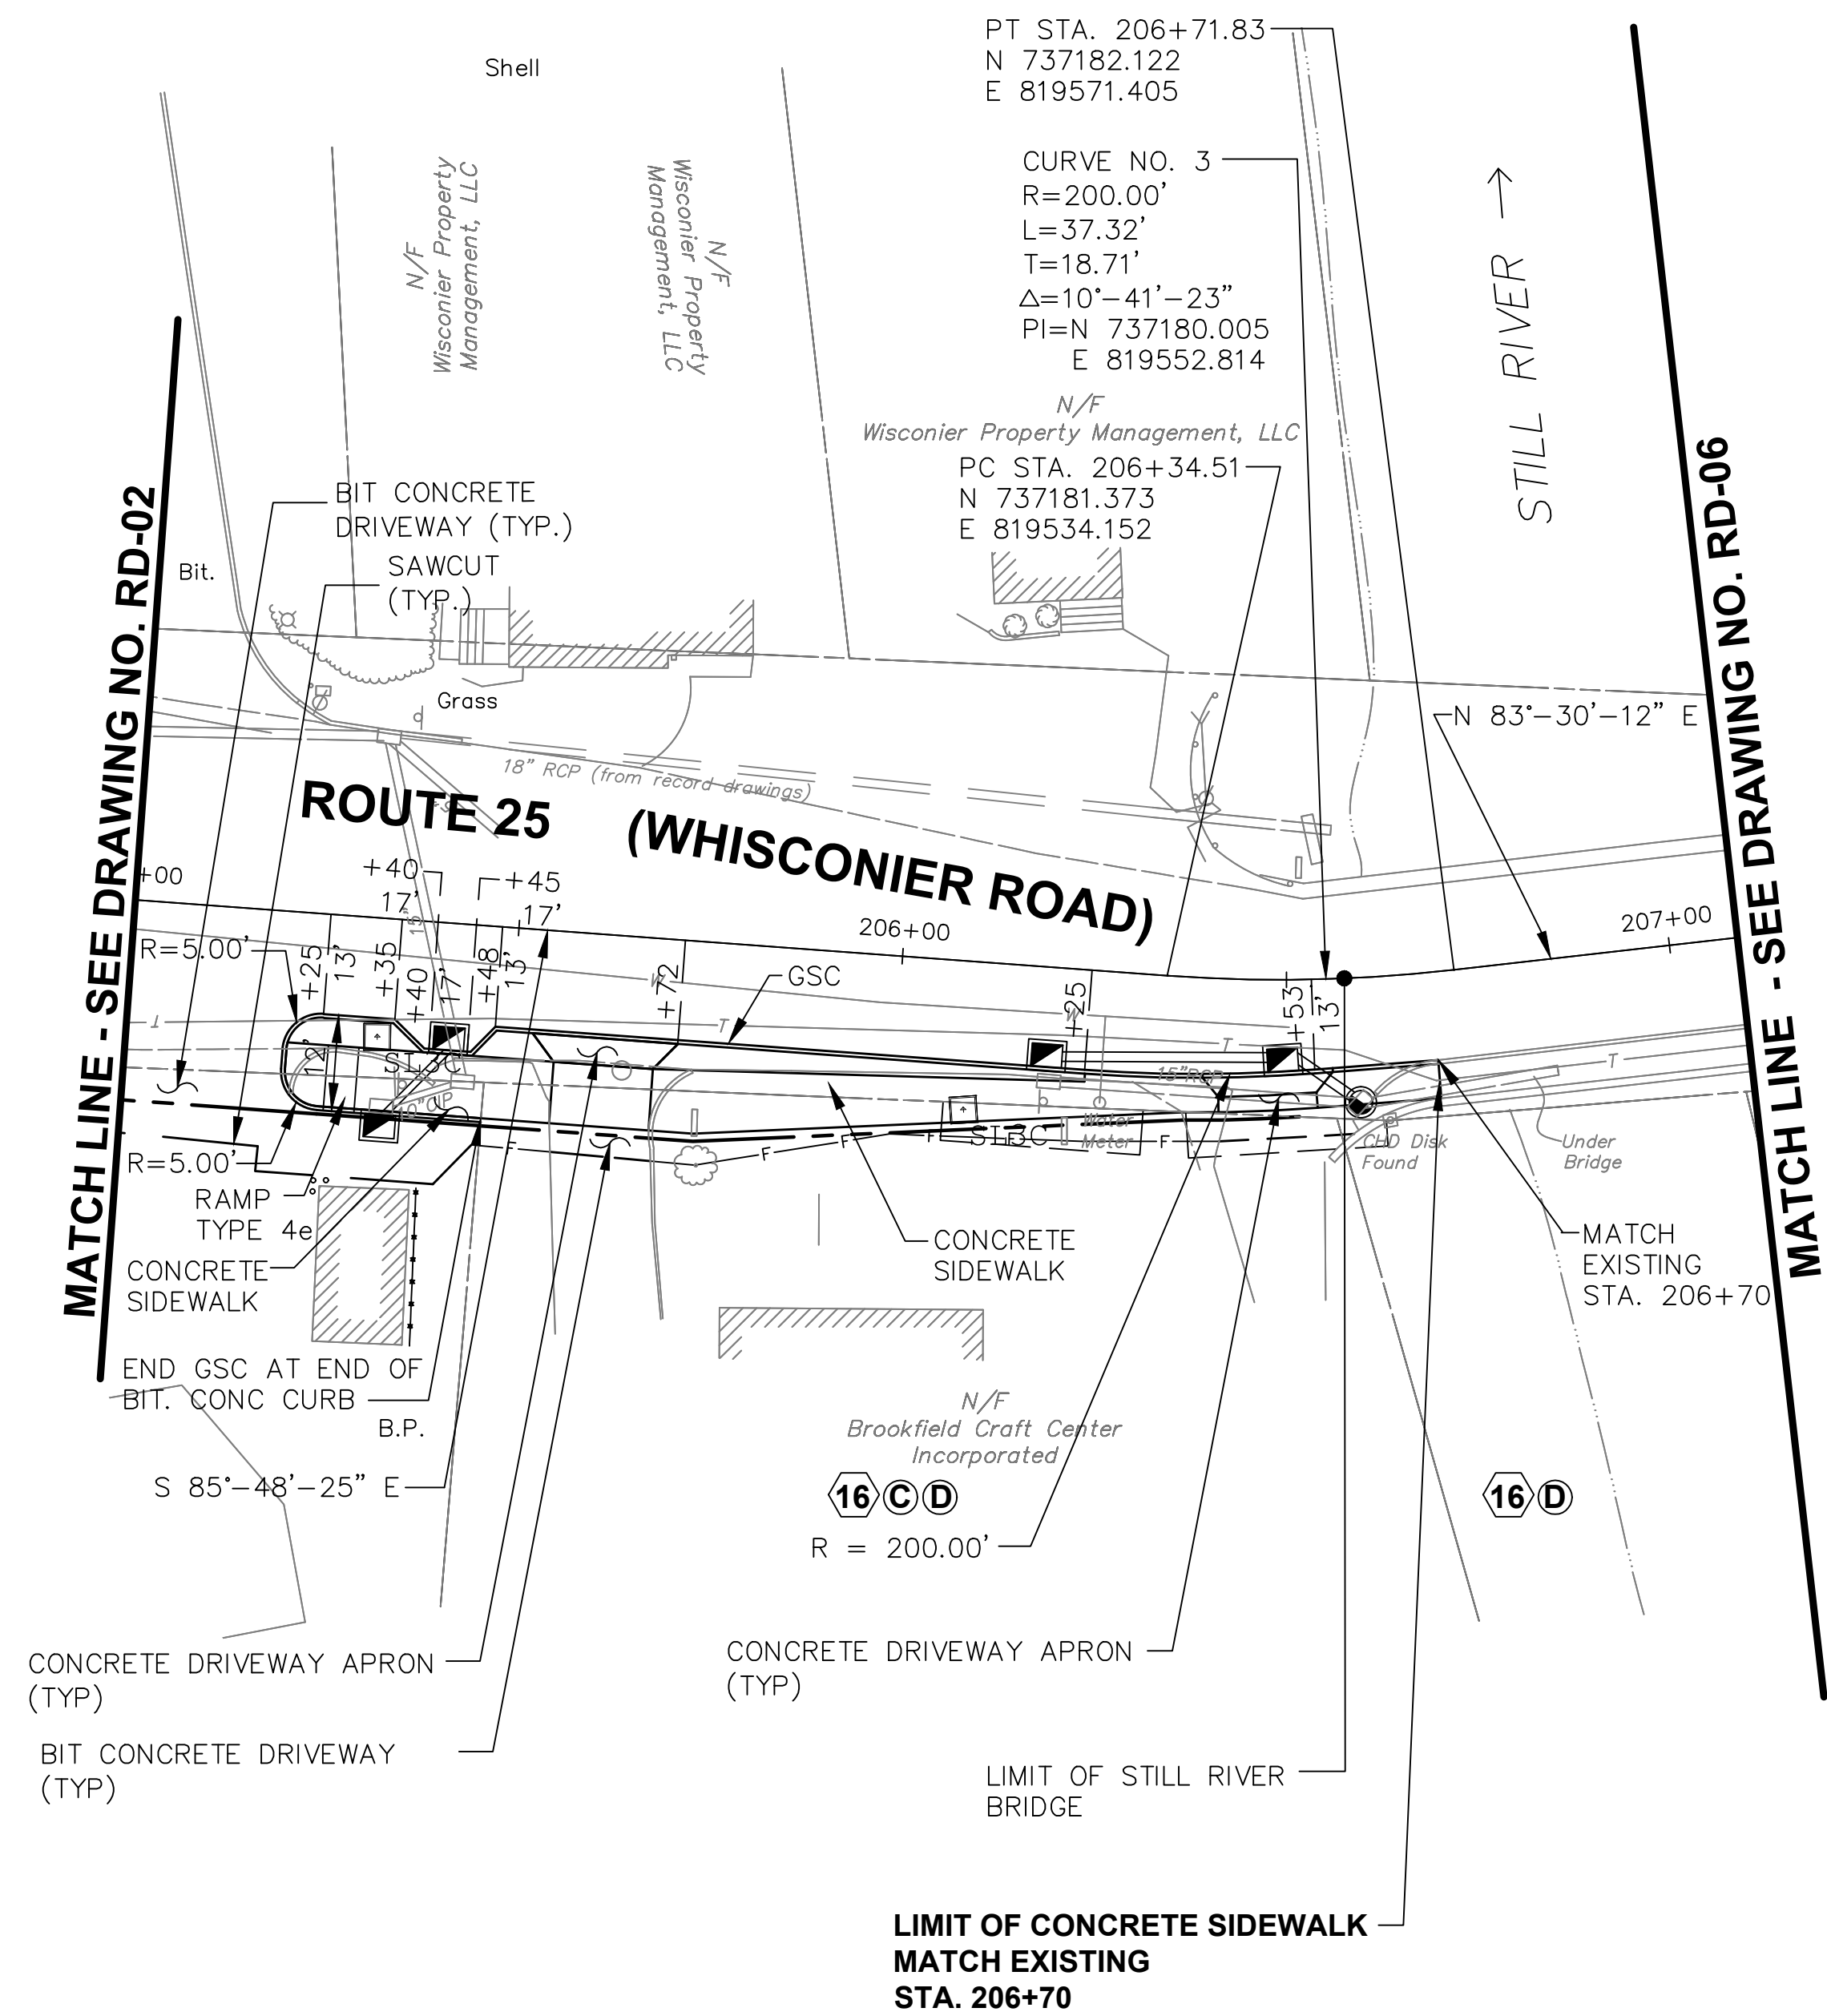
NOTES:

1. TYPICAL WALKWAY SHALL COMPLY WITH THE FOLLOWING:
 - a. SURFACE MATERIAL TO MATCH EXISTING TYPE.
 - b. MAINTAIN WHERE POSSIBLE EXISTING SLOPES.




TOWN OF BROOKFIELD, CT			
URS CORPORATION 500 ENTERPRISE DRIVE, SUITE 3B ROCKY HILL, CT 06067 (860) 529-8882	PROJECT NAME: TOWN DISTRICT SIDEWALK AND ACCESS MANAGEMENT PLAN		
	SHEET TITLE: ROADWAY PLAN, SHEET 4		
	FILE NAME:----	PLOT DATE: 4/20/2016	DRAWING NO.: RD-04
	PROJECT LEADER: SM	DRAWN BY: AG	SHEET NO.: 35
	DESIGNED BY: AG	CHECKED BY: PG	

4/15/2015 10:18 AM
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NOTES:

1. TYPICAL WALKWAY SHALL COMPLY WITH THE FOLLOWING:
 - a. SURFACE MATERIAL TO MATCH EXISTING TYPE.
 - b. MAINTAIN WHERE POSSIBLE EXISTING SLOPES.



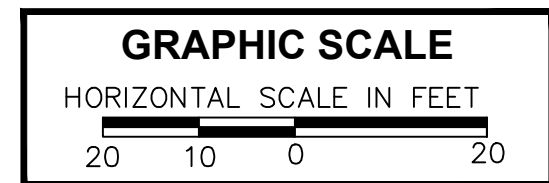TOWN OF BROOKFIELD, CT

PROJECT NAME: **TOWN DISTRICT SIDEWALK AND ACCESS MANAGEMENT PLAN**

SHEET TITLE: **ROADWAY PLAN, SHEET 5**

FILE NAME:----

PROJECT LEADER: SM
DESIGNED BY: AG

PLOT DATE: 4/20/2016

DRAWN BY: AG
CHECKED BY: PG



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RD-05

SHEET NO.:

36

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TOWN OF BROOKFIELD, CT

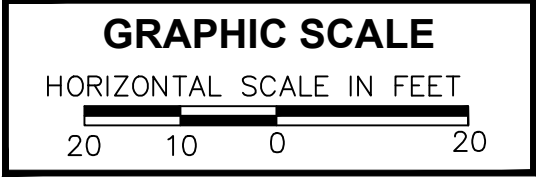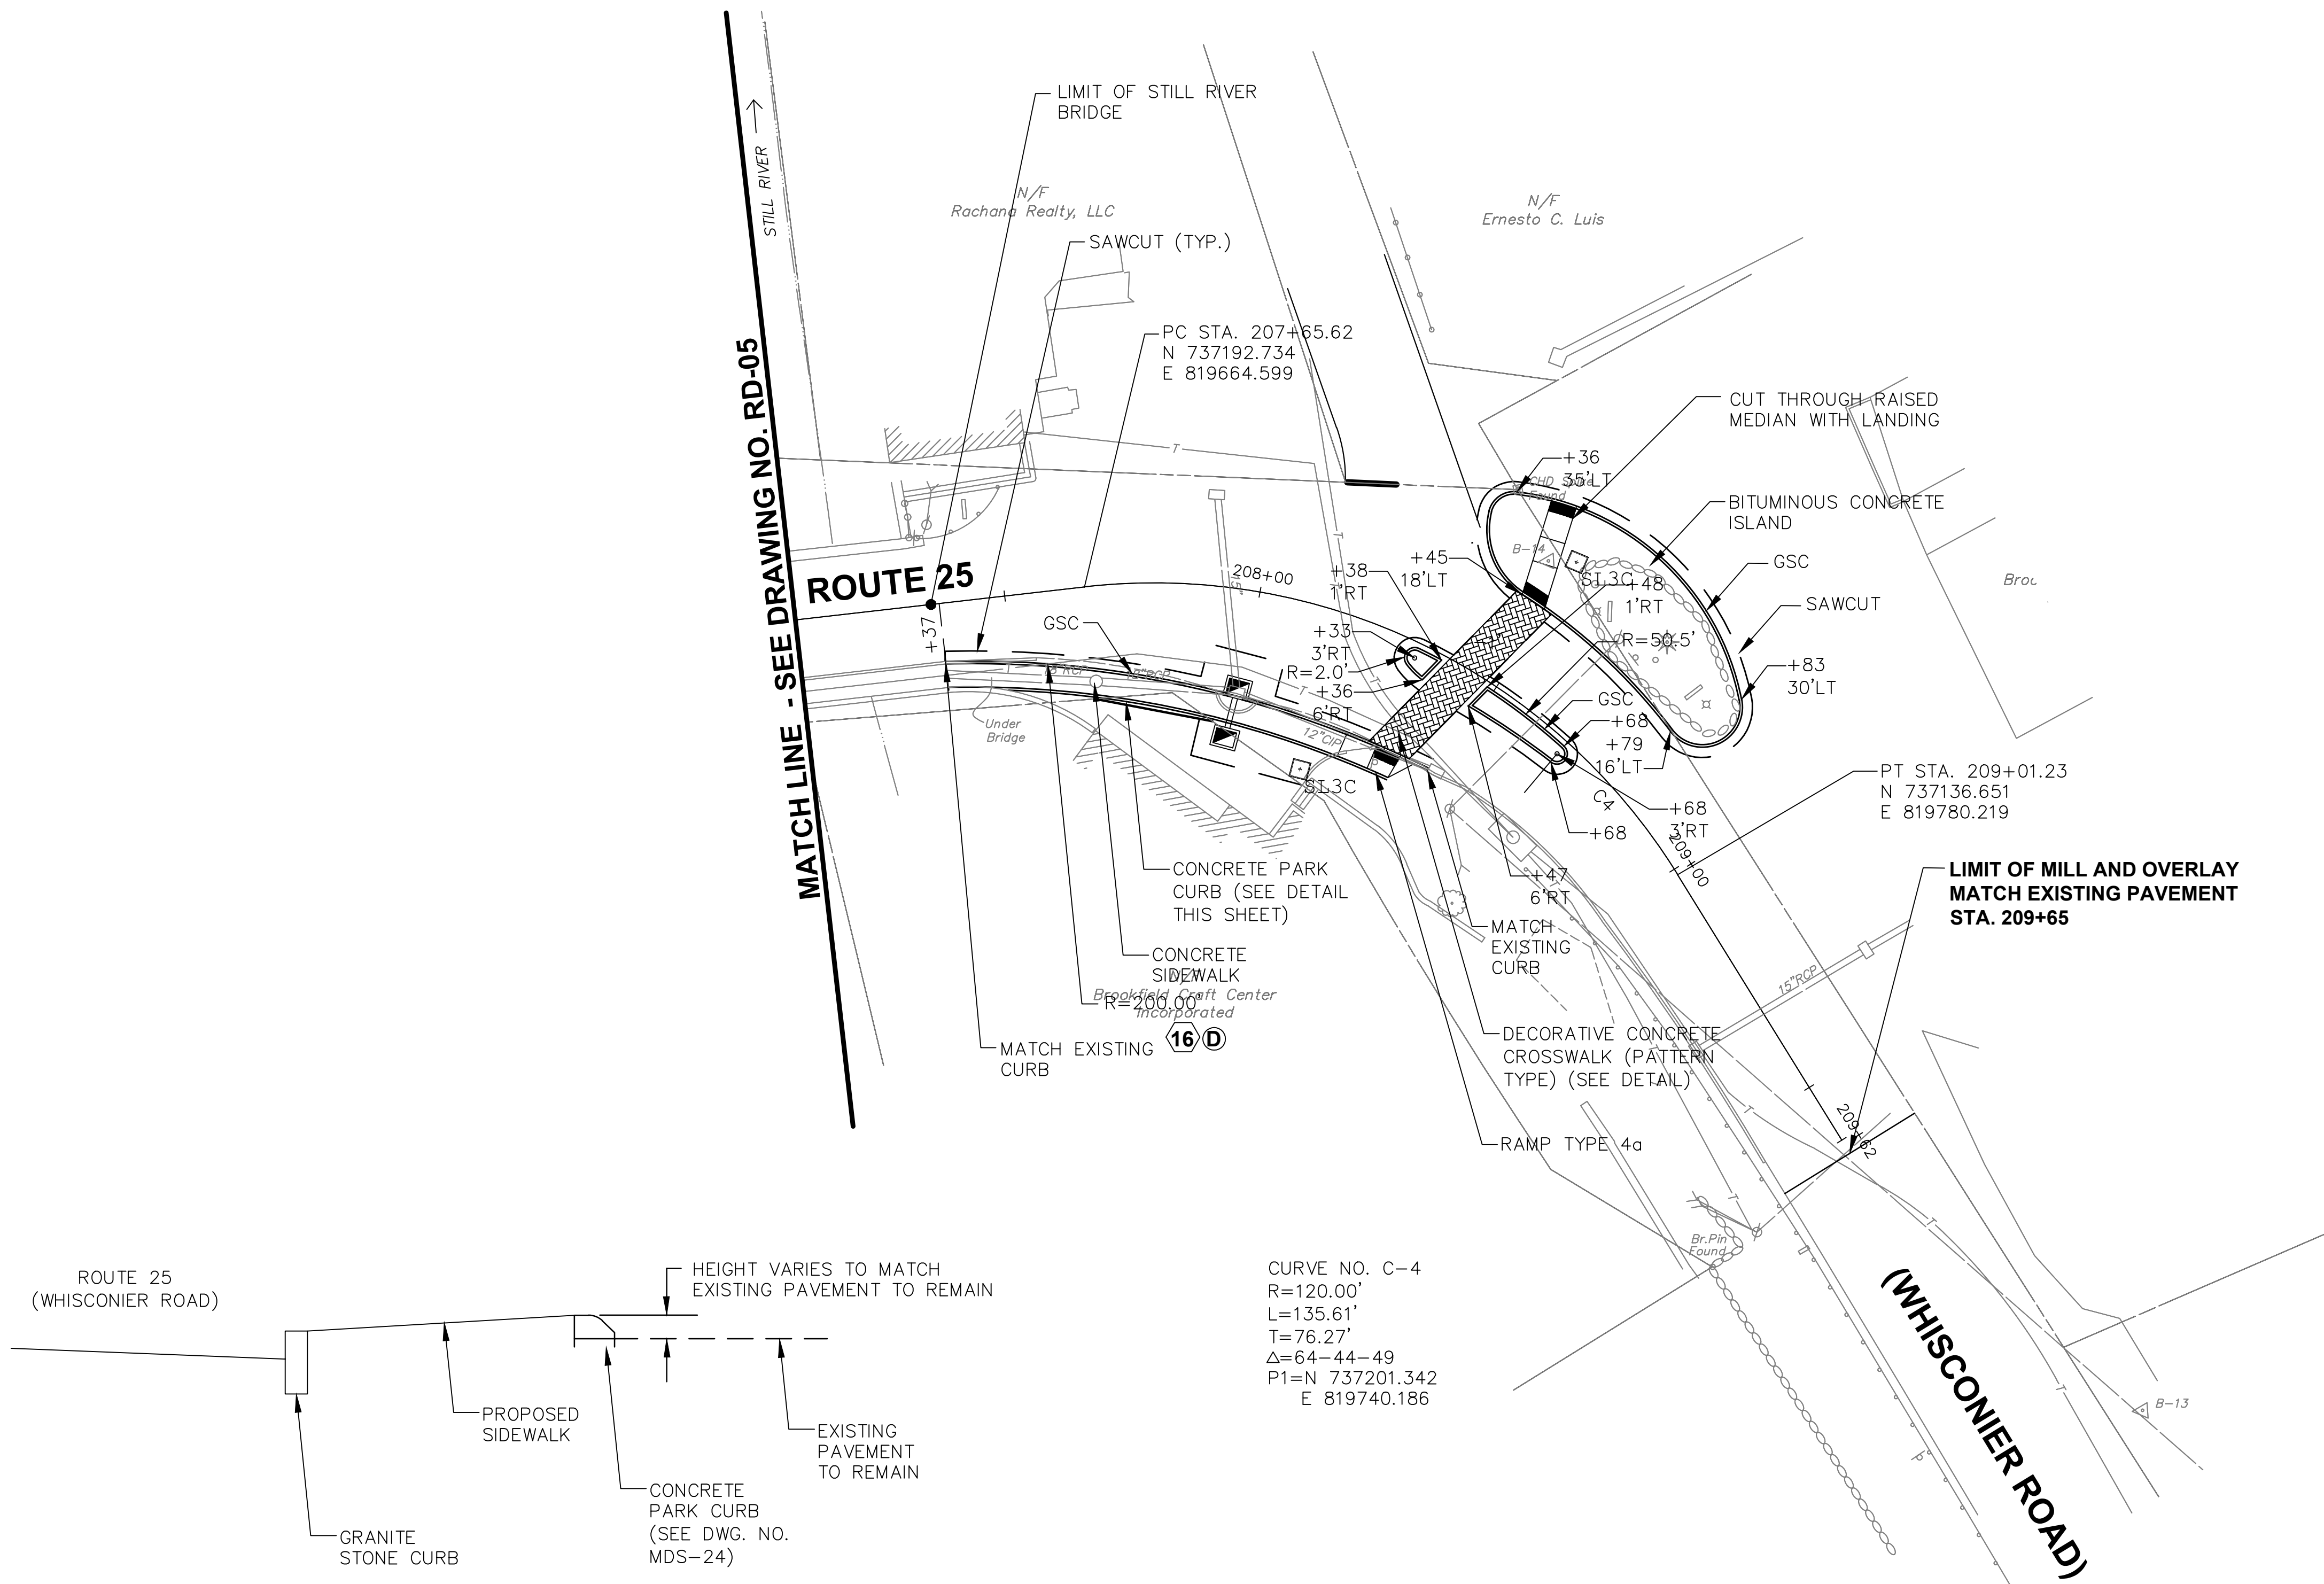PROJECT NAME: **TOWN DISTRICT SIDEWALK AND ACCESS MANAGEMENT PLAN**

SHEET TITLE: **ROADWAY PLAN, SHEET 6**

FILE NAME:----

PLOT DATE: 4/20/2016

DRAWING NO.:

RD-06

PROJECT LEADER: SM
DESIGNED BY: AG



DRAWN BY: AG
CHECKED BY: PG

SHEET NO.:

37

URS CORPORATION
500 ENTERPRISE DRIVE, SUITE 3B
ROCKY HILL, CT 06067
(860) 529-8882

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TOWN OF BROOKFIELD, CT

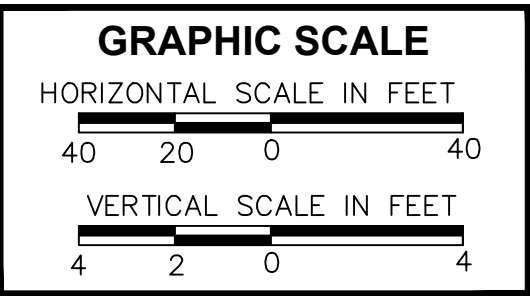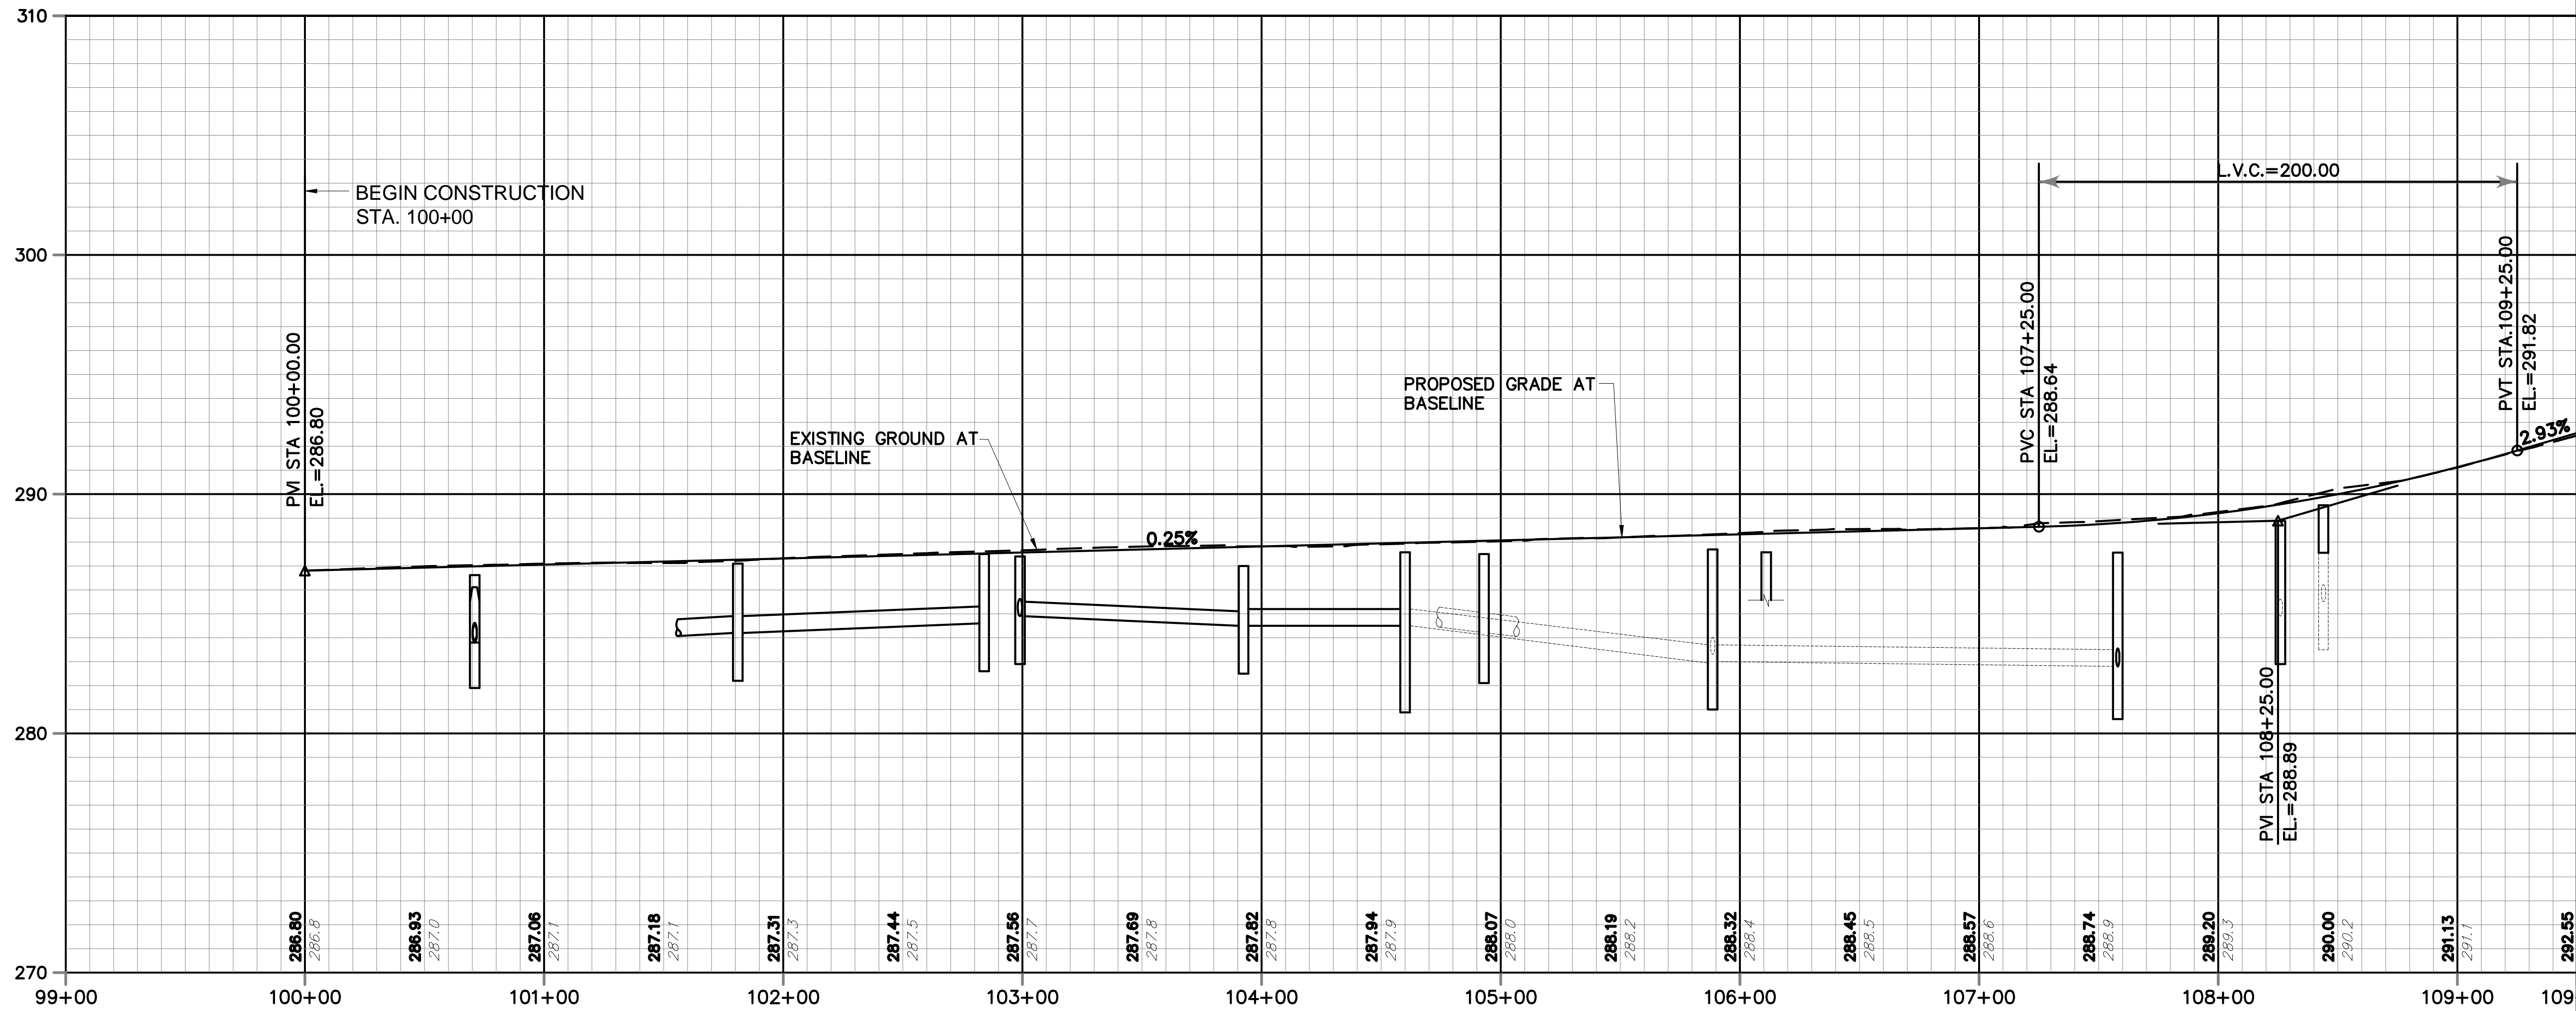PROJECT NAME: **TOWN DISTRICT SIDEWALK AND ACCESS MANAGEMENT PLAN**

SHEET TITLE: **FEDERAL ROAD PROFILE, SHEET 1**

FILE NAME:----

PROJECT LEADER: SM
DESIGNED BY: AG



PLOT DATE: 4/20/2016

DRAWN BY: AG
CHECKED BY: PG

DRAWING NO.: **PRO-01**

SHEET NO.: **38**

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TOWN OF BROOKFIELD, CT

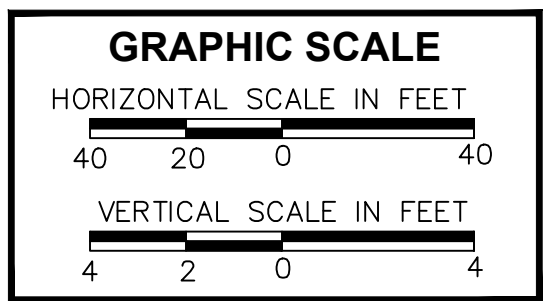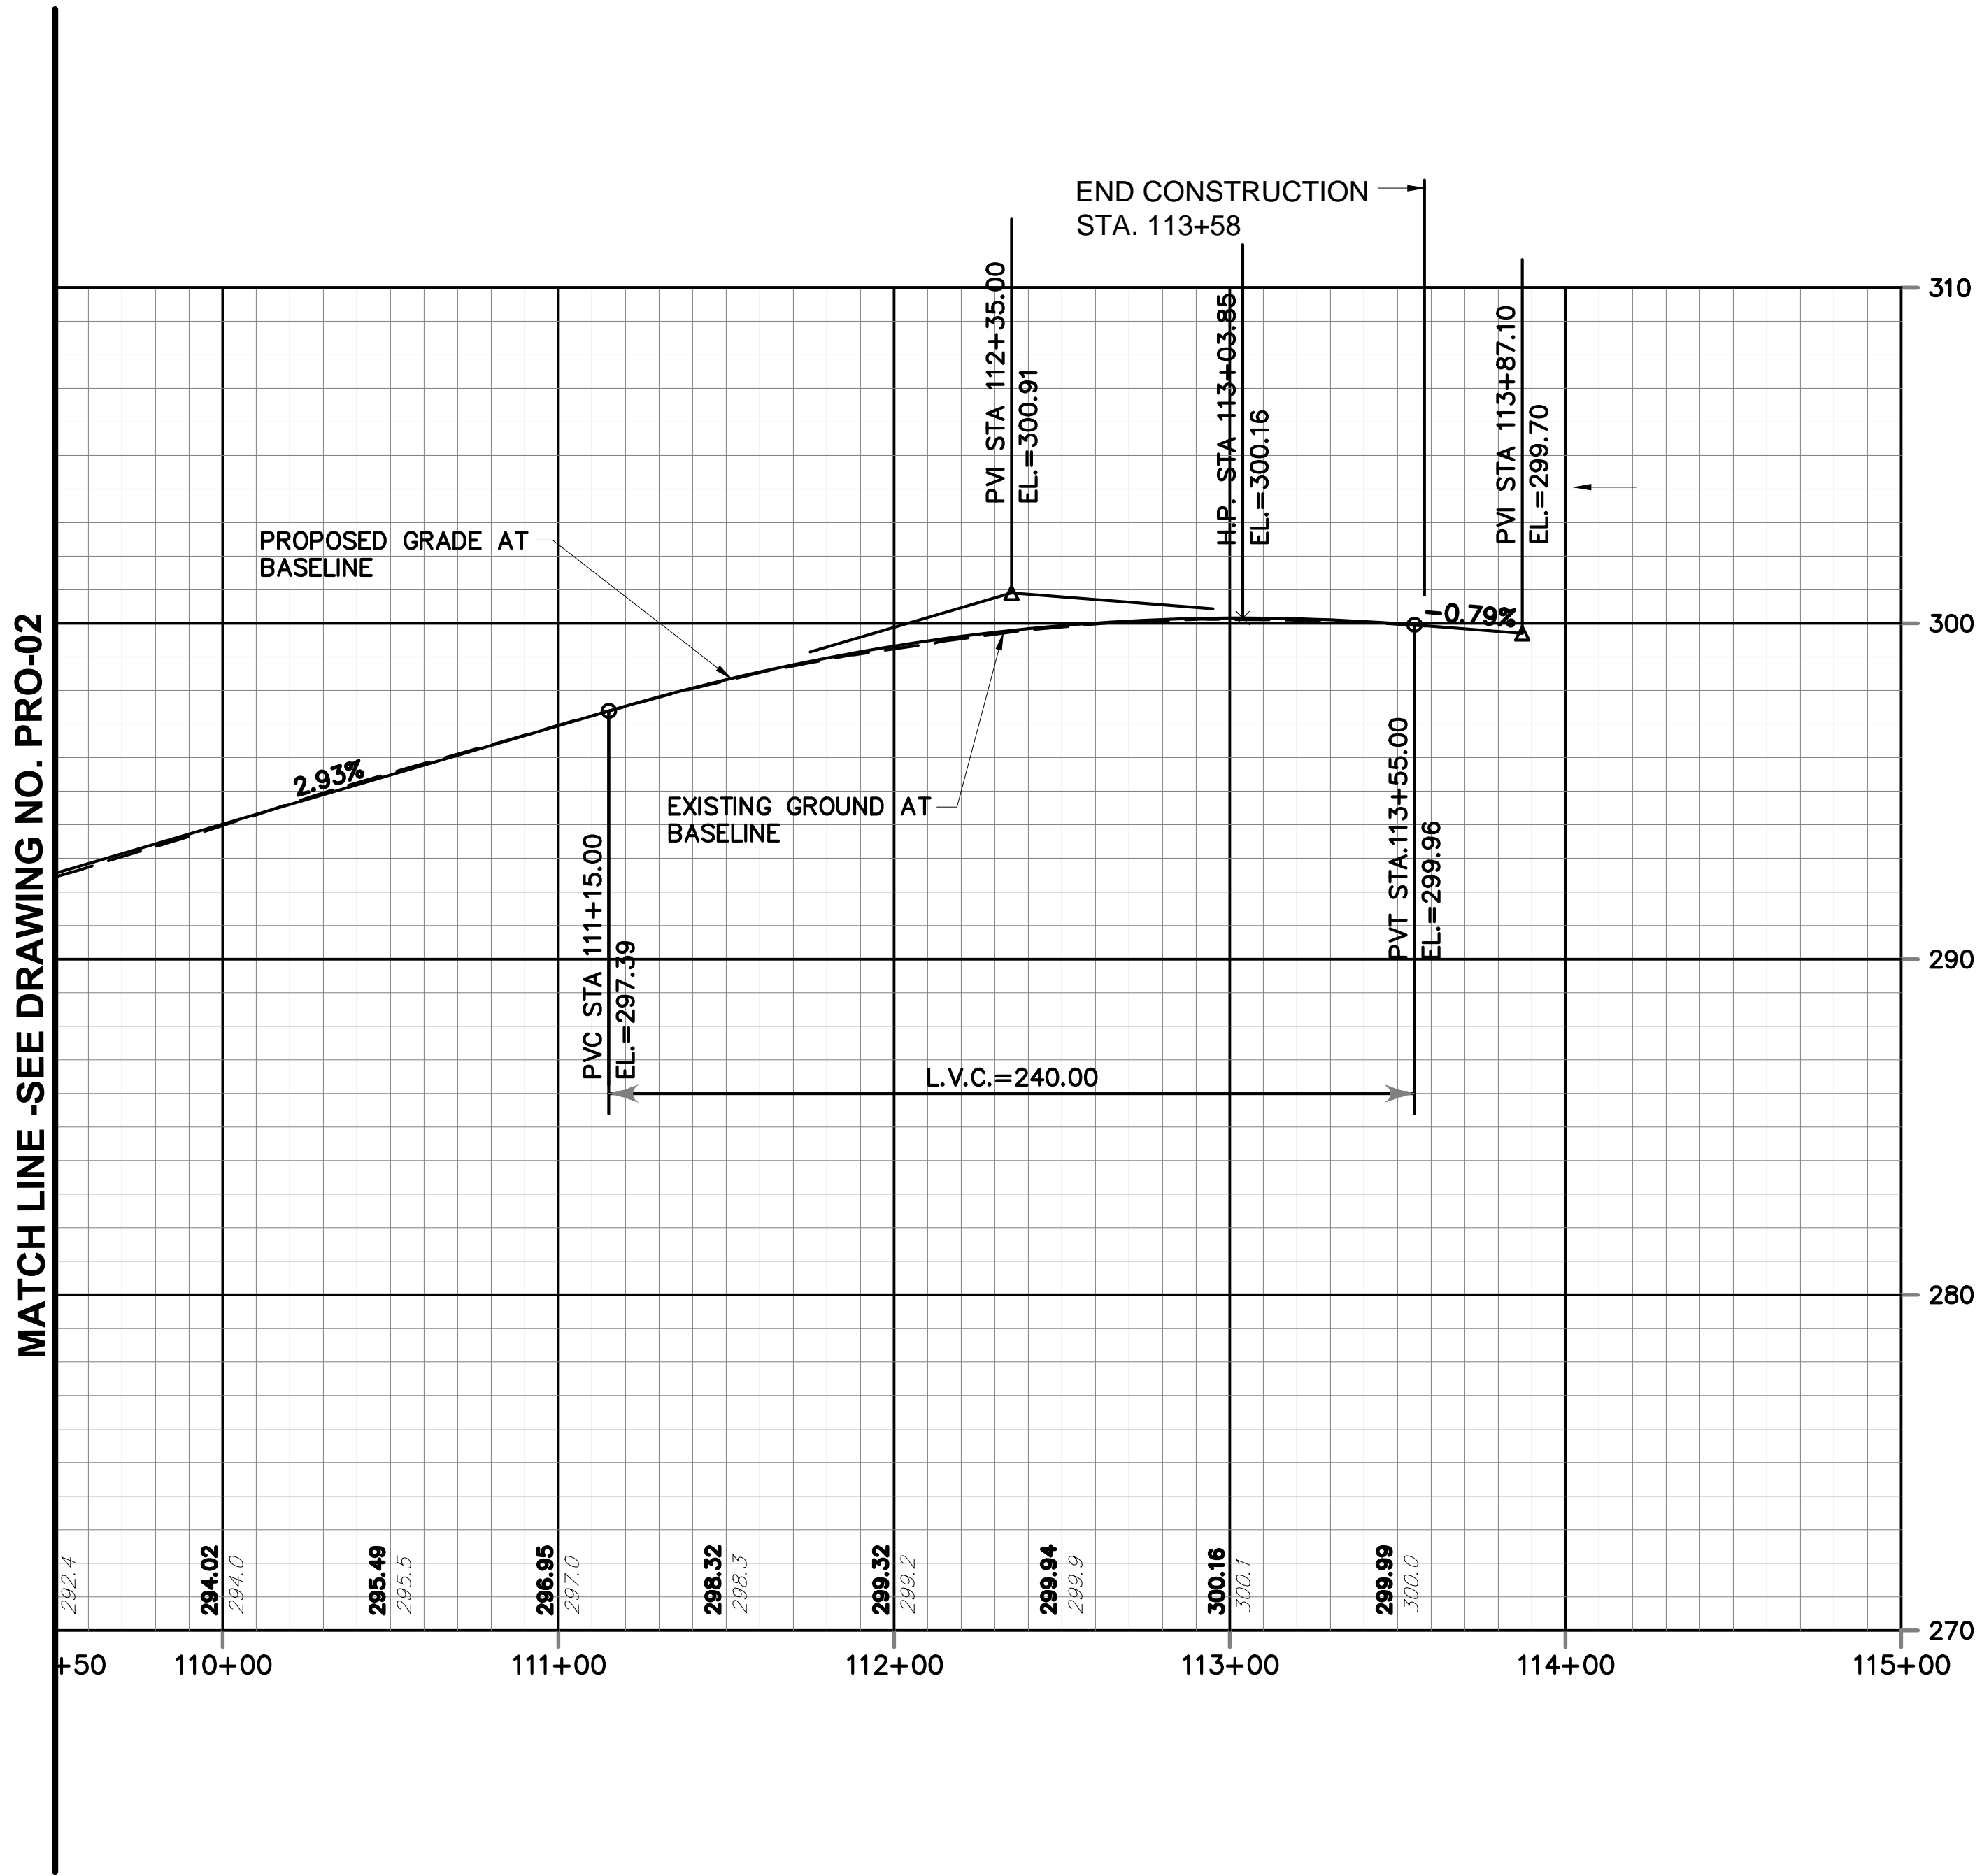PROJECT NAME: **TOWN DISTRICT SIDEWALK AND ACCESS
MANAGEMENT PLAN**

SHEET TITLE: **FEDERAL ROAD PROFILE, SHEET 2**

FILE NAME:----

PROJECT LEADER: SM
DESIGNED BY: AG

PLOT DATE: 4/20/2016



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DRAWING NO.: **PRO-02**

SHEET NO.:



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TOWN OF BROOKFIELD, CT				
URS CORPORATION 500 ENTERPRISE DRIVE, SUITE 3B ROCKY HILL, CT 06067 (860) 529-8882	PROJECT NAME: TOWN DISTRICT SIDEWALK AND ACCESS MANAGEMENT PLAN			
	SHEET TITLE: STATION & WHISICONIER ROAD PROFILE, SHEET 3			
	FILE NAME:-----	PLOT DATE: 4/20/2016	DRAWING NO.: PRO-03	
PROJECT LEADER: SM		DRAWN BY: AG	SHEET NO.: 40	
DESIGNED BY: AG		CHECKED BY: PG		


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MATCH LINE - SEE DRAWING NO. DN-02

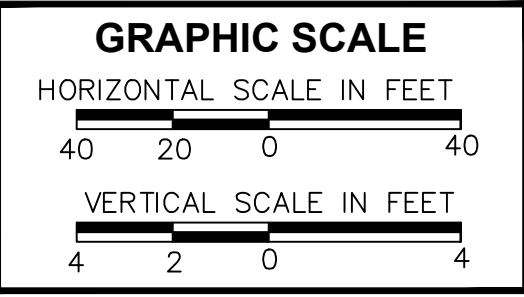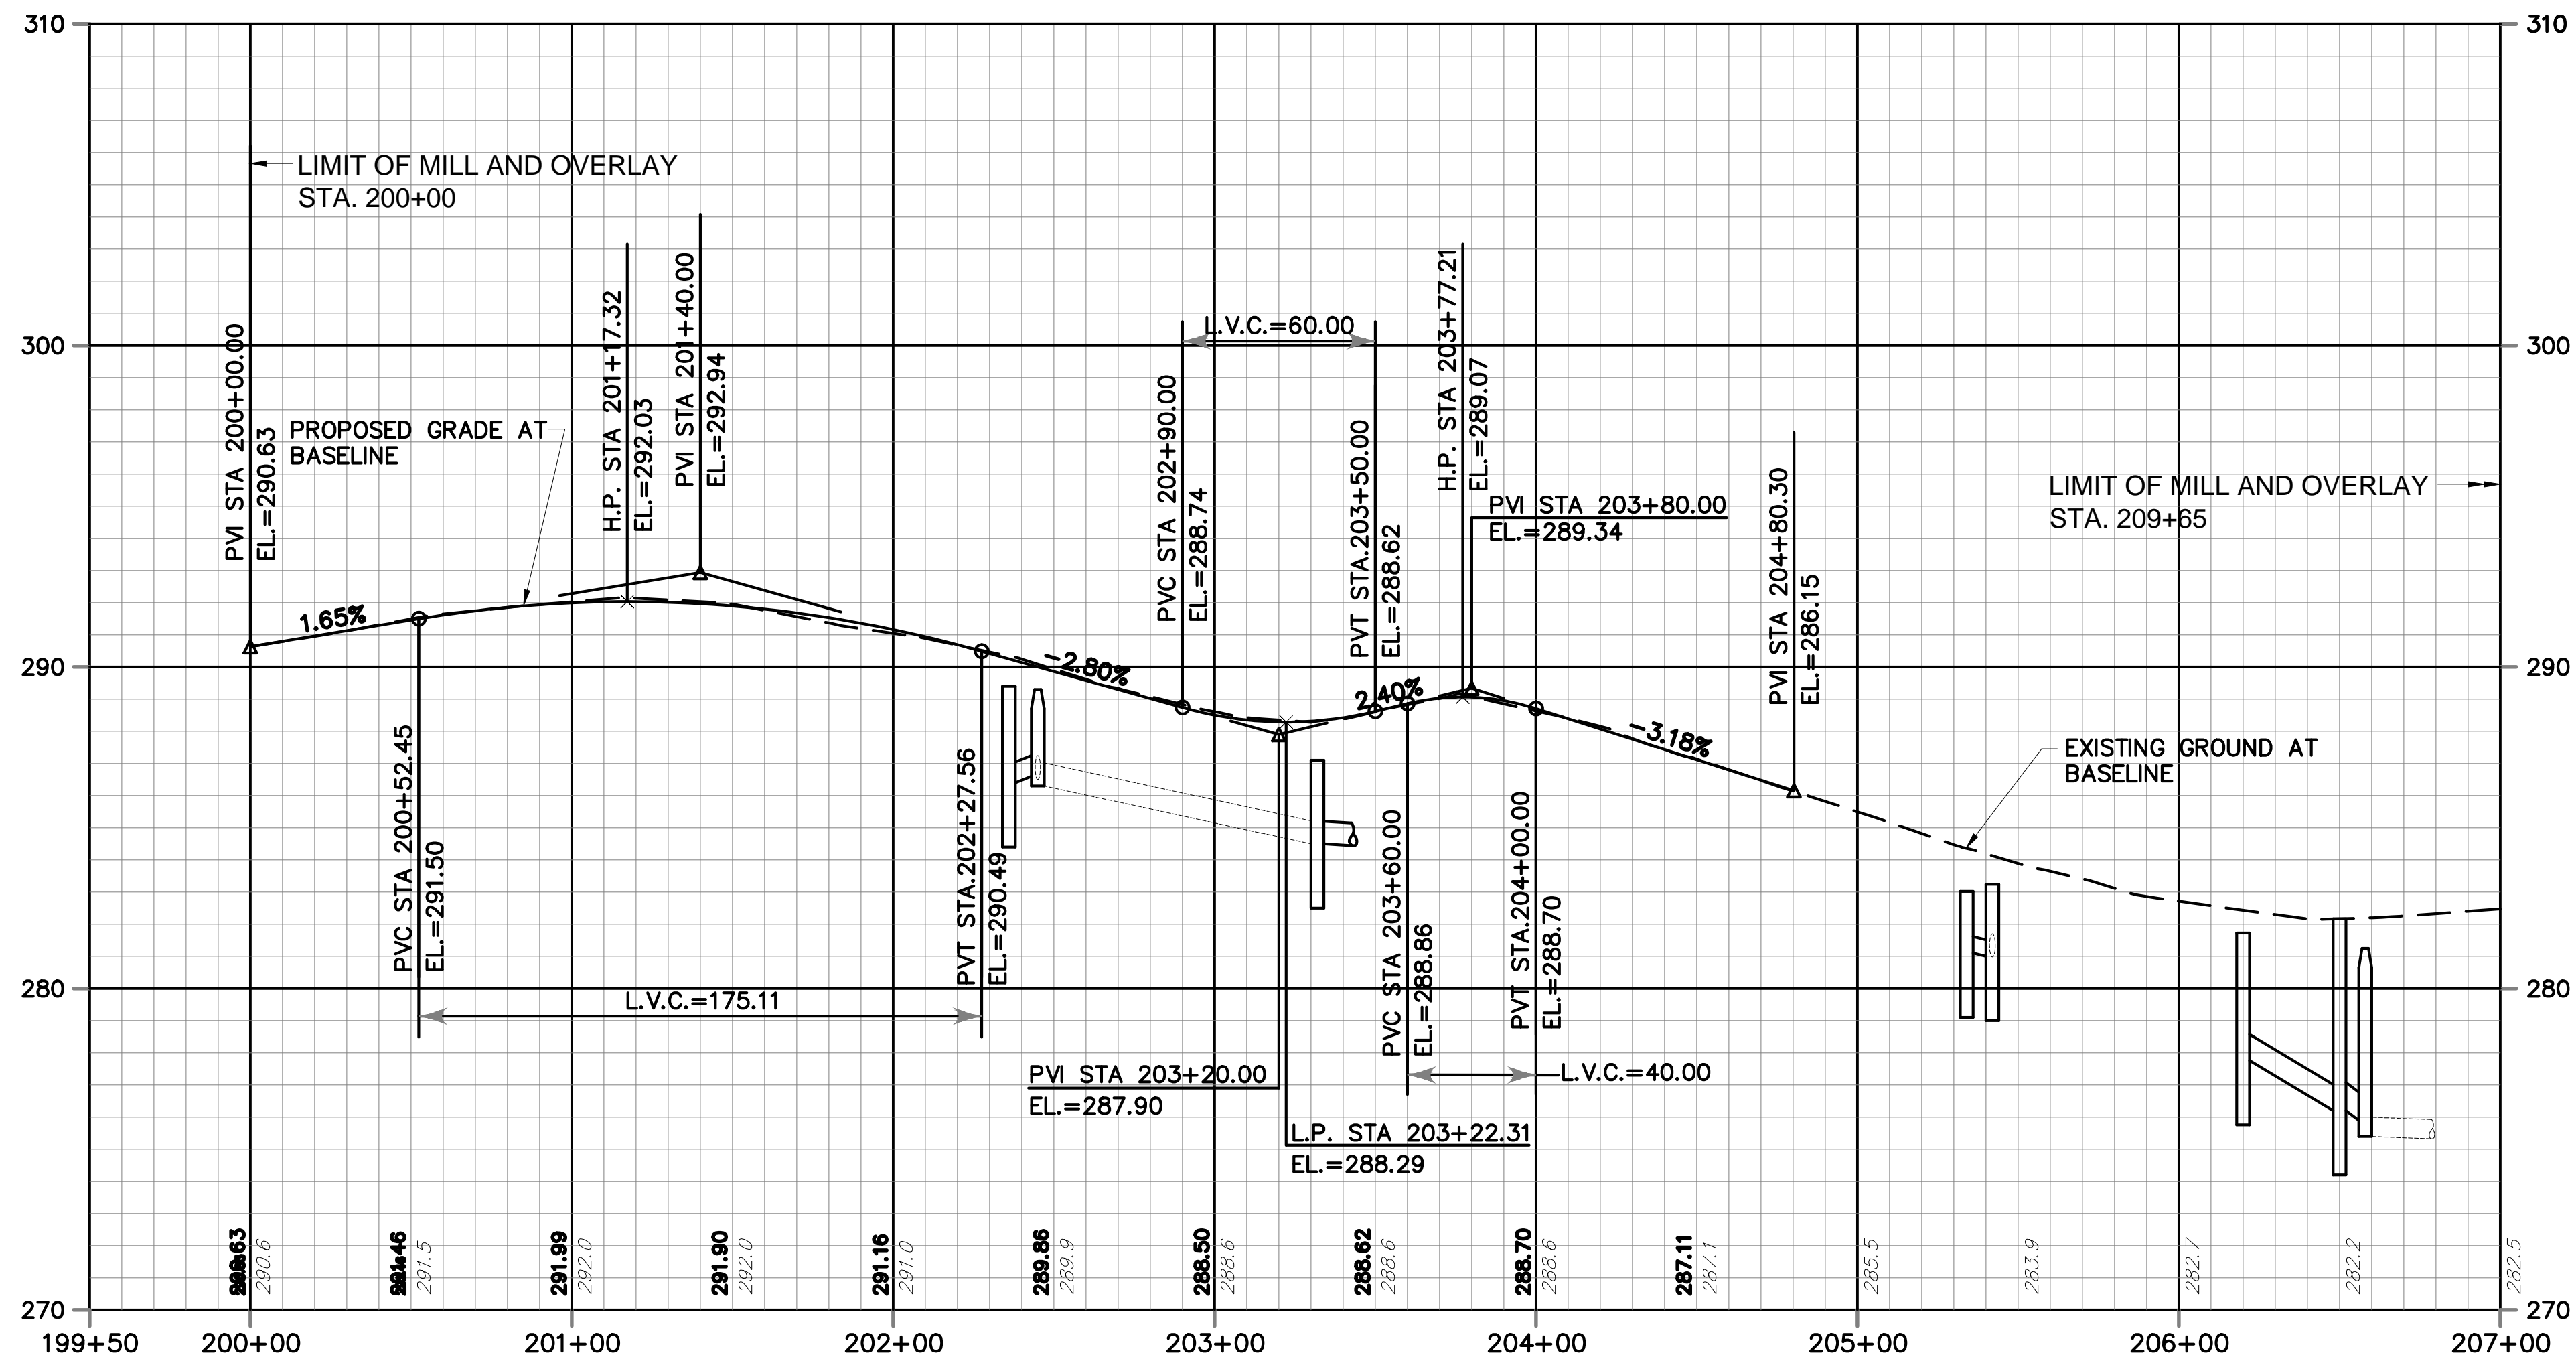NOTES:

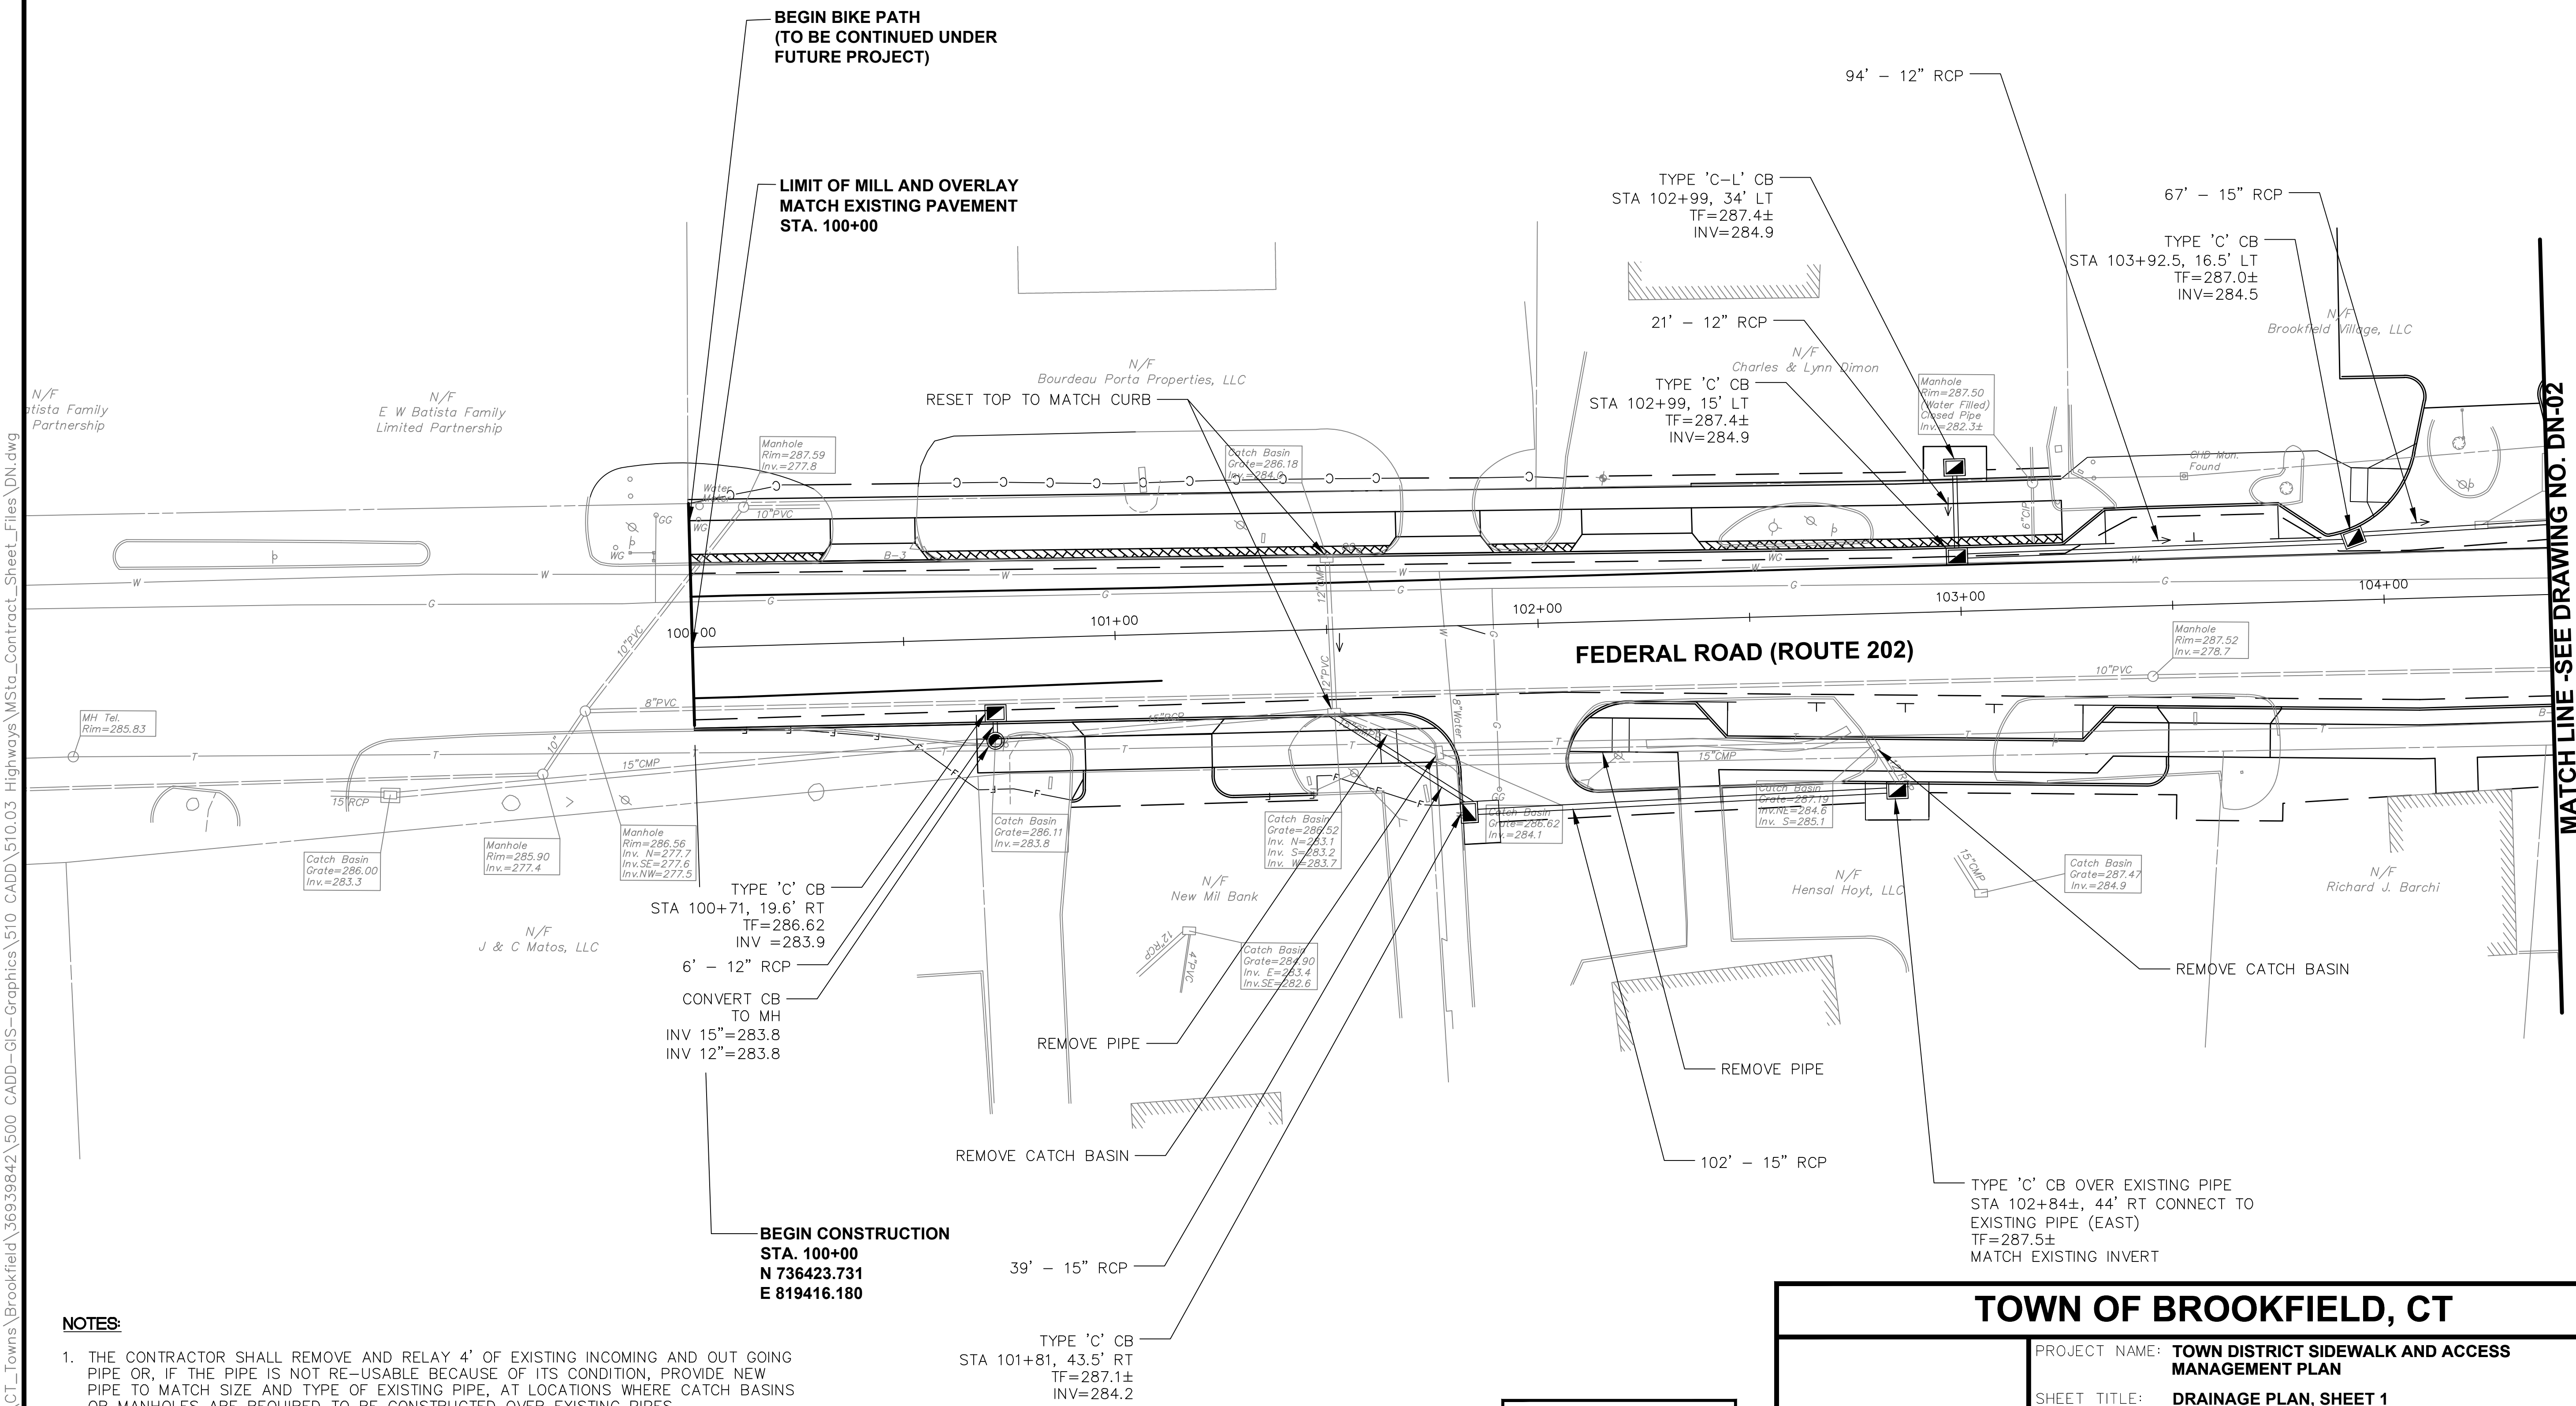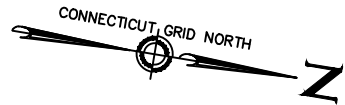1. THE CONTRACTOR SHALL REMOVE AND RELAY 4' OF EXISTING INCOMING AND OUT GOING PIPE OR, IF THE PIPE IS NOT RE-USABLE BECAUSE OF ITS CONDITION, PROVIDE NEW PIPE TO MATCH SIZE AND TYPE OF EXISTING PIPE, AT LOCATIONS WHERE CATCH BASINS OR MANHOLES ARE REQUIRED TO BE CONSTRUCTED OVER EXISTING PIPES.



TOWN OF BROOKFIELD, CT

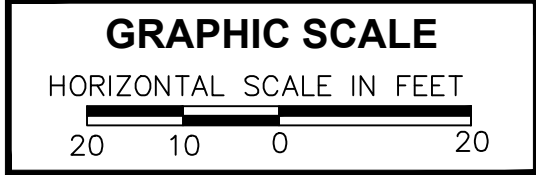URS CORPORATION 500 ENTERPRISE DRIVE, SUITE 3B ROCKY HILL, CT 06067 (860) 529-8882	PROJECT NAME: TOWN DISTRICT SIDEWALK AND ACCESS MANAGEMENT PLAN		
	SHEET TITLE: DRAINAGE PLAN, SHEET 1		
	FILE NAME:----	PLOT DATE: 4/20/2016	DRAWING NO.: DN-01
	PROJECT LEADER: SM DESIGNED BY: AG	DRAWN BY: AG CHECKED BY: PG	SHEET NO.: 41


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MATCH LINE SEE DRAWING NO. DN-01

MATCH LINE SEE DRAWING NO. DN-03

NOTES:

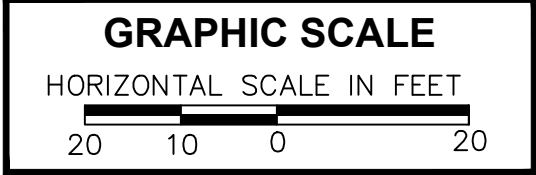- CONTRACTOR TO EXCAVATE TEST PITS TO LOCATE TELEPHONE DUCT BANK PRIOR TO STARTING INSTALLATION OF PROPOSED DRAINAGE ITEMS OR REMOVAL OF EXISTING DRAINAGE ITEMS. CONTRACTOR SHALL PROVIDE DOCUMENTATION OF SIZE, AND HORIZONTAL AND VERTICAL LOCATION OF TELEPHONE DUCT BANK TO OWNER'S REPRESENTATIVE IMMEDIATELY UPON OBTAINING THE INFORMATION.
- THE CONTRACTOR SHALL REMOVE AND RELAY 4' OF EXISTING INCOMING AND OUT GOING PIPE OR, IF THE PIPE IS NOT RE-USABLE BECAUSE OF ITS CONDITION, PROVIDE NEW PIPE TO MATCH SIZE AND TYPE OF EXISTING PIPE, AT LOCATIONS WHERE CATCH BASINS OR MANHOLES ARE REQUIRED TO BE CONSTRUCTED OVER EXISTING PIPES.



TOWN OF BROOKFIELD, CT

PROJECT NAME: TOWN DISTRICT SIDEWALK AND ACCESS MANAGEMENT PLAN

SHEET TITLE: DRAINAGE PLAN, SHEET 2

FILE NAME:----

PROJECT LEADER: SM
DESIGNED BY: AG

PLOT DATE: 4/20/2016

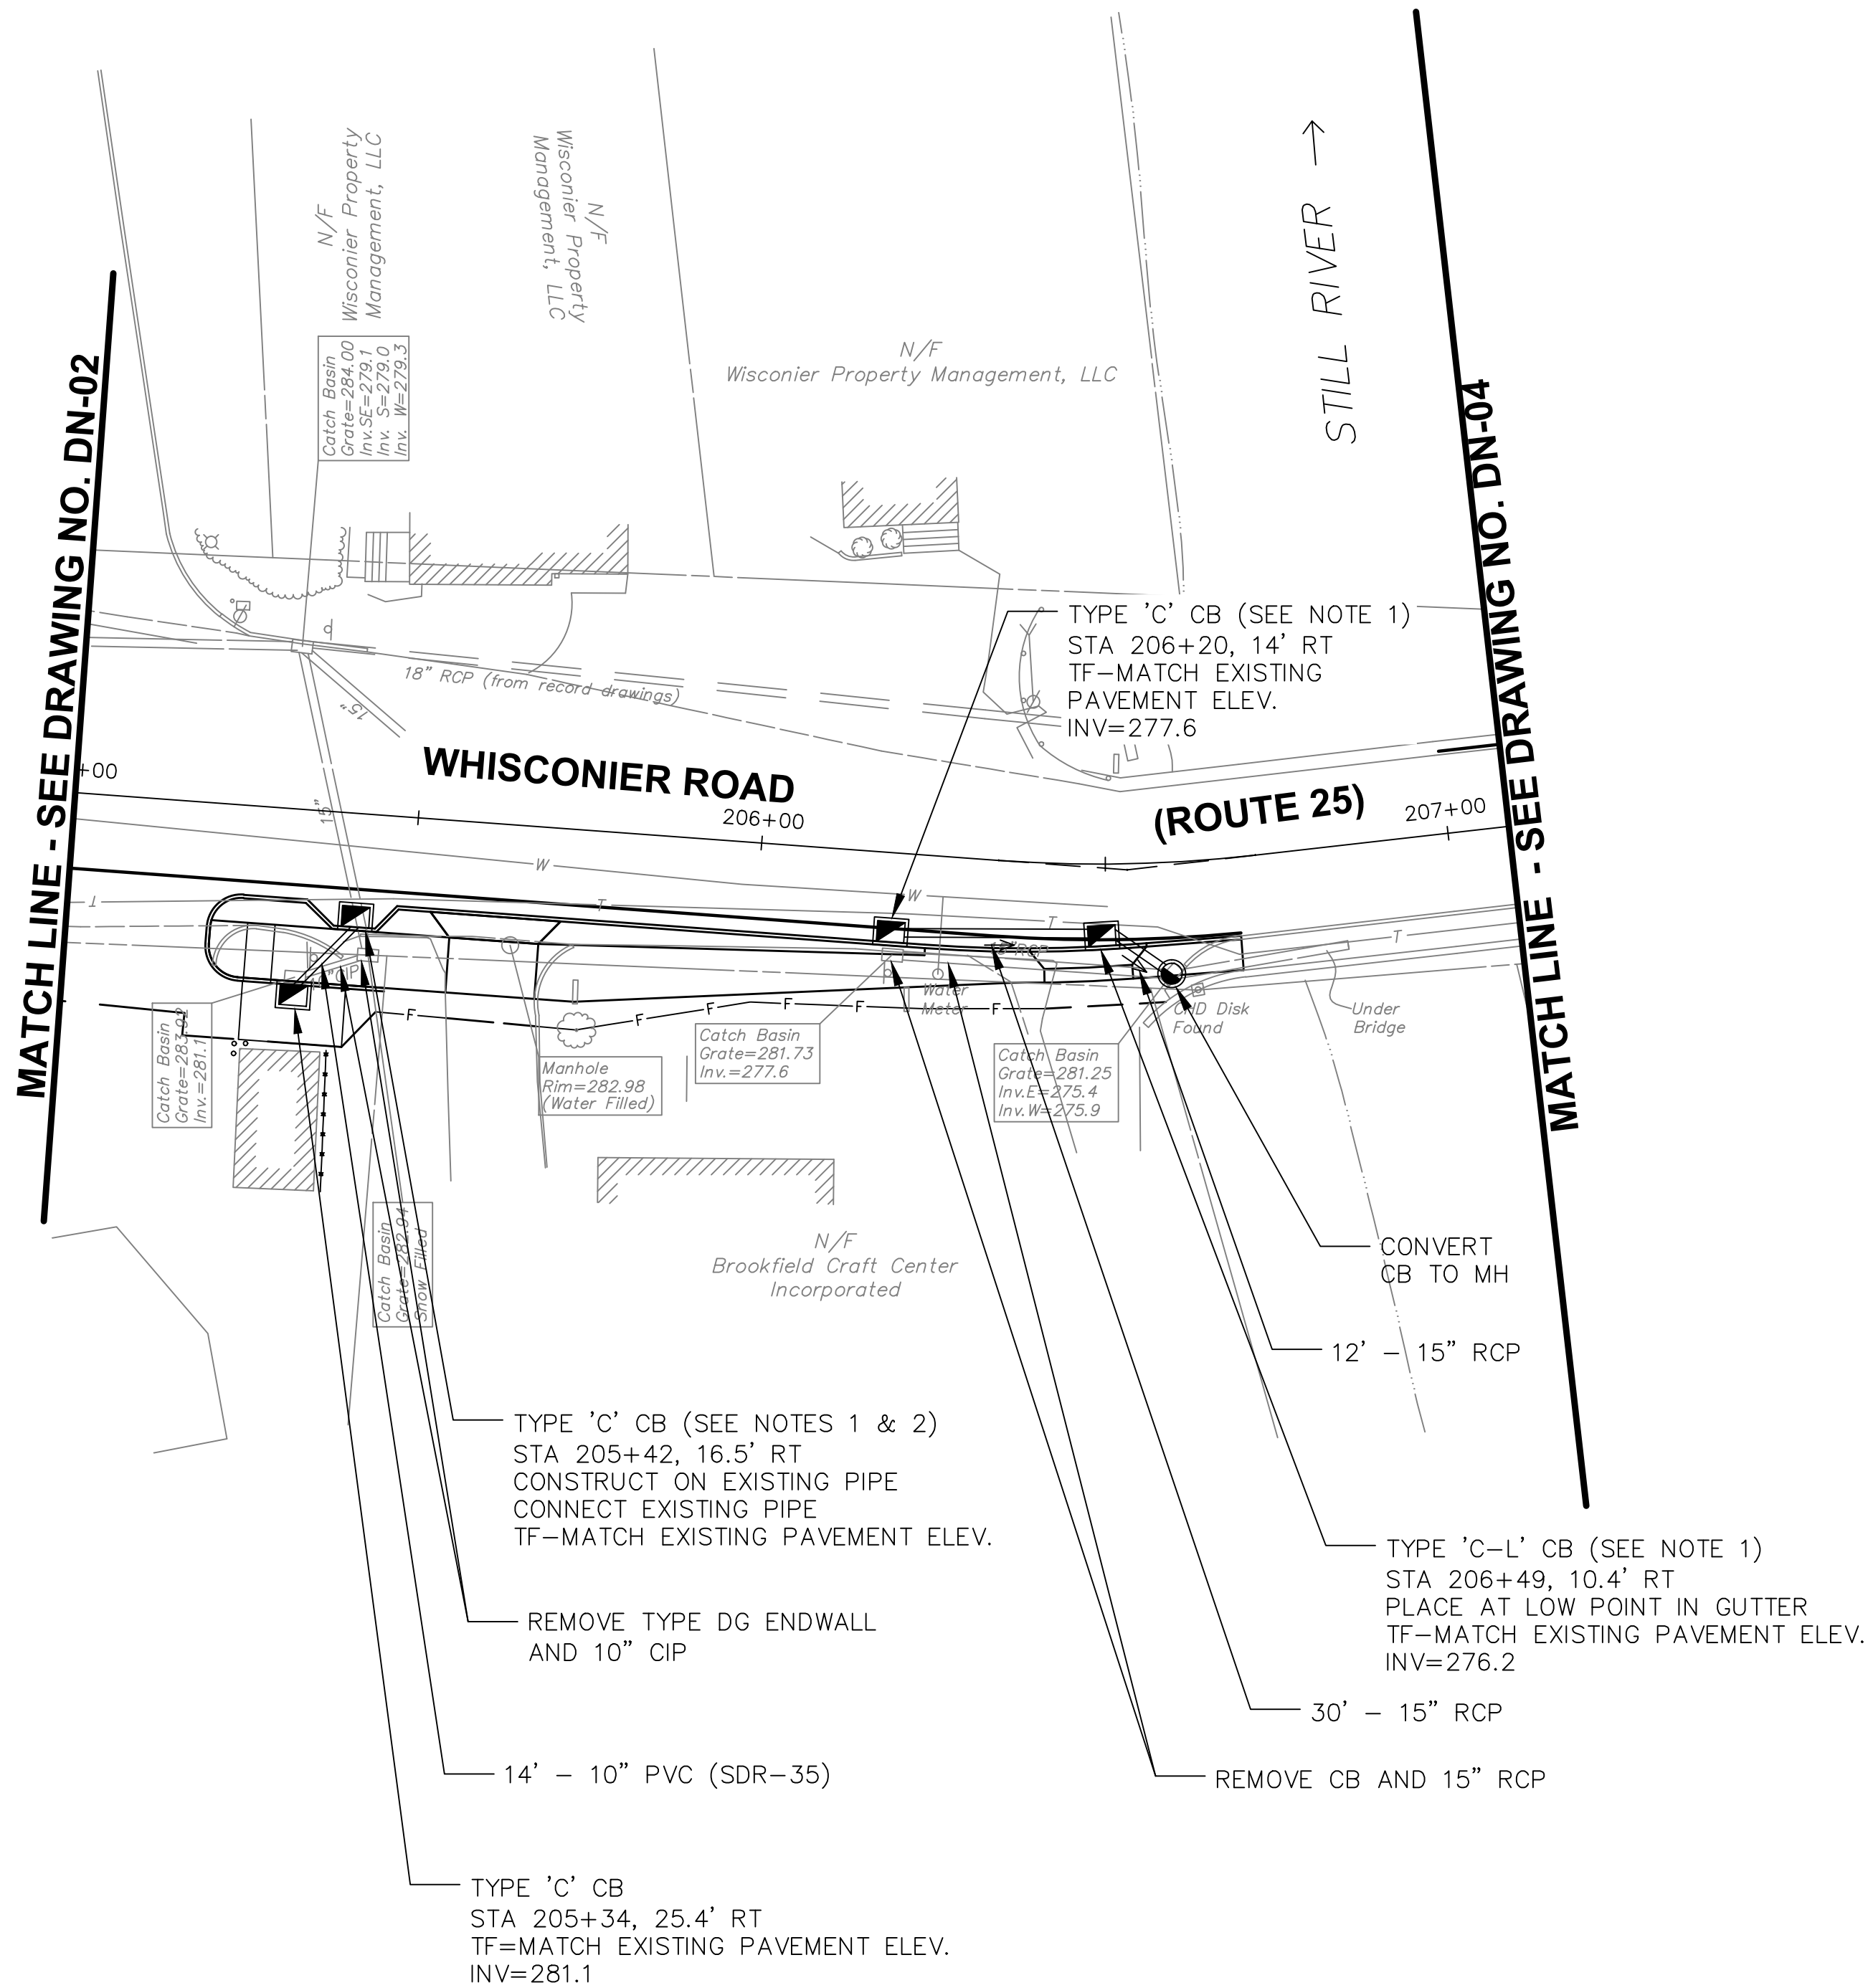
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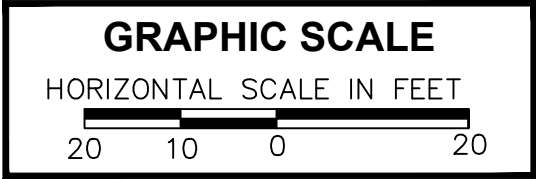
URS CORPORATION
500 ENTERPRISE DRIVE, SUITE 3B
ROCKY HILL, CT 06067
(860) 529-8882

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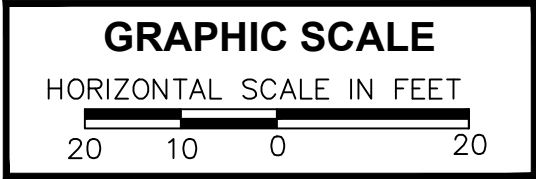
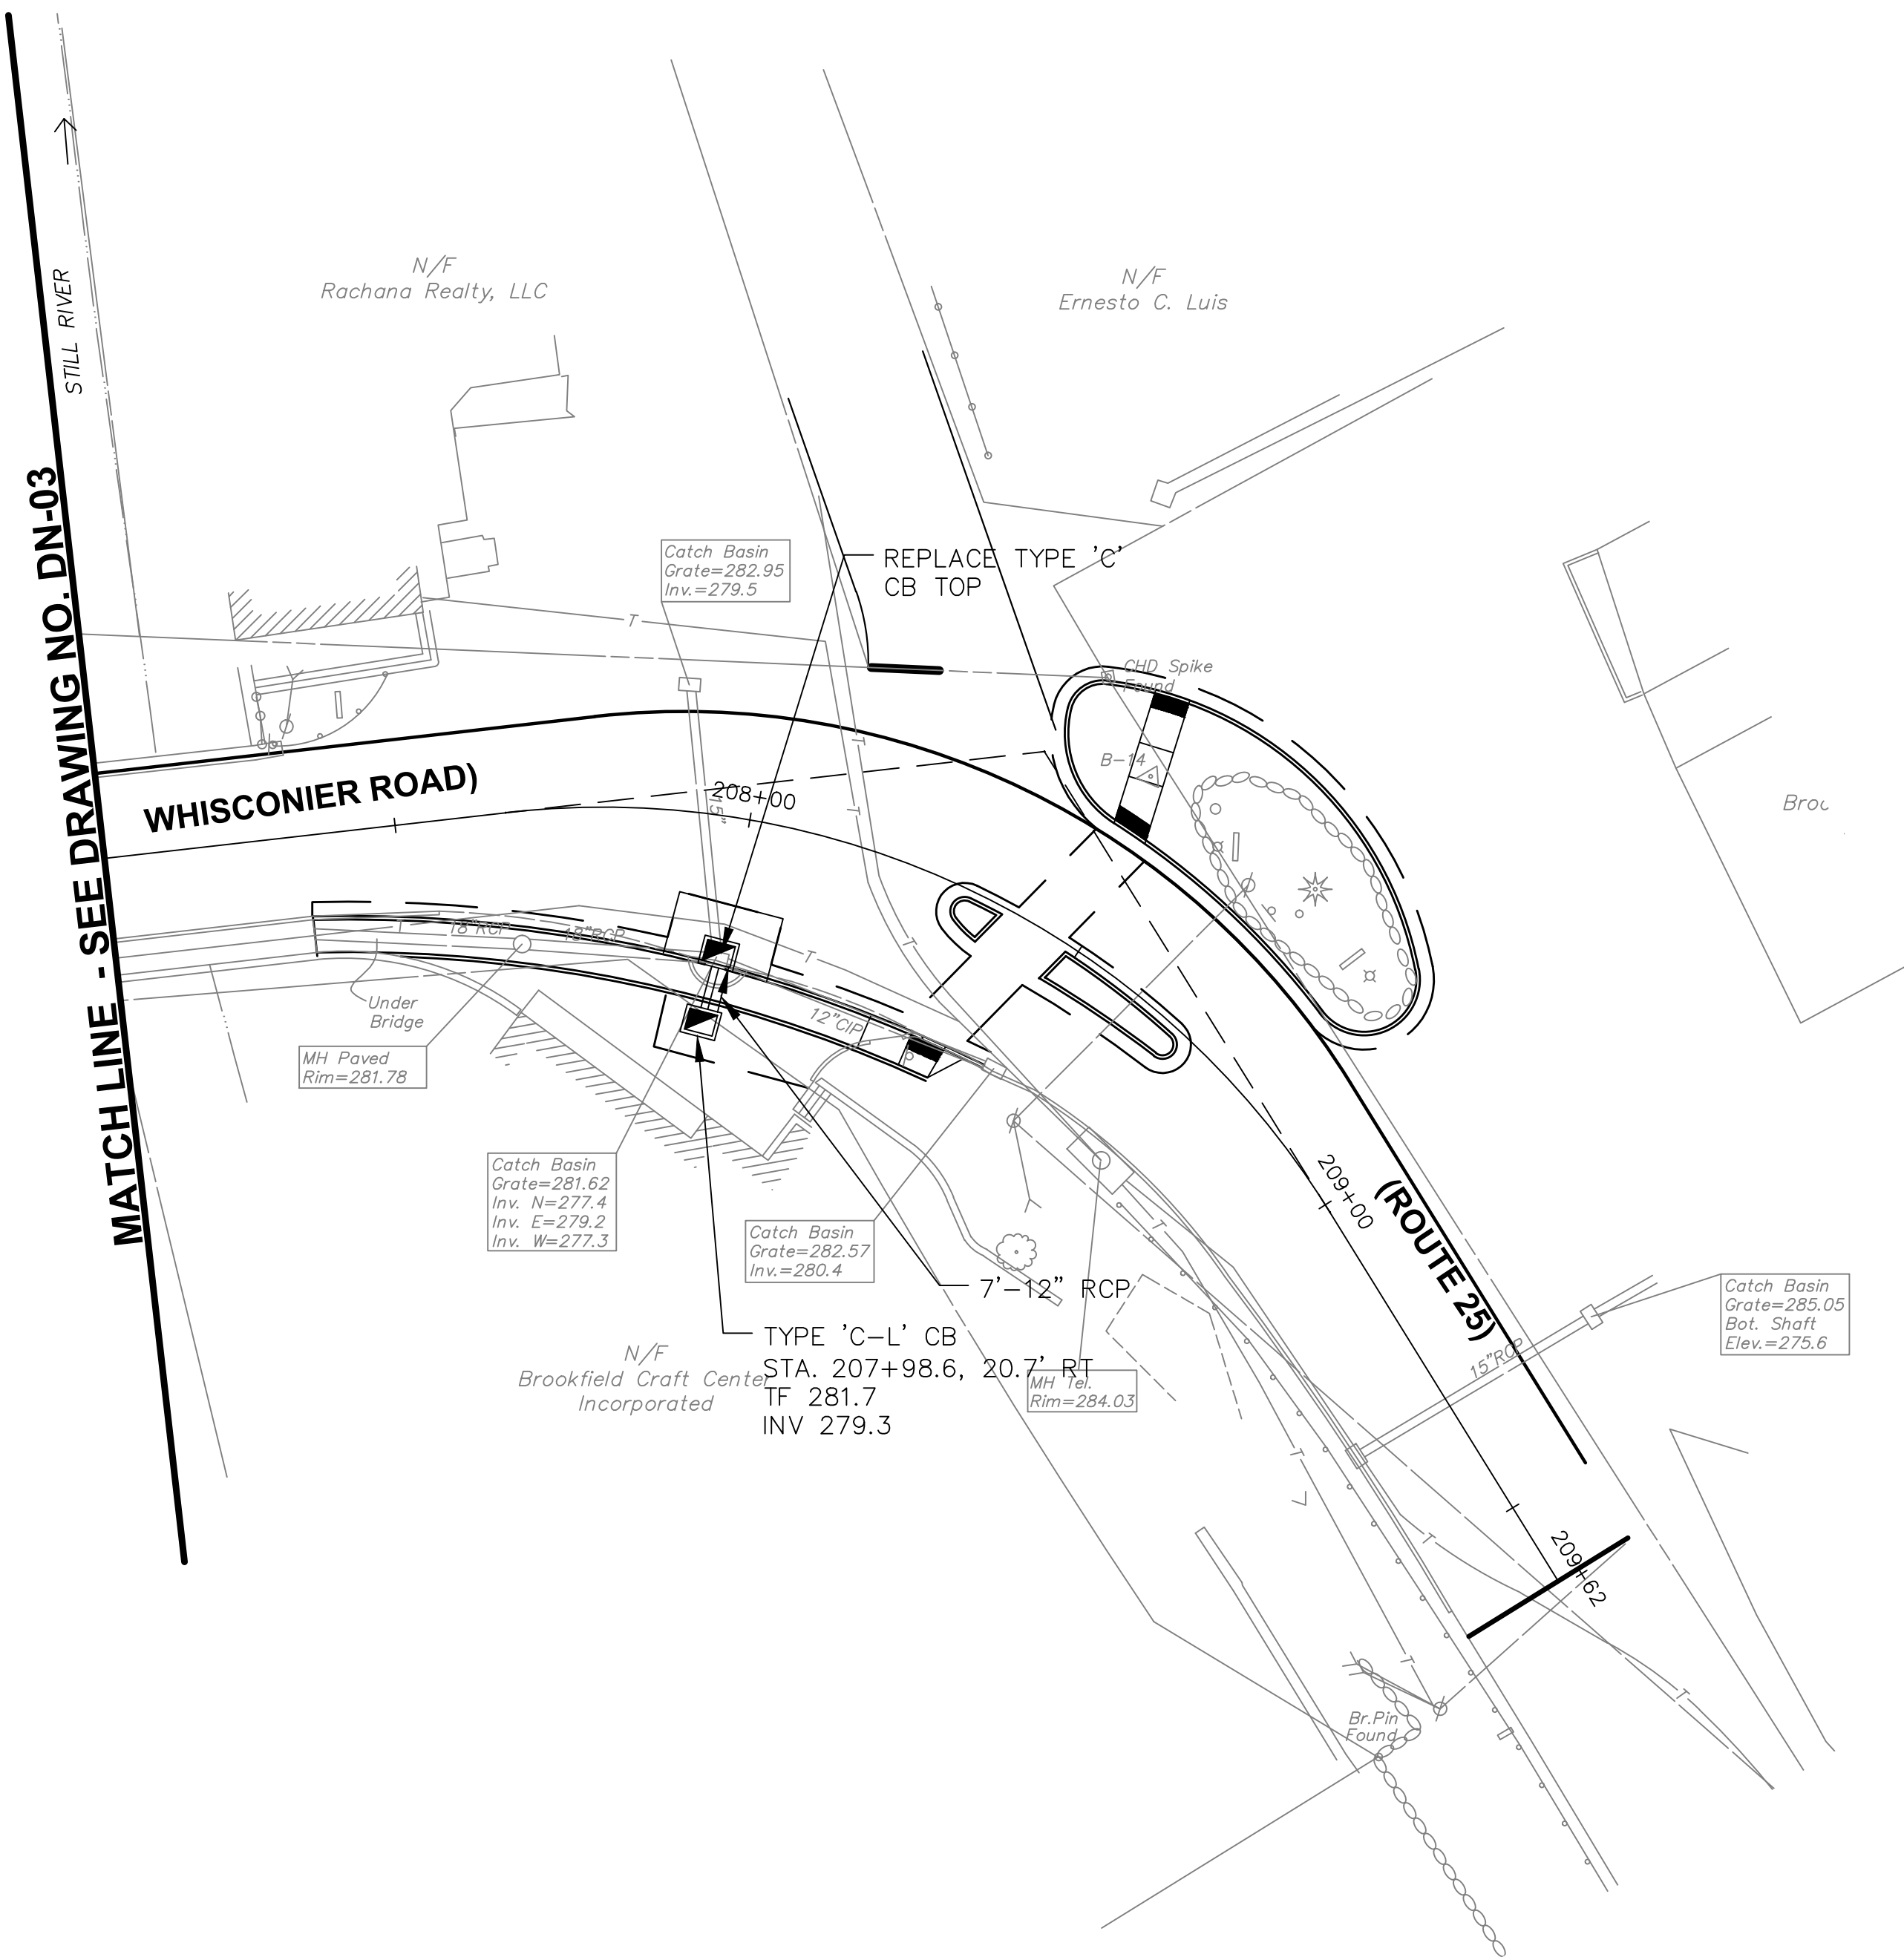
NOTES:

1. CONTRACTOR TO EXCAVATE TEST PITS TO LOCATE TELEPHONE DUCT BANK PRIOR TO STARTING INSTALLATION OF PROPOSED DRAINAGE ITEMS OR REMOVAL OF EXISTING DRAINAGE ITEMS. CONTRACTOR SHALL PROVIDE DOCUMENTATION OF SIZE, AND HORIZONTAL AND VERTICAL LOCATION OF TELEPHONE DUCT BANK TO OWNER'S REPRESENTATIVE IMMEDIATELY UPON OBTAINING THE INFORMATION.
2. THE CONTRACTOR SHALL REMOVE AND RELAY 4' OF EXISTING INCOMING AND OUT GOING PIPE OR, IF THE PIPE IS NOT RE-USABLE BECAUSE OF ITS CONDITION, PROVIDE NEW PIPE TO MATCH SIZE AND TYPE OF EXISTING PIPE, AT LOCATIONS WHERE CATCH BASINS OR MANHOLES ARE REQUIRED TO BE CONSTRUCTED OVER EXISTING PIPES.



TOWN OF BROOKFIELD, CT				
URS CORPORATION 500 ENTERPRISE DRIVE, SUITE 3B ROCKY HILL, CT 06067 (860) 529-8882	PROJECT NAME: TOWN DISTRICT SIDEWALK AND ACCESS MANAGEMENT PLAN			
	SHEET TITLE: DRAINAGE PLAN, SHEET 3			
	FILE NAME:----	PLOT DATE: 4/20/2016	DRAWING NO.: DN-03	
PROJECT LEADER: SM		DRAWN BY: AG	SHEET NO.: 43	
DESIGNED BY: AG		CHECKED BY: PG		

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TOWN OF BROOKFIELD, CT			
URS CORPORATION 500 ENTERPRISE DRIVE, SUITE 300 ROCKY HILL, CT 06067 (860) 529-8882	PROJECT NAME: TOWN DISTRICT SIDEWALK AND ACCESS MANAGEMENT PLAN		
	SHEET TITLE: DRAINAGE PLAN, SHEET 4		
	FILE NAME:----	PLOT DATE: 4/20/2016	DRAWING NO.: DN-04
	PROJECT LEADER: SM	DRAWN BY: AG	SHEET NO.: 44
	DESIGNED BY: AG	CHECKED BY: PG	

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NOTES:

1. ALL PAVEMENT MARKINGS SHALL BE OFFSET FROM THE BASE LINE UNLESS OTHERWISE NOTED.
2. ERADICATE ANY CONFLICTING PAVEMENT MARKINGS.
3. INSPECTOR SHALL REVIEW ALL PRE-MARKS PRIOR TO INSTALLATION OF MARKINGS.
4. REMOVE ALL SIGNS IN CONFLICT WITH PROPOSED SIGNAGE.
5. STOP BARS TO BE 12" WHITE LINES PLACED 4' BEHIND CROSSWALK UNLESS OTHERWISE NOTED.
6. CROSSWALK MARKINGS SHALL BE WHITE
7. AT LOCATIONS WHERE THE CROSSWALK IS SKEWED, BARS TO BE PARALLEL TO C AND ENDS OF BARS TO BE PARALLEL, THE LENGTH OF THE BARS WILL VARY DEPENDING ON THE ANGLE OF SKEW.
8. BARS SHALL NORMALLY BE NO CLOSER THAN 2' FROM CURB/EDGE OF ROAD. WHERE EXCESS SPACE MAY DEVELOP THIS DISTANCE MAY BE DECREASED TO 1'.
9. ONLY FULL LENGTH BARS ARE TO BE INSTALLED AT CORNERS.
10. ALL SIGNS ARE NEW UNLESS NOTED OTHERWISE.

PAVEMENT MARKING LEGEND

- | | |
|------|--|
| DYCL | 4" DOUBLE YELLOW CENTER LINE |
| SWLL | 4" SINGLE WHITE LANE LINE |
| SWSL | 4" SINGLE WHITE SHOULDER LINE |
| SYCL | 4" SINGLE YELLOW CENTER LINE |
| WTA | WHITE TURN ARROW |
| WBLL | 4" WHITE BROKEN LANE LINE (10' LINE, 30' SPACE) |
| WDEL | 4" WHITE DOTTED EXTENSION LINE (3' LINE, 9' SPACE) |
| SWCW | STANDARD WHITE CROSSWALK (16" WIDE BARS, 24" WIDE SPACE) |



DANBURY 10
BETHEL 13

51-5222
51-5222

31-0630 (L)

51-1354
51-1355

51-1354
51-1356

SWSL

N/F
Bourdeau Porta Properties, LLC

N/F
Charles & Lynn Dimon

N/F
Brookfield Village, LLC

WDEL

CHD-More
Found

FEDERAL ROAD (ROUTE 202)

MATCH LINE -SEE DRAWING NO. SM-02

N/F
New Mill Bank

N/F
Hensal Hoyt, LLC

N/F
Richard J. Barchi

31-0630 (D)

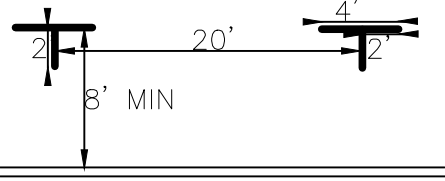


LIMIT FEDERAL ROAD
SIGNING AND PAVEMENT MARKINGS
MATCH EXISTING
STA. 100+00

51-6610
51-6616

JCT

25



ON-STREET PARKING
DETAIL

*ALL PARKING PAVEMENT MARKINGS
WILL USE 4" WIDE WHITE LINES

GRAPHIC SCALE

HORIZONTAL SCALE IN FEET
20 10 0 20

TOWN OF BROOKFIELD, CT

PROJECT NAME: TOWN DISTRICT SIDEWALK AND ACCESS
MANAGEMENT PLAN

SHEET TITLE: SIGNAGE & PAVEMENT MARKING PLAN, SHEET 1

FILE NAME:----

PROJECT LEADER: SM
DESIGNED BY: AG

PLOT DATE: 4/20/2016

DRAWN BY: AG
CHECKED BY: PG

DRAWING NO.: SM-01

SHEET NO.: 45

01/11/2017 11:17:38
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51-6613

51-6616

51-2625

51-6613

51-6611

51-6645

51-6645

51-2626

51-2626

SOUTH

25

↑

NORTH

202

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SOUTH

202

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51-6611

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NORTH

202

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51-6650

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INTERSTATE CONNECTICUT

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SOUTH

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51-6645

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NORTH

202

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SOUTH

202

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MATCH LINE - SEE DRAWING NO. SM-01

NOTES:

- ALL PAVEMENT MARKINGS SHALL BE OFFSET FROM THE BASE LINE UNLESS OTHERWISE NOTED.
- ERADICATE ANY CONFLICTING MARKINGS.
- INSPECTOR SHALL REVIEW ALL PRE-MARKS PRIOR TO INSTALLATION OF MARKINGS.
- REMOVE ALL SIGNS IN CONFLICT WITH PROPOSED SIGNAGE.
- STOP BARS TO BE 12" WHITE LINES PLACED 4' BEHIND CROSSWALK UNLESS OTHERWISE NOTED.
- CROSSWALK MARKINGS SHALL BE WHITE
- AT LOCATIONS WHERE THE CROSSWALK IS SKEWED, BARS TO BE PARALLEL TO C AND ENDS OF BARS TO BE PARALLEL, THE LENGTH OF THE BARS WILL VARY DEPENDING ON THE ANGLE OF SKEW.
- BARS SHALL NORMALLY BE NO CLOSER THAN 2' FROM CURB/EDGE OF ROAD. WHERE EXCESS SPACE MAY DEVELOP THIS DISTANCE MAY BE DECREASED TO 1'.
- ONLY FULL LENGTH BARS ARE TO BE INSTALLED AT CORNERS.
- ALL SIGNS ARE NEW UNLESS NOTED OTHERWISE.
- ALL CROSSWALK STRIPING SHALL BE 8' AND CENTERED ON SIDEWALK RAMPS.

PAVEMENT MARKING LEGEND

DYCL	4" DOUBLE YELLOW CENTER LINE
SWLL	4" SINGLE WHITE LANE LINE
SWSL	4" SINGLE WHITE SHOULDER LINE
SYCL	4" SINGLE YELLOW CENTER LINE
WBLL	4" WHITE BROKEN LANE LINE (10' LINE, 30' SPACE)
WDEL	4" WHITE DOTTED EXTENSION LINE (3 'LINE, 9' SPACE)
SWCW	STANDARD WHITE CROSSWALK (16' WIDE BARS, 24" WIDE SPACE)

ON-STREET PARKING
DETAIL

*ALL PARKING PAVEMENT
MARKINGS WILL USE 4" WIDE
WHITE LINES

GRAPHIC SCALE

HORIZONTAL SCALE IN FEET
20 10 0 20

TOWN OF BROOKFIELD, CT

PROJECT NAME: **TOWN DISTRICT SIDEWALK AND ACCESS
MANAGEMENT PLAN**

SHEET TITLE: **SIGNAGE AND PAVEMENT PLAN, SHEET 2**

FILE NAME:----

PROJECT LEADER: SM

DESIGNED BY: AG

PLOT DATE: 4/20/2016

DRAWN BY: AG

CHECKED BY: PG

DRAWING NO.:

SM-02

SHEET NO.:

46

URS CORPORATION
500 ENTERPRISE DRIVE, SUITE 3B
ROCKY HILL, CT 06067
(860) 529-8882

MATCH LINE - SEE DRAWING NO. SM-04

MATCH LINE SEE DRAWING NO. SM-03

MATCH LINE SEE DRAWING NO. SM-05

PARKING STALL
MARKING
(SEE DETAIL,
DWG SM-01)

PARKING STALL
MARKING
(SEE DETAIL,
DWG SM-01)

Exist. Sidewalk

SWSL

N/F
PDM Realty, LLC

51-6613
51-6645

SOUTH
202

31-5505
SPEED
LIMIT
30

SWSL

N/F
Ralph J. Gulliver, Jr.
et al.

31-0302Z
ONLY

WDEL

31-0302Z
ONLY

STATION ROAD

+87

202+00

+44

203+00

+73

203+00

+23

204+00

+58

204+00

+82

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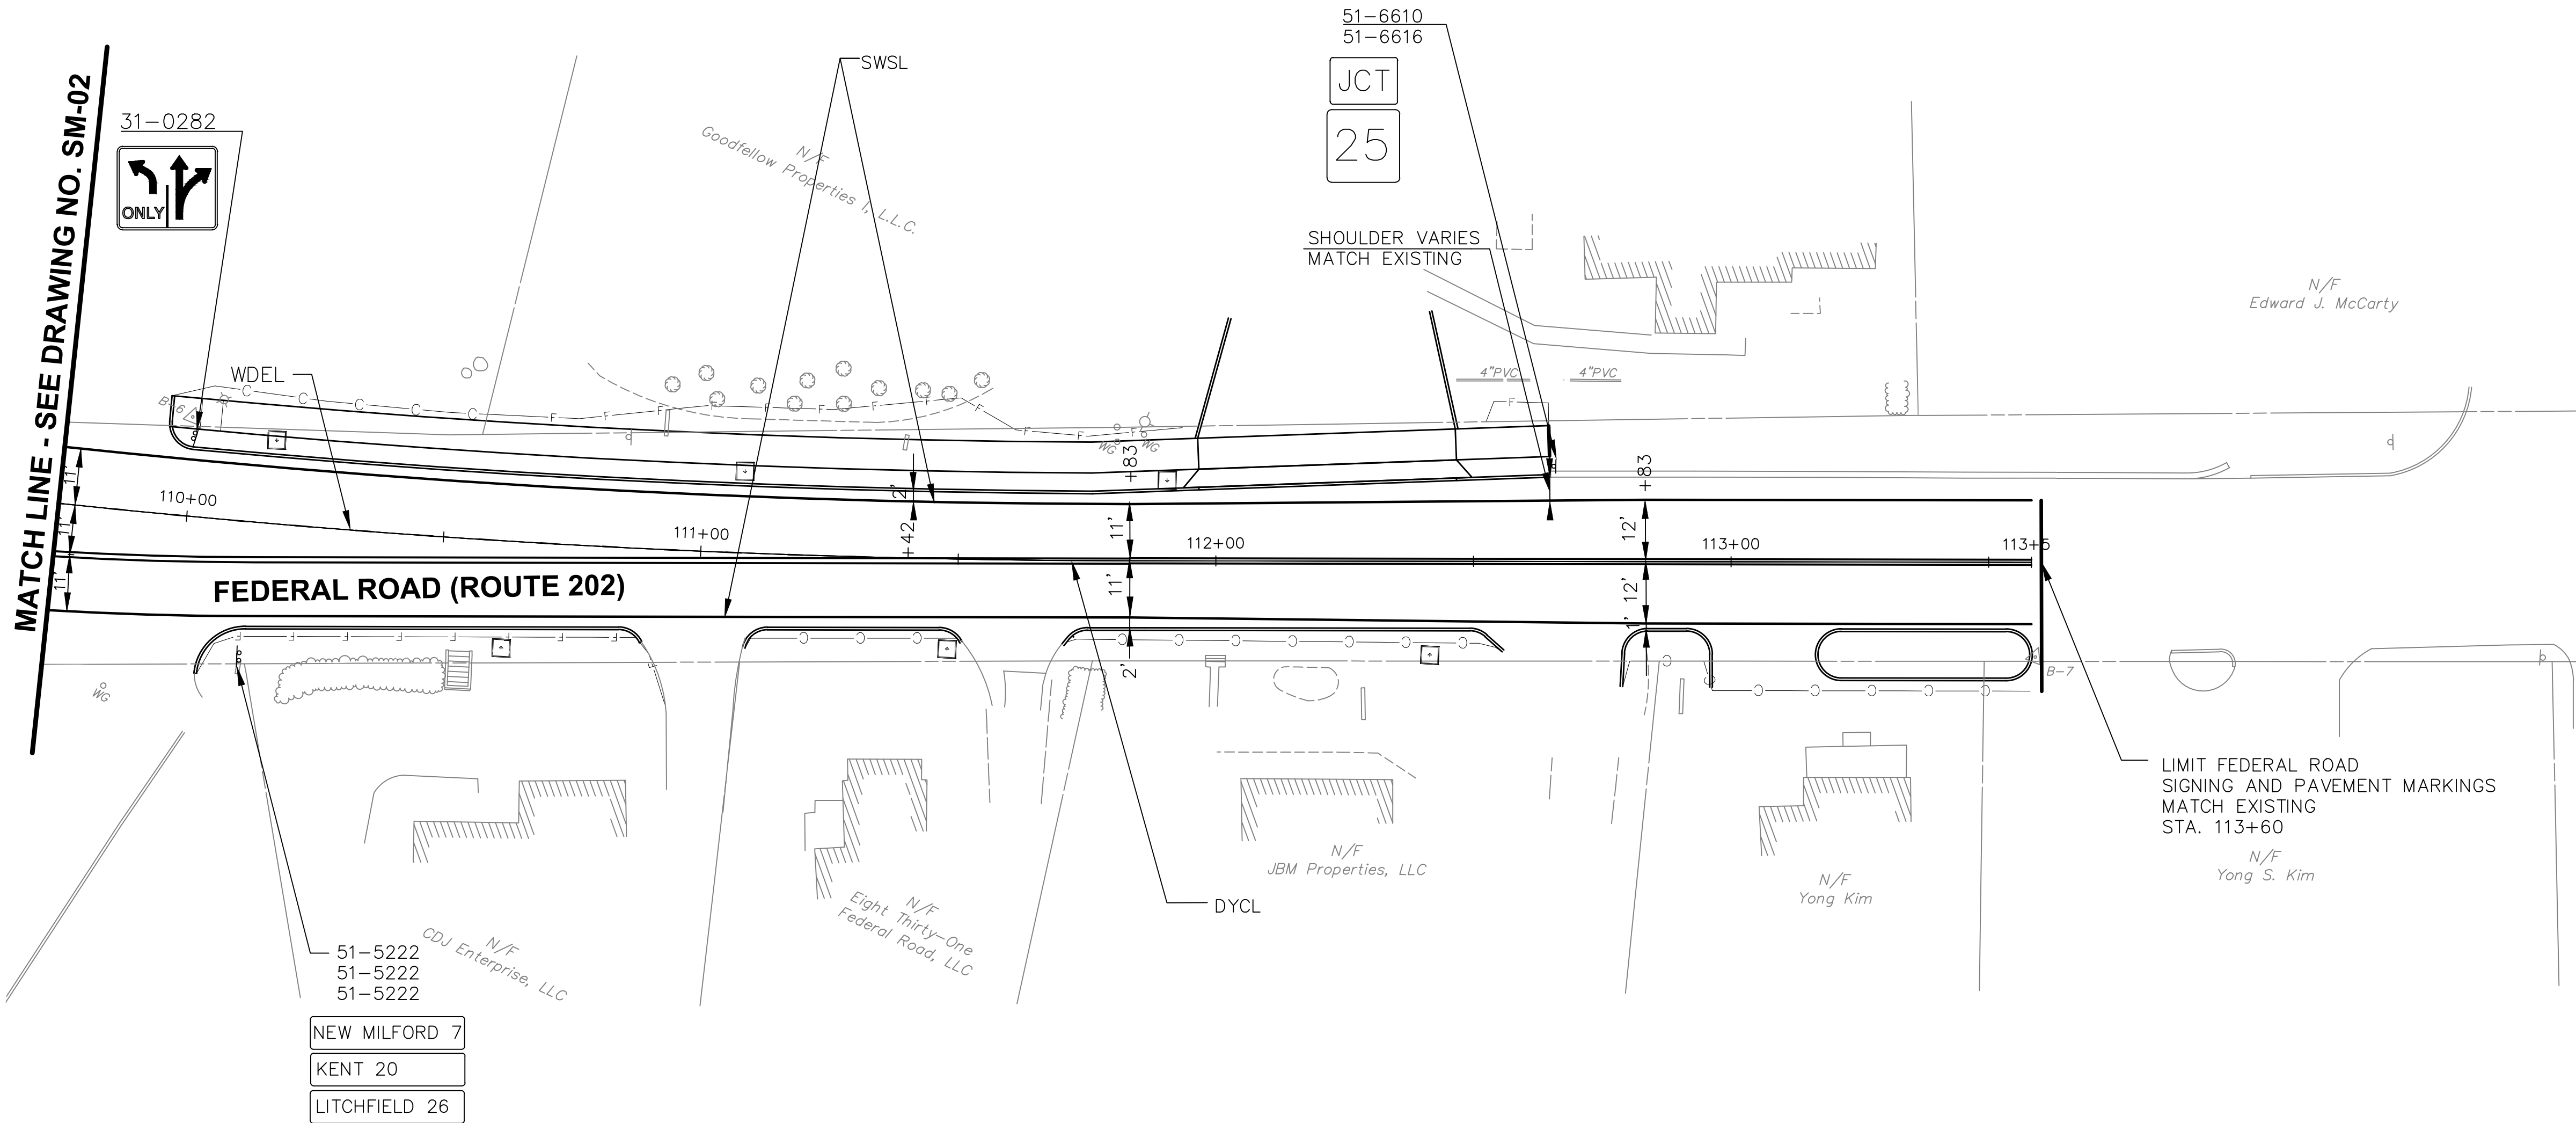
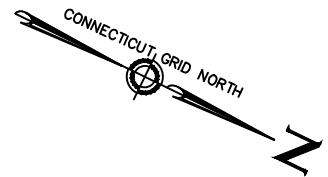
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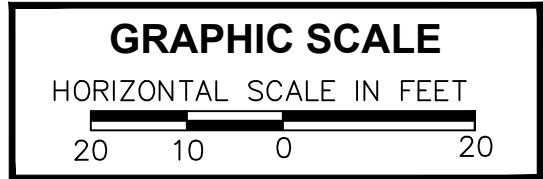


PAVEMENT MARKING LEGEND

DYCL	4" DOUBLE YELLOW CENTER LINE
SWLL	4" SINGLE WHITE LANE LINE
SWSL	4" SINGLE WHITE SHOULDER LINE
SYCL	4" SINGLE YELLOW CENTER LINE
WBLL	4" WHITE BROKEN LANE LINE (10' LINE, 30' SPACE)
WDEL	4" WHITE DOTTED EXTENSION LINE (3 'LINE, 9' SPACE)
SWCW	STANDARD WHITE CROSSWALK (16' WIDE BARS, 24" WIDE SPACE)

NOTES:

- ALL PAVEMENT MARKINGS SHALL BE OFFSET FROM THE BASE LINE UNLESS OTHERWISE NOTED.
- ERADICATE ANY CONFLICTING MARKINGS.
- INSPECTOR SHALL REVIEW ALL PRE-MARKS PRIOR TO INSTALLATION OF MARKINGS.
- REMOVE ALL SIGNS IN CONFLICT WITH PROPOSED SIGNAGE.
- STOP BARS TO BE 12" WHITE LINES PLACED 4' BEHIND CROSSWALK UNLESS OTHERWISE NOTED.
- CROSSWALK MARKINGS SHALL BE WHITE
- AT LOCATIONS WHERE THE CROSSWALK IS SKEWED, BARS TO BE PARALLEL TO C AND ENDS OF BARS TO BE PARALLEL, THE LENGTH OF THE BARS WILL VARY DEPENDING ON THE ANGLE OF SKEW.
- BARS SHALL NORMALLY BE NO CLOSER THAN 2' FROM CURB/EDGE OF ROAD. WHERE EXCESS SPACE MAY DEVELOP THIS DISTANCE MAY BE DECREASED TO 1'.
- ONLY FULL LENGTH BARS ARE TO BE INSTALLED AT CORNERS.
- ALL SIGNS ARE NEW UNLESS NOTED OTHERWISE.



TOWN OF BROOKFIELD, CT

PROJECT NAME: **TOWN DISTRICT SIDEWALK AND ACCESS MANAGEMENT PLAN**

SHEET TITLE **SIGNAGE & PAVEMENT MARKING PLAN, SHEET 3**

FILE NAME:----

PLOT DATE: 4/20/2016


PROJECT LEADER: SM
DESIGNED BY: AG

DRAWN BY: AG
CHECKED BY: PG

DRAWING NO.: **SM-03**


SHEET NO.: **47**

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PAVEMENT MARKING LEGEND	
DYCL	4" DOUBLE YELLOW CENTER LINE
SWLL	4" SINGLE WHITE LANE LINE
SWSL	4" SINGLE WHITE SHOULDER LINE
SYCL	4" SINGLE YELLOW CENTER LINE
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WDEL	4" WHITE DOTTED EXTENSION LINE (3' LINE, 9' SPACE)
SWCW	STANDARD WHITE CROSSWALK (16" WIDE BARS, 24" WIDE SPACE)

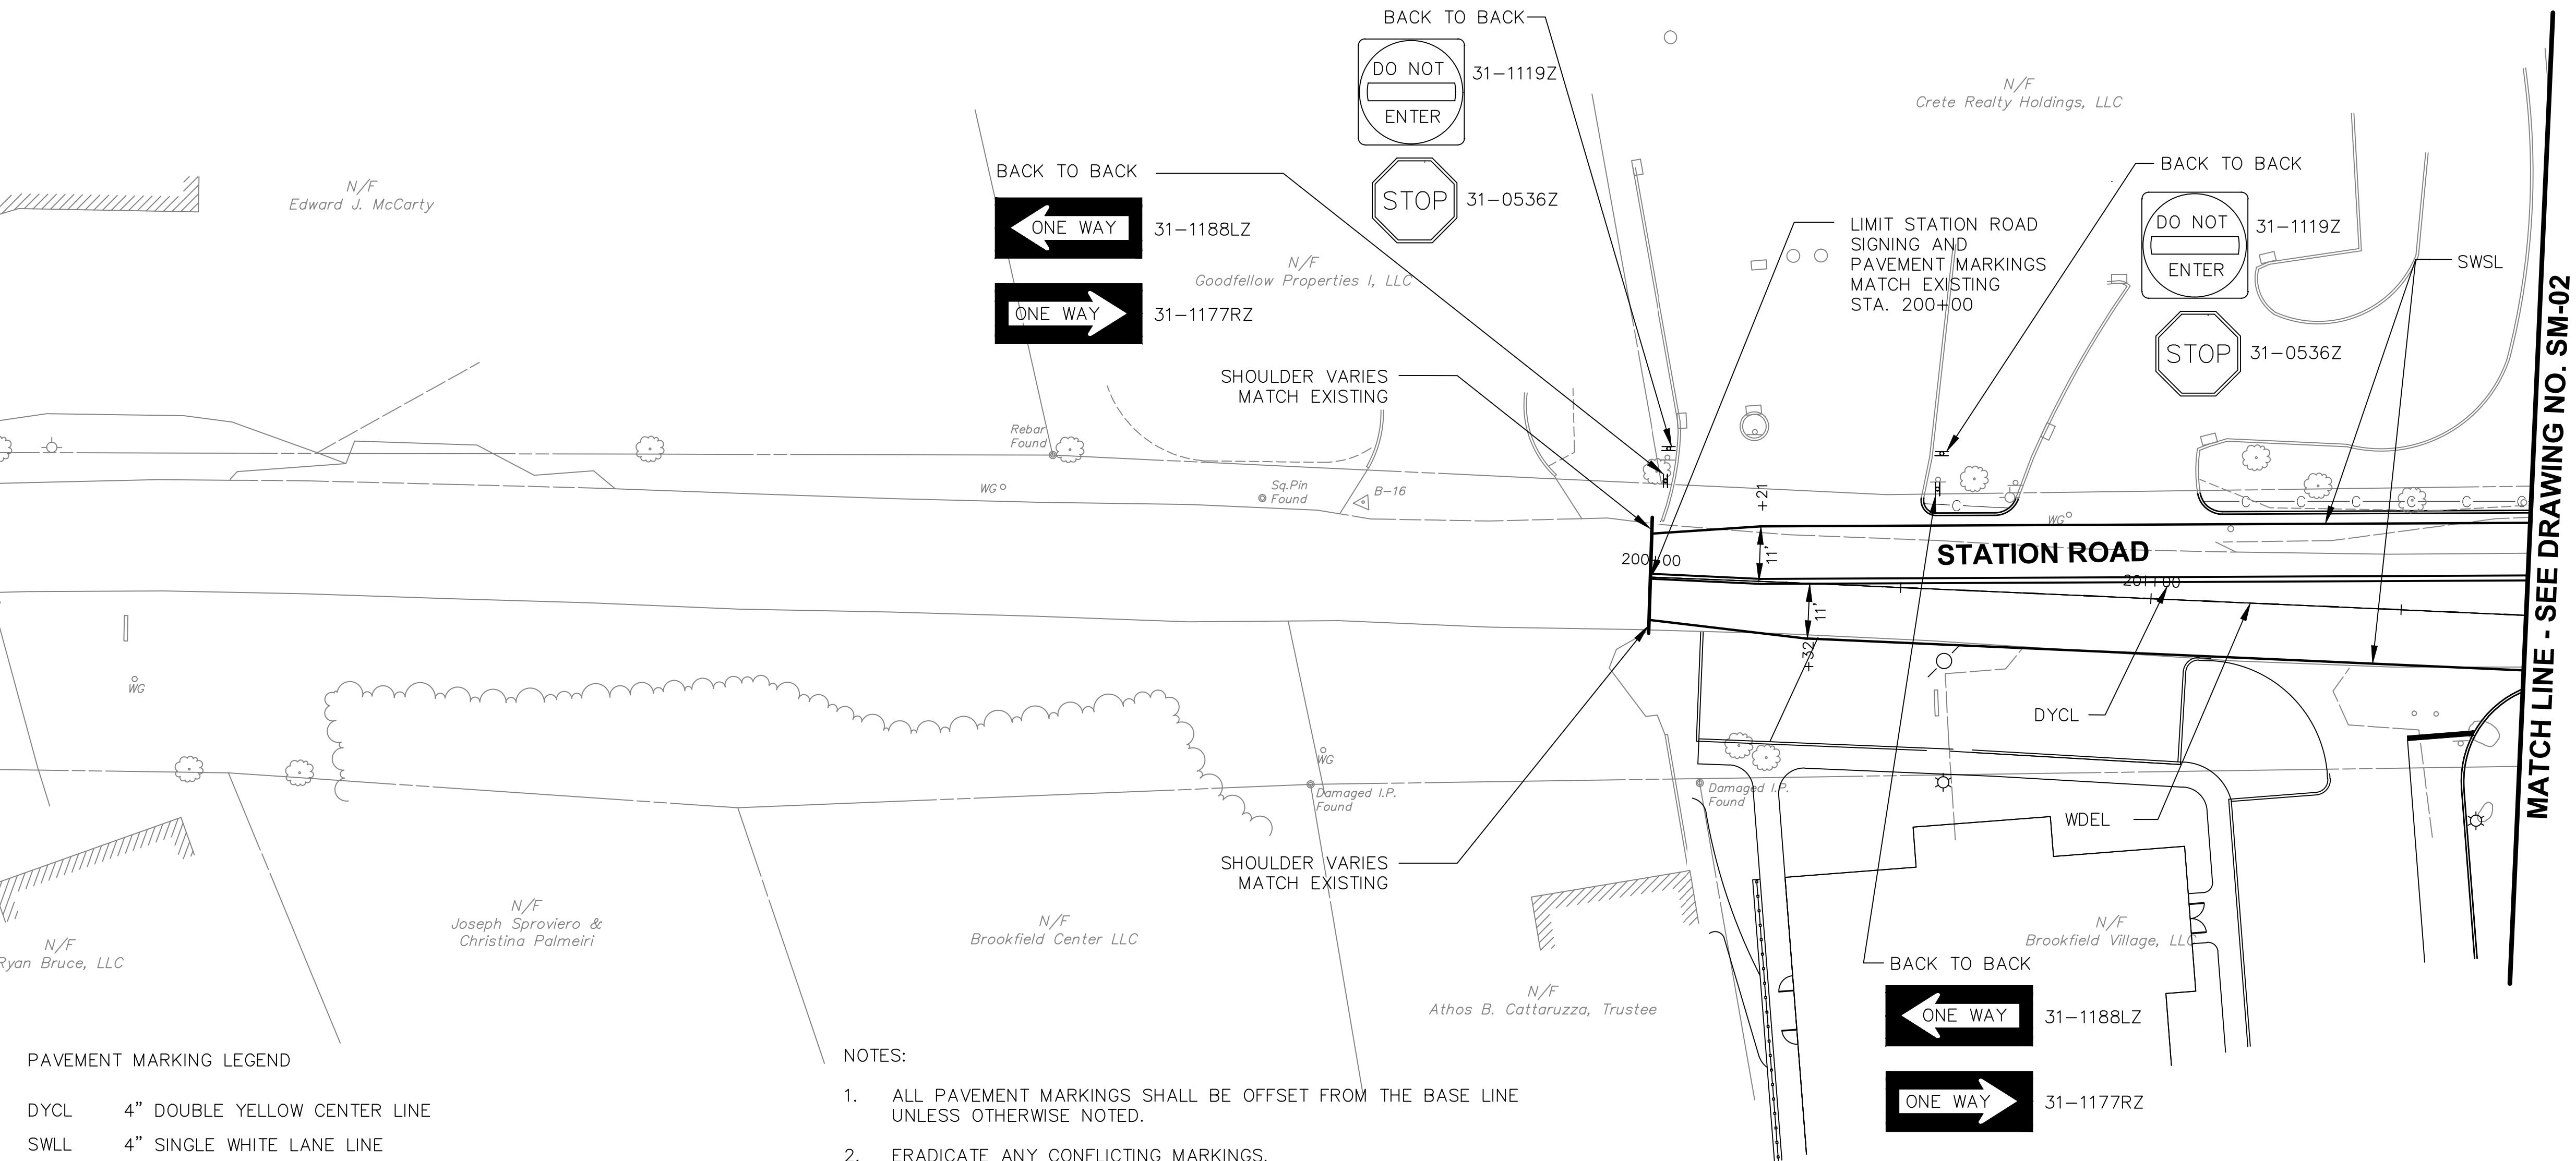- NOTES:
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 - ERADICATE ANY CONFLICTING MARKINGS.
 - INSPECTOR SHALL REVIEW ALL PRE-MARKS PRIOR TO INSTALLATION OF MARKINGS.
 - REMOVE ALL SIGNS IN CONFLICT WITH PROPOSED SIGNAGE.
 - STOP BARS TO BE 12" WHITE LINES PLACED 4' BEHIND CROSSWALK UNLESS OTHERWISE NOTED.
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 - ALL SIGNS ARE NEW UNLESS NOTED OTHERWISE.




TOWN OF BROOKFIELD, CT			
URS CORPORATION 500 ENTERPRISE DRIVE, SUITE 3B ROCKY HILL, CT 06067 (860) 529-8882	PROJECT NAME: TOWN DISTRICT SIDEWALK AND ACCESS MANAGEMENT PLAN		
	SHEET TITLE: SIGNAGE & PAVEMENT MARKING PLAN, SHEET 4		
	FILE NAME:----	PLOT DATE: 4/20/2016	DRAWING NO.: SM-04
PROJECT LEADER: SM		DRAWN BY: AG	SHEET NO.: 48
DESIGNED BY: AG		CHECKED BY: PG	
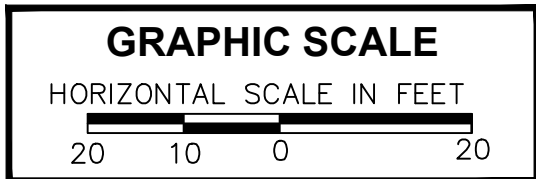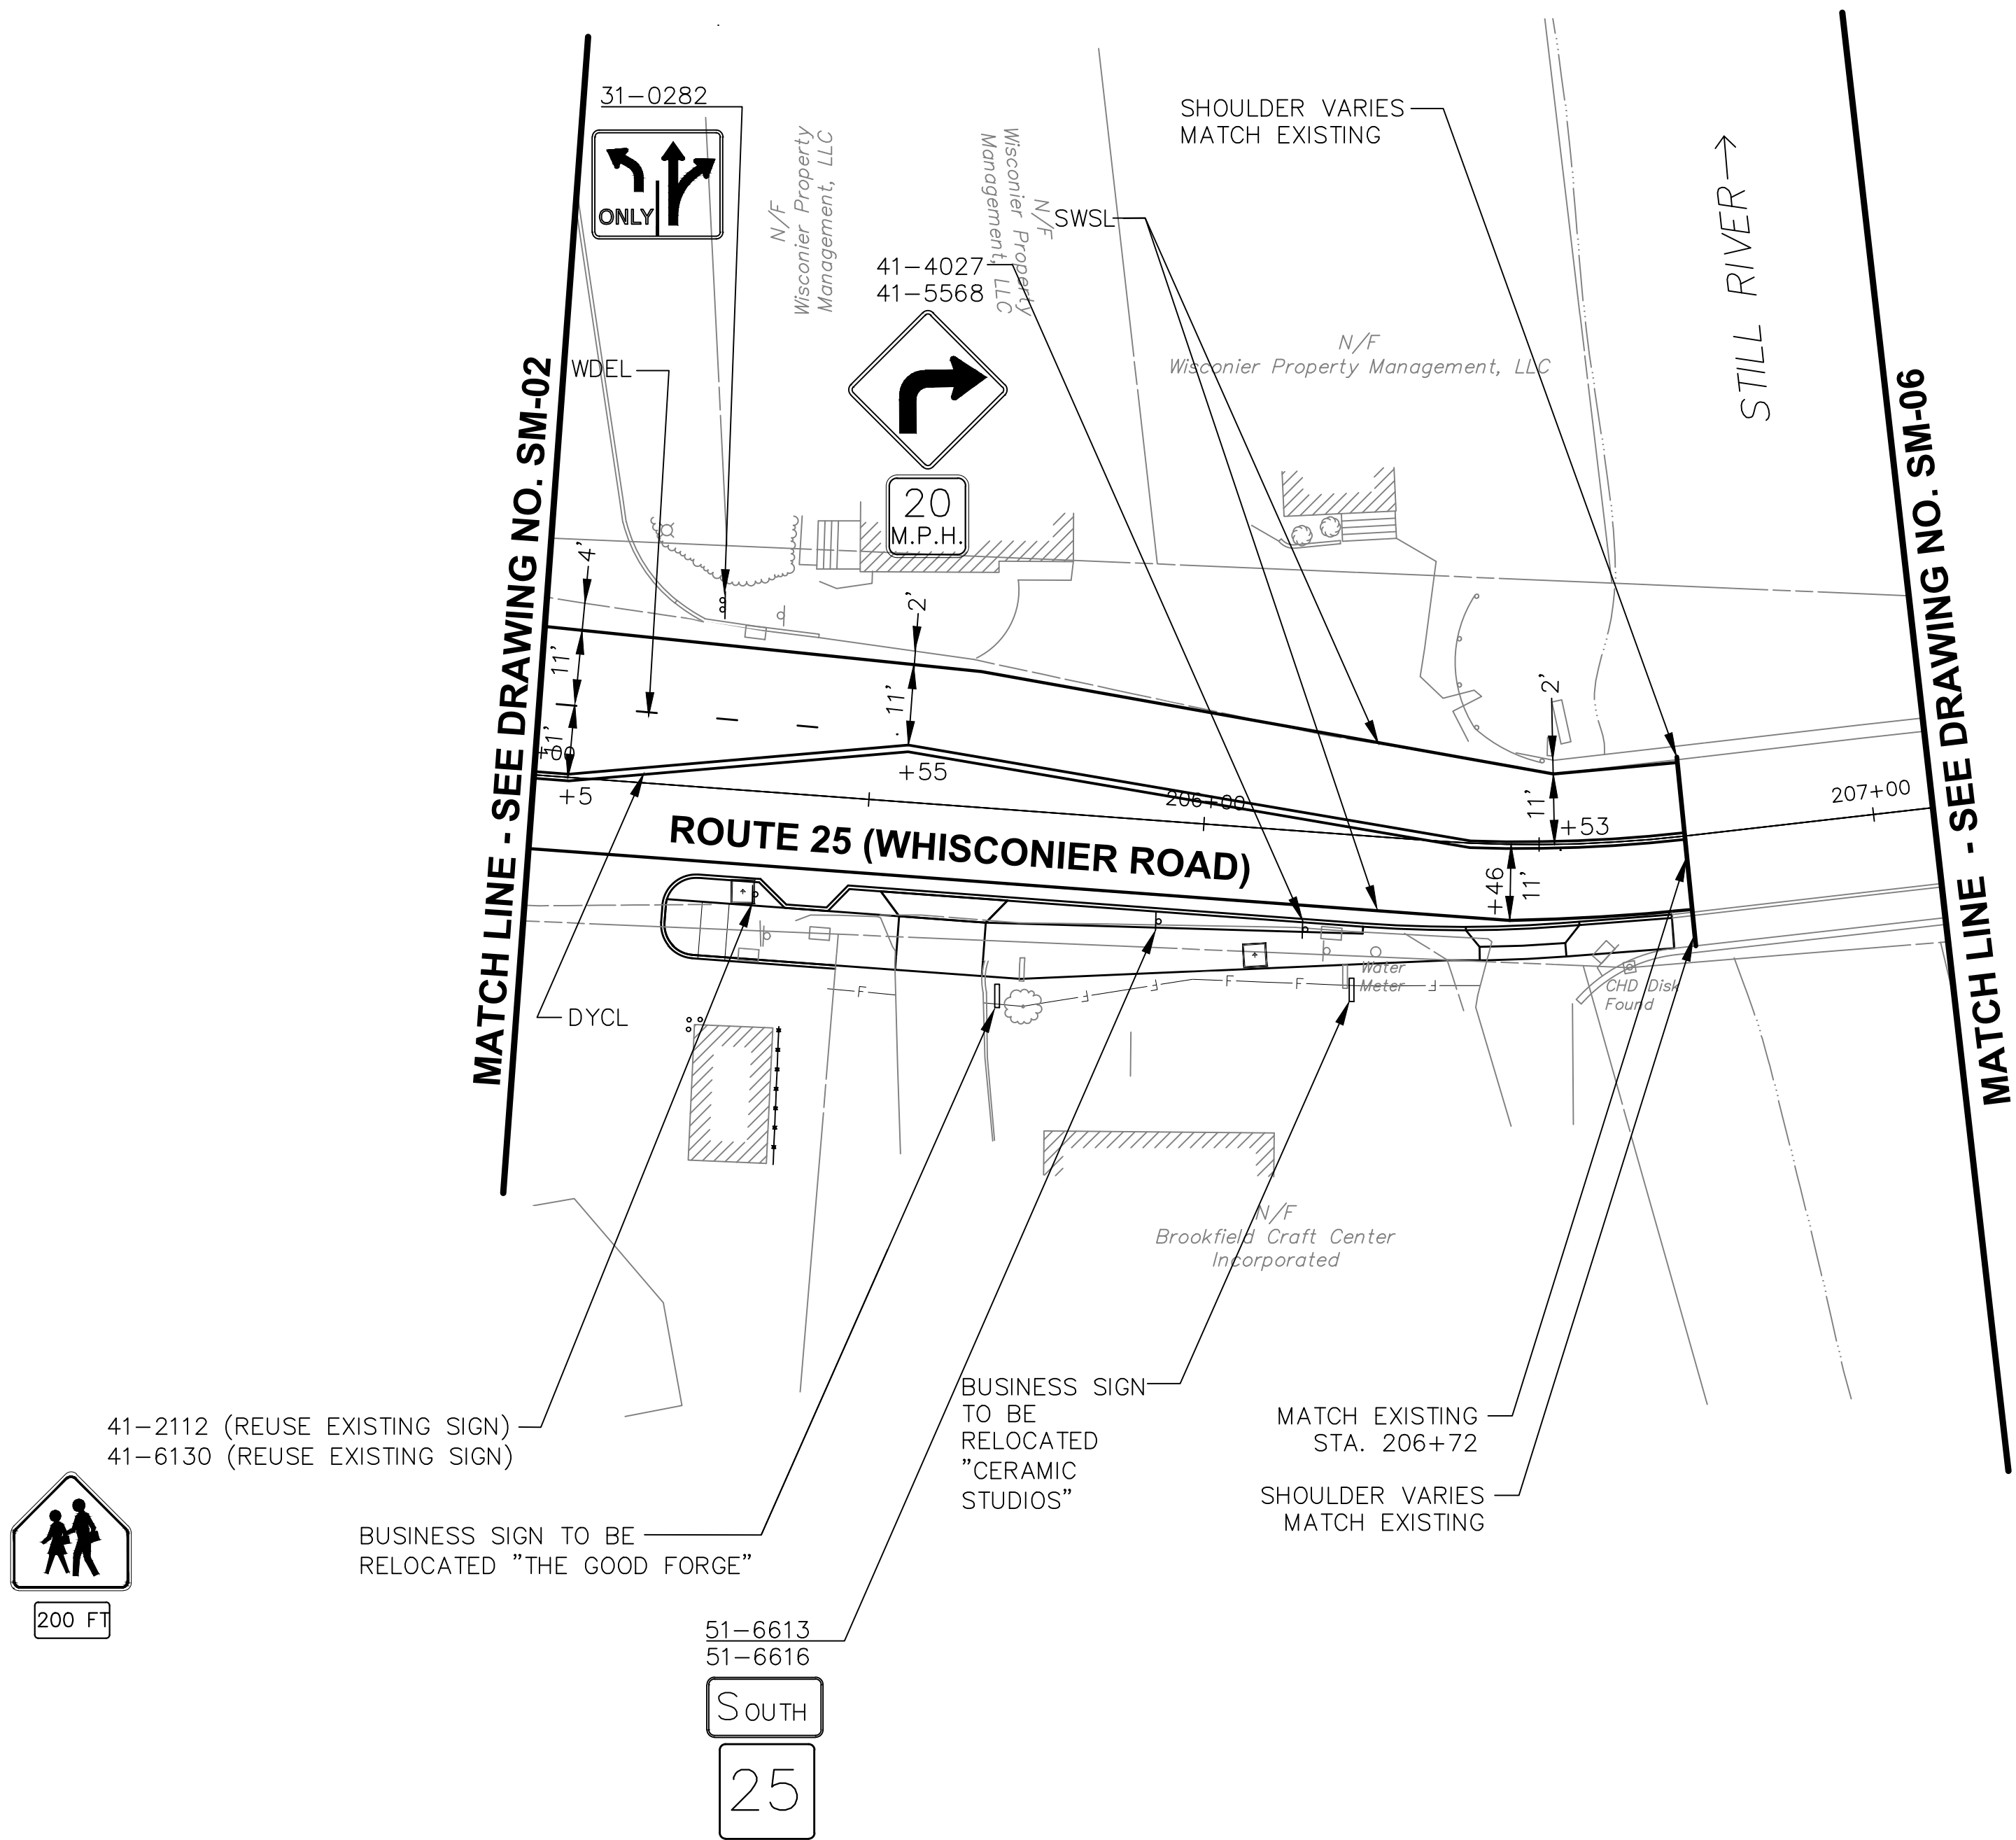
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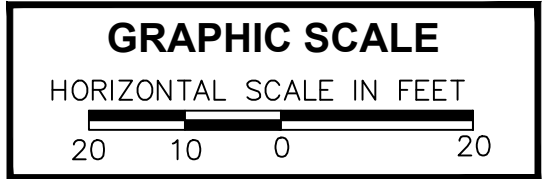
PAVEMENT MARKING LEGEND

DYCL	4" DOUBLE YELLOW CENTER LINE
SWLL	4" SINGLE WHITE LANE LINE
SWSL	4" SINGLE WHITE SHOULDER LINE
SYCL	4" SINGLE YELLOW CENTER LINE
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WDEL	4" WHITE DOTTED EXTENSION LINE (3 'LINE, 9' SPACE)
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NOTES:

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- CROSSWALK MARKINGS SHALL BE WHITE
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- ONLY FULL LENGTH BARS ARE TO BE INSTALLED AT CORNERS.
- ALL SIGNS ARE NEW UNLESS NOTED OTHERWISE.



TOWN OF BROOKFIELD, CT


URS CORPORATION 500 ENTERPRISE DRIVE, SUITE 3B ROCKY HILL, CT 06067 (860) 529-8882	PROJECT NAME: TOWN DISTRICT SIDEWALK AND ACCESS MANAGEMENT PLAN		
	SHEET TITLE: SIGNAGE & PAVEMENT MARKING PLAN, SHEET 5		
	FILE NAME:----	PLOT DATE: 4/20/2016	DRAWING NO.: SM-05
	PROJECT LEADER: SM DESIGNED BY: AG	DRAWN BY: AG CHECKED BY: PG	SHEET NO.: 49



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PAVEMENT MARKING LEGEND

DYCL	4" DOUBLE YELLOW CENTER LINE
SWLL	4" SINGLE WHITE LANE LINE
SWSL	4" SINGLE WHITE SHOULDER LINE
SYCL	4" SINGLE YELLOW CENTER LINE
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WDEL	4" WHITE DOTTED EXTENSION LINE (3' LINE, 9' SPACE)
SWCW	STANDARD WHITE CROSSWALK (16" WIDE BARS, 24" WIDE SPACE)

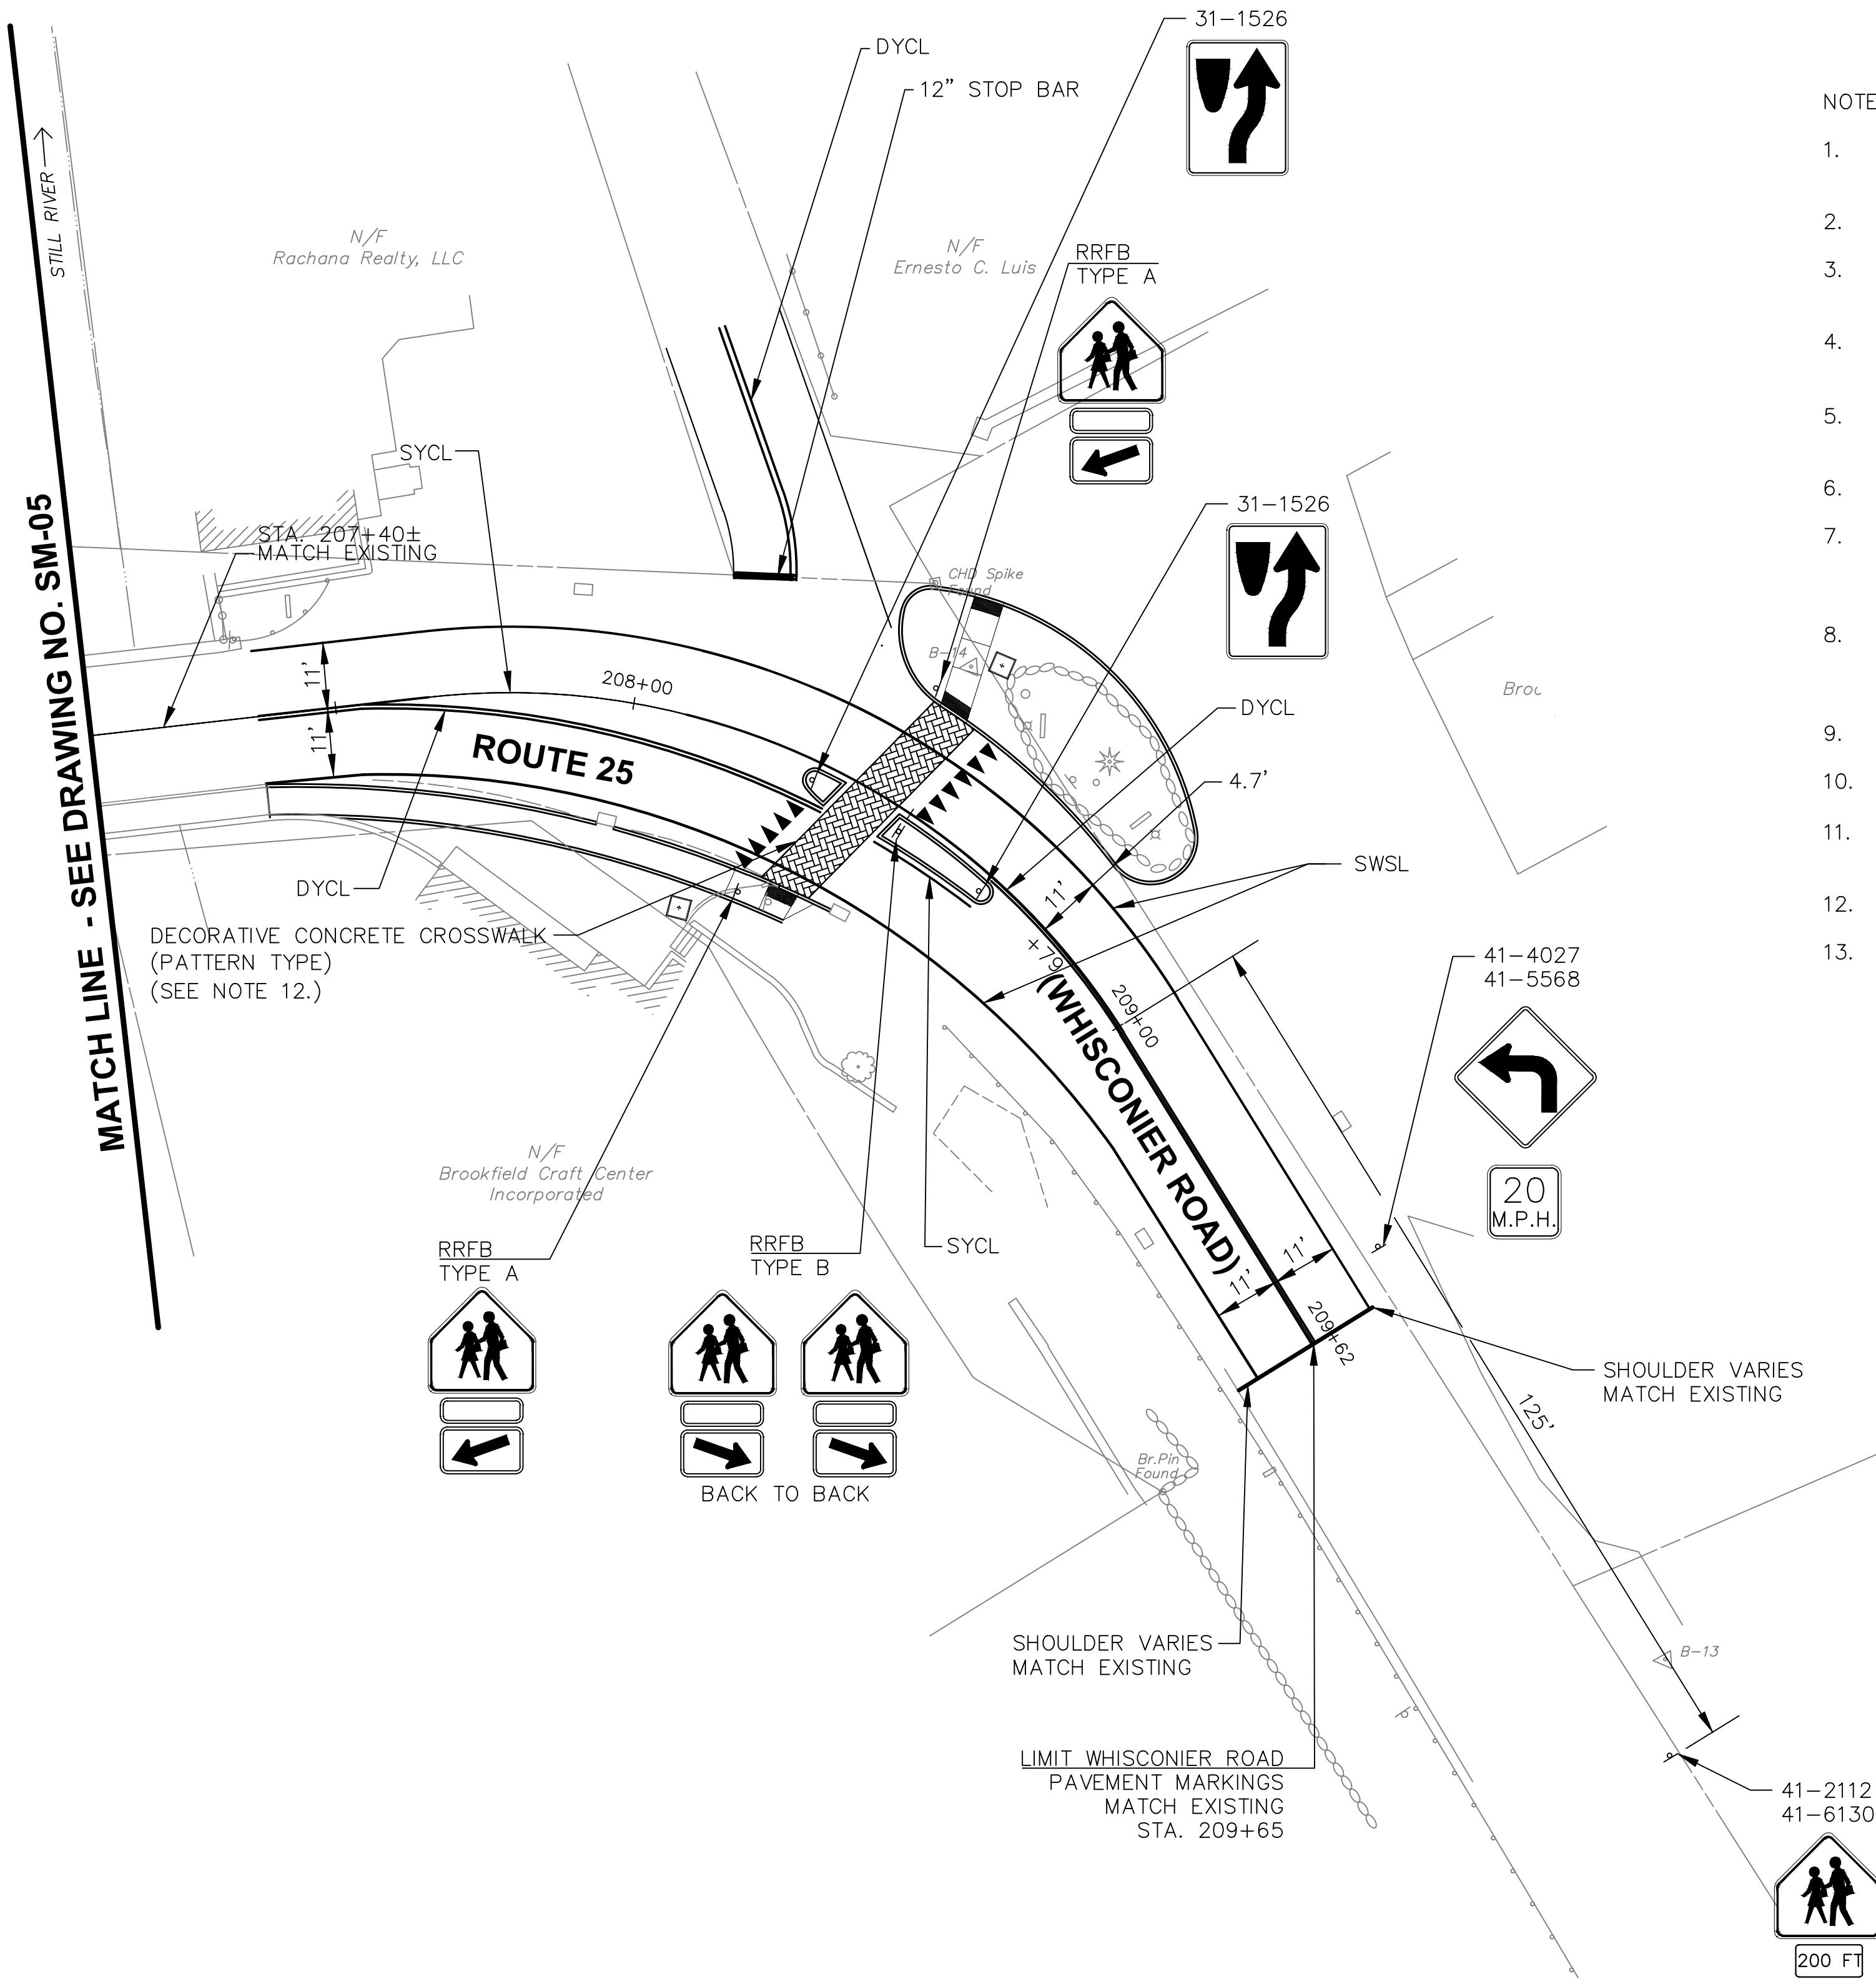

NOTES:


- ALL PAVEMENT MARKINGS SHALL BE OFFSET FROM THE BASE LINE UNLESS OTHERWISE NOTED.
- ERADICATE ANY CONFLICTING MARKINGS.
- INSPECTOR SHALL REVIEW ALL PRE-MARKS PRIOR TO INSTALLATION OF MARKINGS.
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- BARS SHALL NORMALLY BE NO CLOSER THAN 2' FROM CURB/EDGE OF ROAD. WHERE EXCESS SPACE MAY DEVELOP THIS DISTANCE MAY BE DECREASED TO 1'.
- ONLY FULL LENGTH BARS ARE TO BE INSTALLED AT CORNERS.
- ALL SIGNS ARE NEW UNLESS NOTED OTHERWISE.
- CROSSWALK TO BE EDGED IN 12" WHITE TRANSVERSE RETROREFLECTIVE MARKINGS.
- TOWN TO MAINTAIN DECORATIVE CONCRETE CROSSWALK.
- STATE TO MAINTAIN ALL OTHER SIGNS AND PAVEMENT MARKINGS ON ROUTE 25.

TOWN OF BROOKFIELD, CT

AECOM 500 ENTERPRISE DRIVE, SUITE 3B ROCKY HILL, CT 06067 (860) 529-8882	PROJECT NAME: TOWN DISTRICT SIDEWALK AND ACCESS MANAGEMENT PLAN		
	SHEET TITLE: SIGNAGE & PAVEMENT MARKING PLAN, SHEET 6		
	FILE NAME:----	PLOT DATE: 4/20/2016	DRAWING NO.: SM-06
	PROJECT LEADER: SM DESIGNED BY: AG	DRAWN BY: AG CHECKED BY: PG	SHEET NO.: 50


1. ALL TRAFFIC EQUIPMENT IS NEW.
2. ALL MATERIAL AND CONSTRUCTION METHODS SHALL CONFORM TO THE FOLLOWING CURRENT D.O.T. DOCUMENTS WHICH CAN BE ACCESSED ON THE D.O.T. WEBSITE
 - STANDARD SPECIFICATIONS FOR ROADS, BRIDGES AND INCIDENTAL CONSTRUCTION (FORM 816)
 - SUPPLEMENTAL SPECIFICATIONS TO FORM 816.
 - SPECIAL PROVISIONS TO FORM 816.
 - STANDARD INSTALLATION AND GUIDE DETAIL SHEETS.

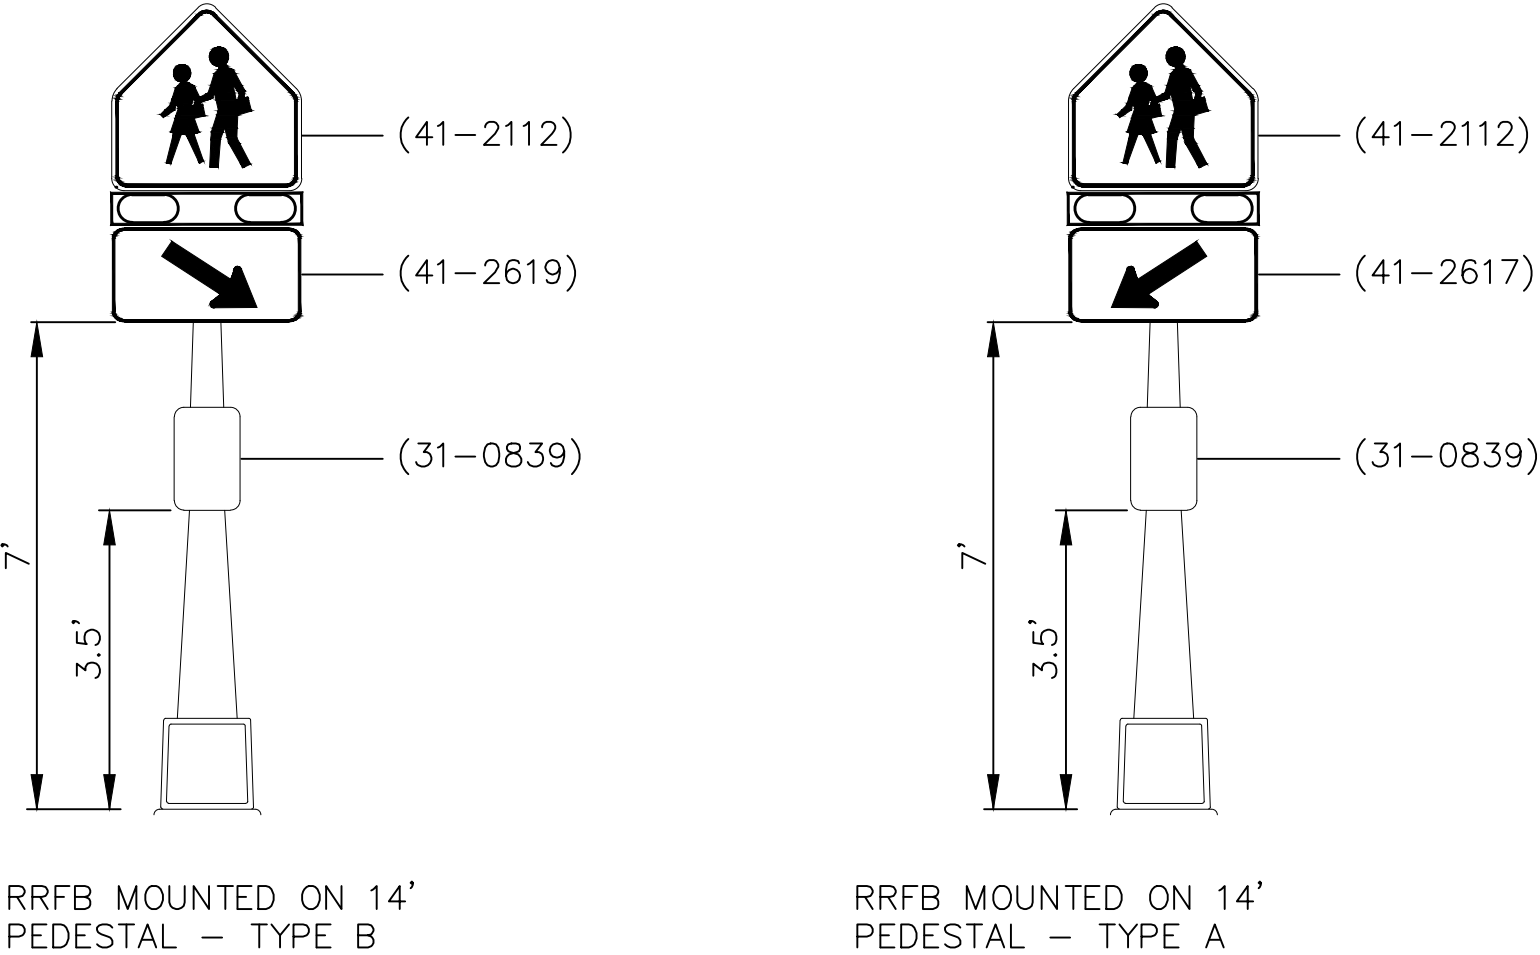C) INSTALL FLASHER CABINET ON PEDESTAL AS SHOWN.
FLASHER CABINET TO CONTROL RECTANGULAR RAPID FLASHING BEACONS.



Border Version 11/29/13


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- NOTES:
- 1. THE UTILITY COMPANY REPRESENTATIVE INFO FOR USE BY THE CONTRACTOR IS: EVERSOURCE, ROBERT RONCARTI, 20 BARNABAS ROAD, NEWTOWN, CT 06470, 203-270-5808.
 - 2. STREET LIGHT LOCATIONS AND PHOTOMETRICS PREPARED BY APEX LIGHTING SOLUTIONS.

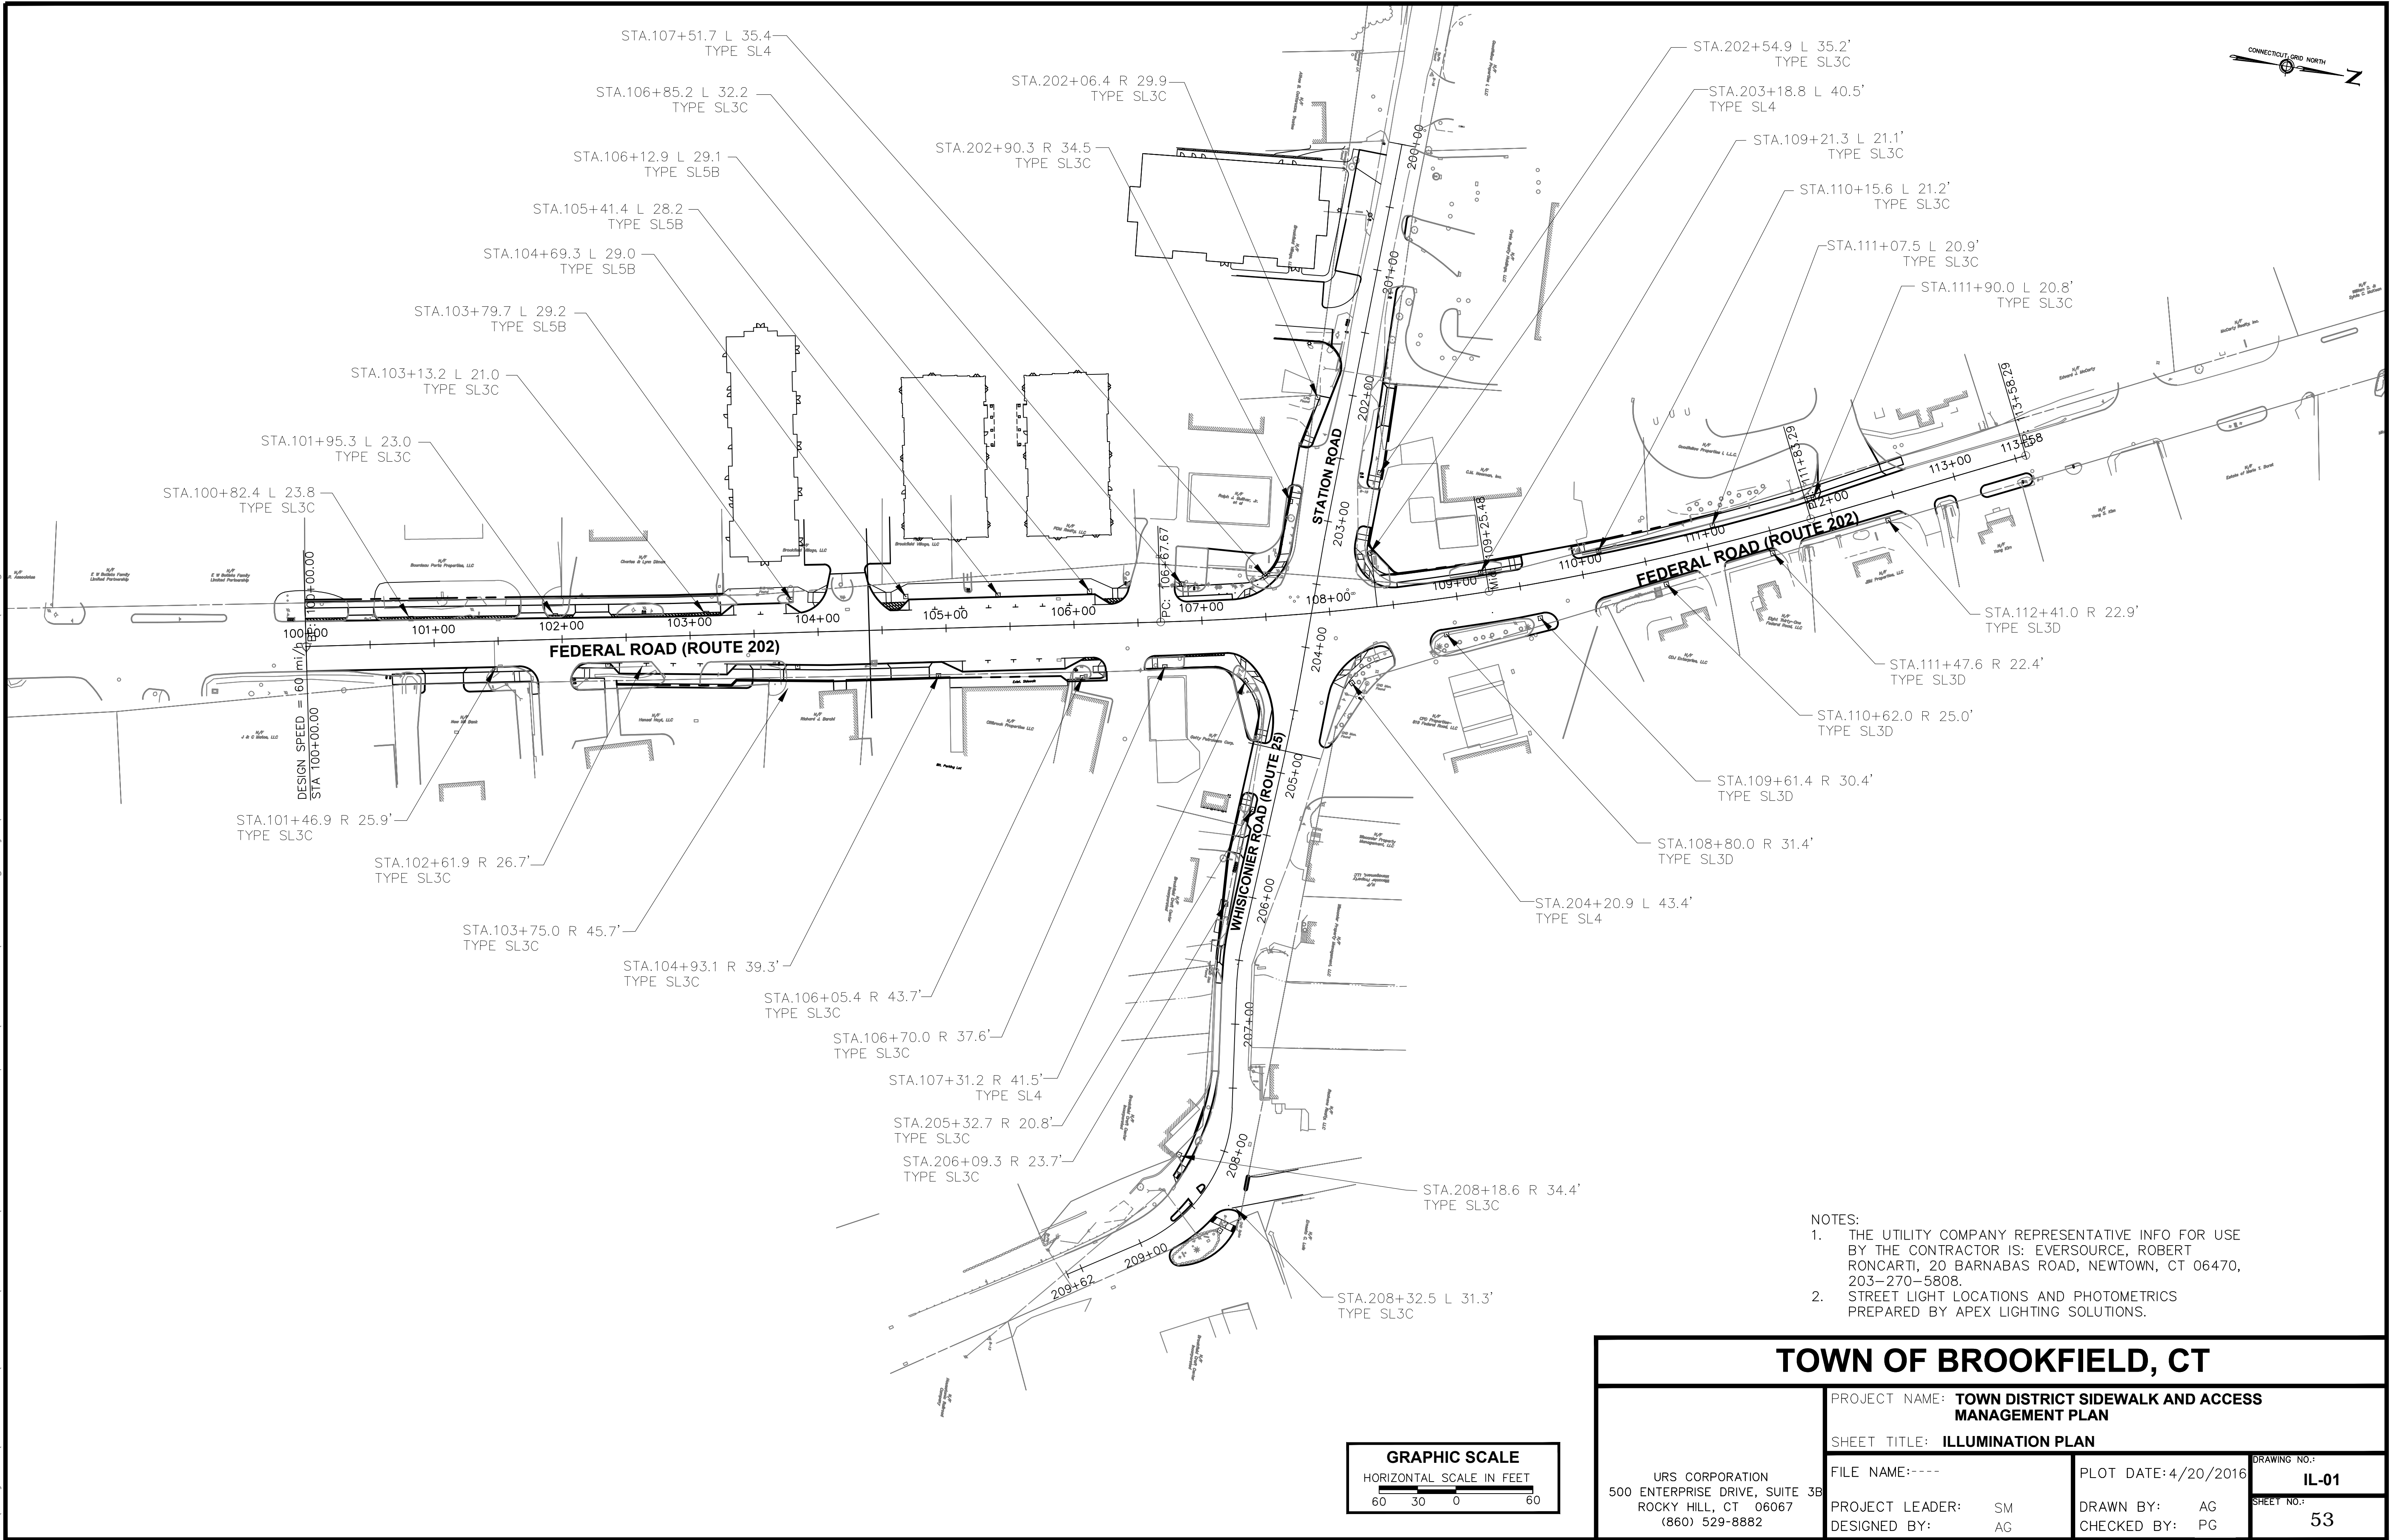
TOWN OF BROOKFIELD, CT			
URS CORPORATION 500 ENTERPRISE DRIVE, SUITE 3B ROCKY HILL, CT 06067 (860) 529-8882	PROJECT NAME: TOWN DISTRICT SIDEWALK AND ACCESS MANAGEMENT PLAN		
	SHEET TITLE: ILLUMINATION PLAN		
	FILE NAME:----	PLOT DATE: 4/20/2016	DRAWING NO.: IL-01
	PROJECT LEADER: SM	DRAWN BY: AG	SHEET NO.: 53
	DESIGNED BY: AG	CHECKED BY: PG	
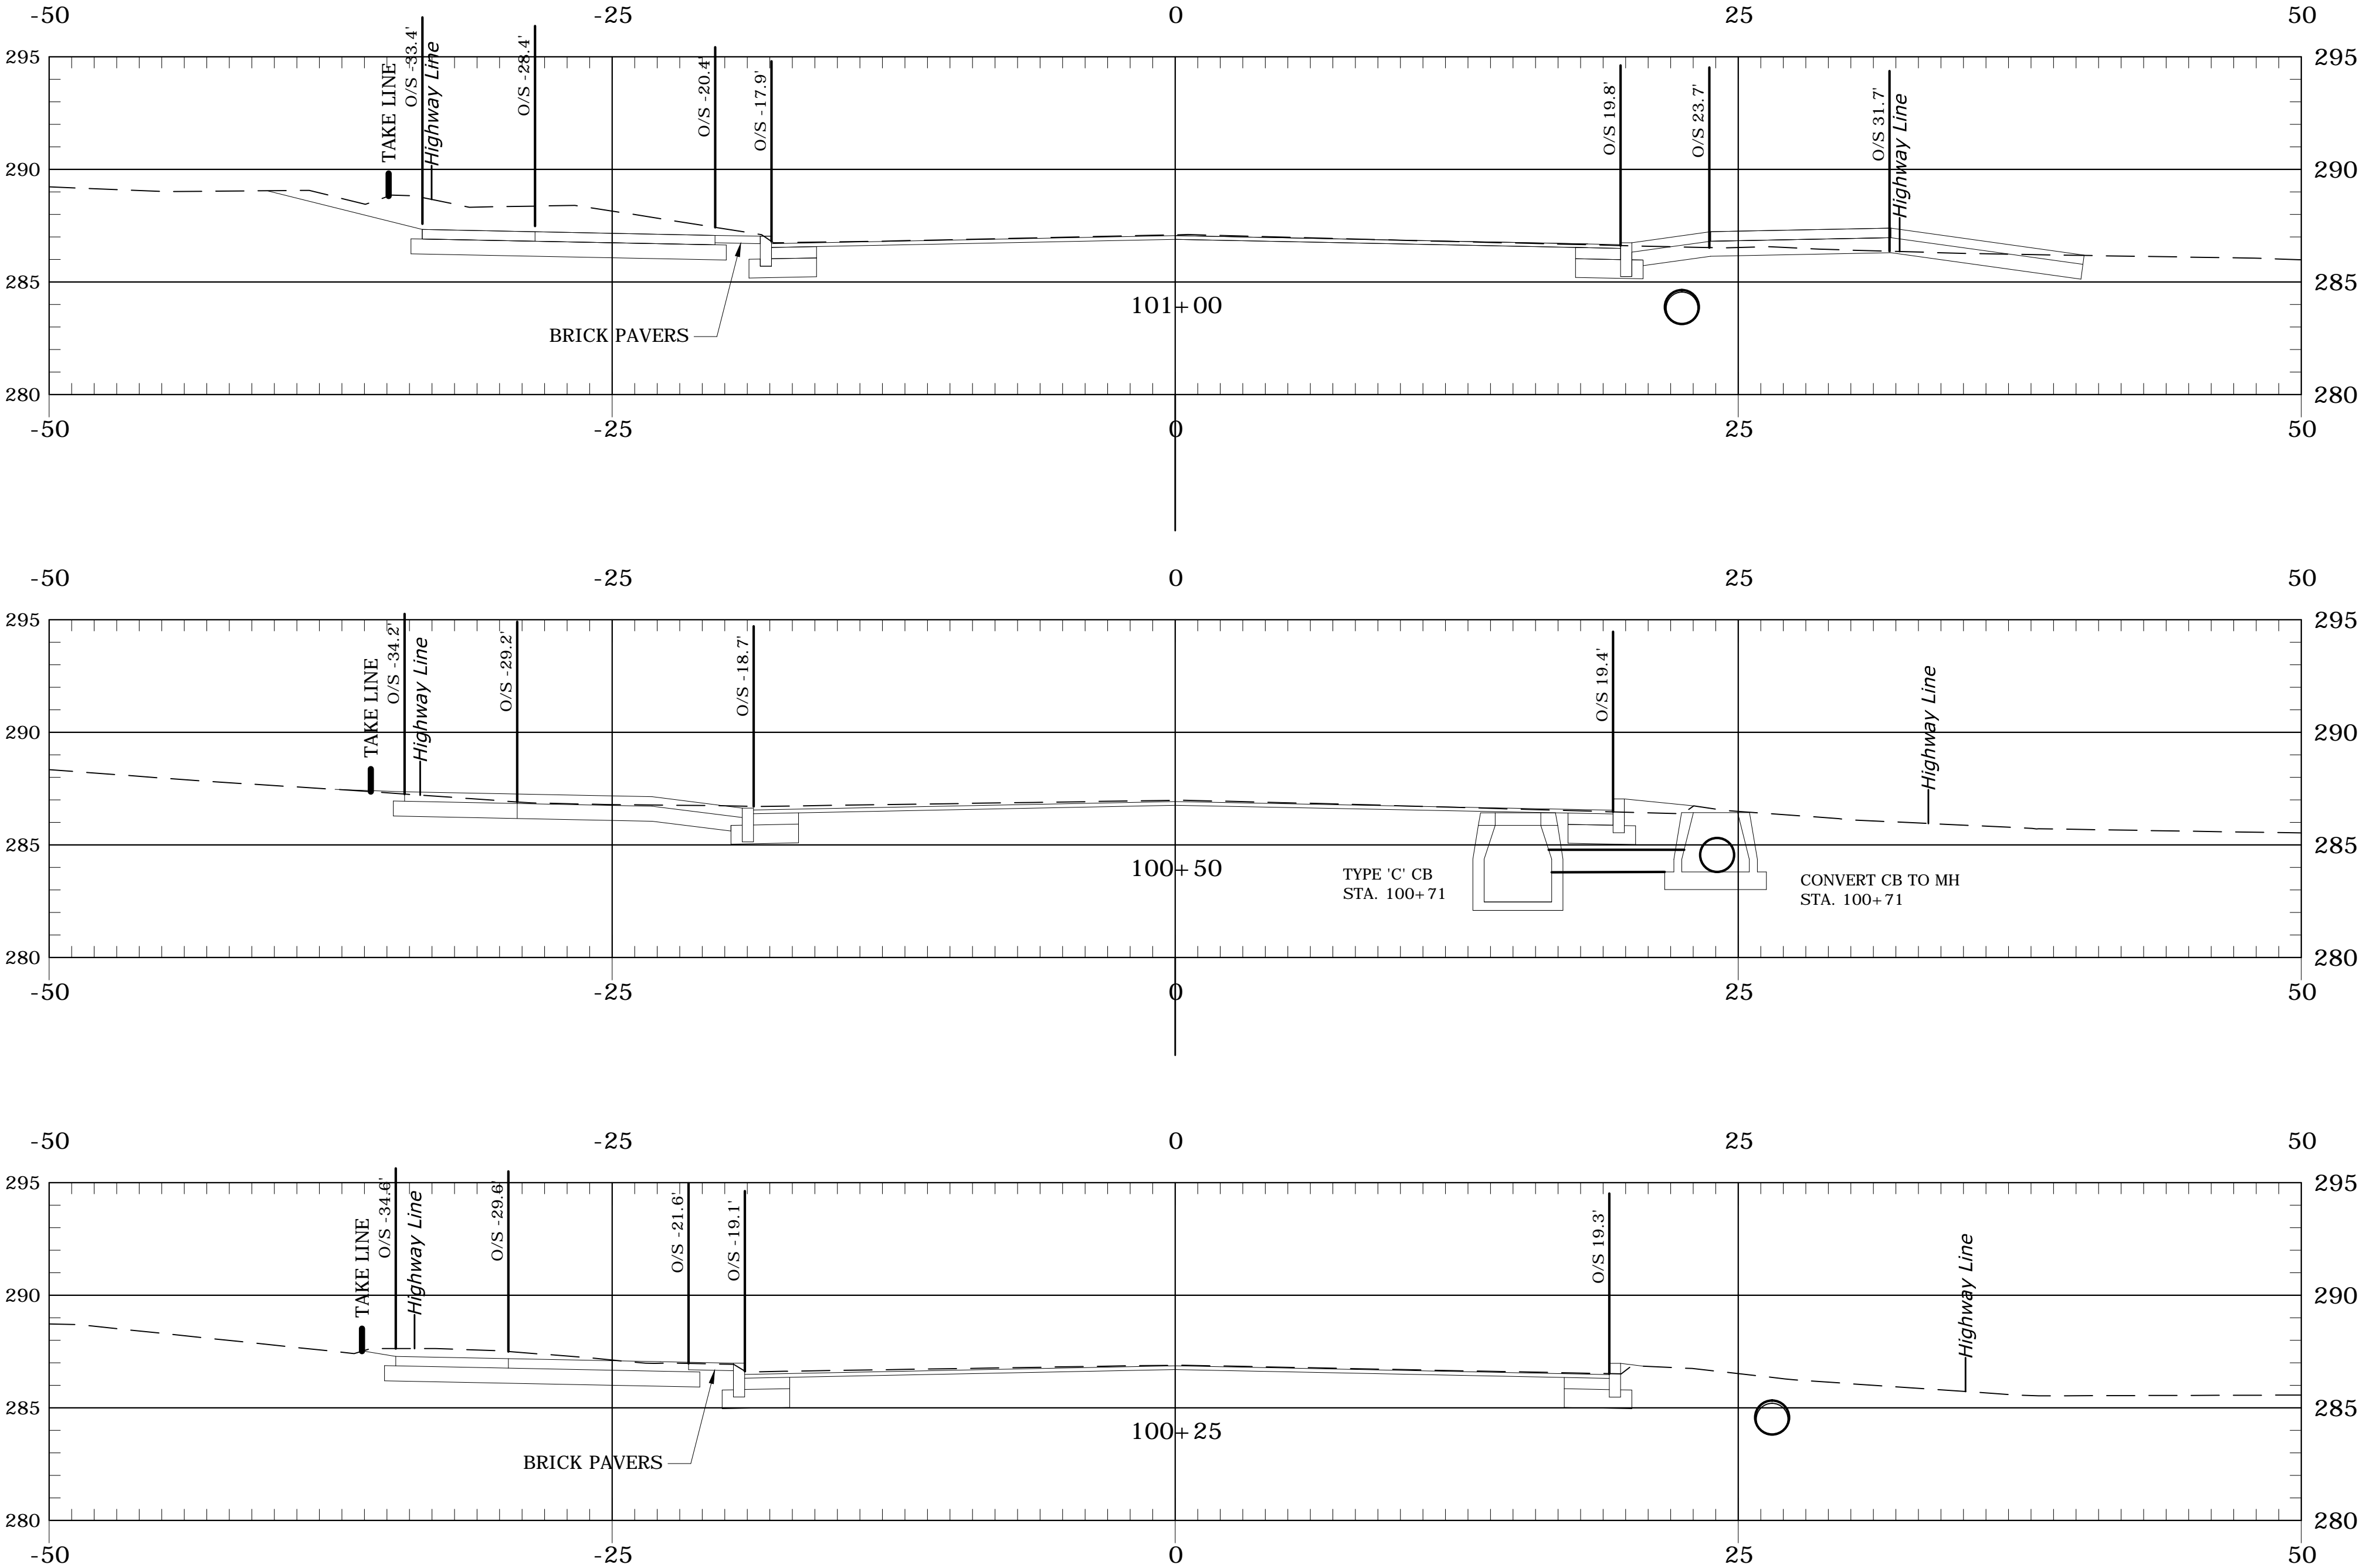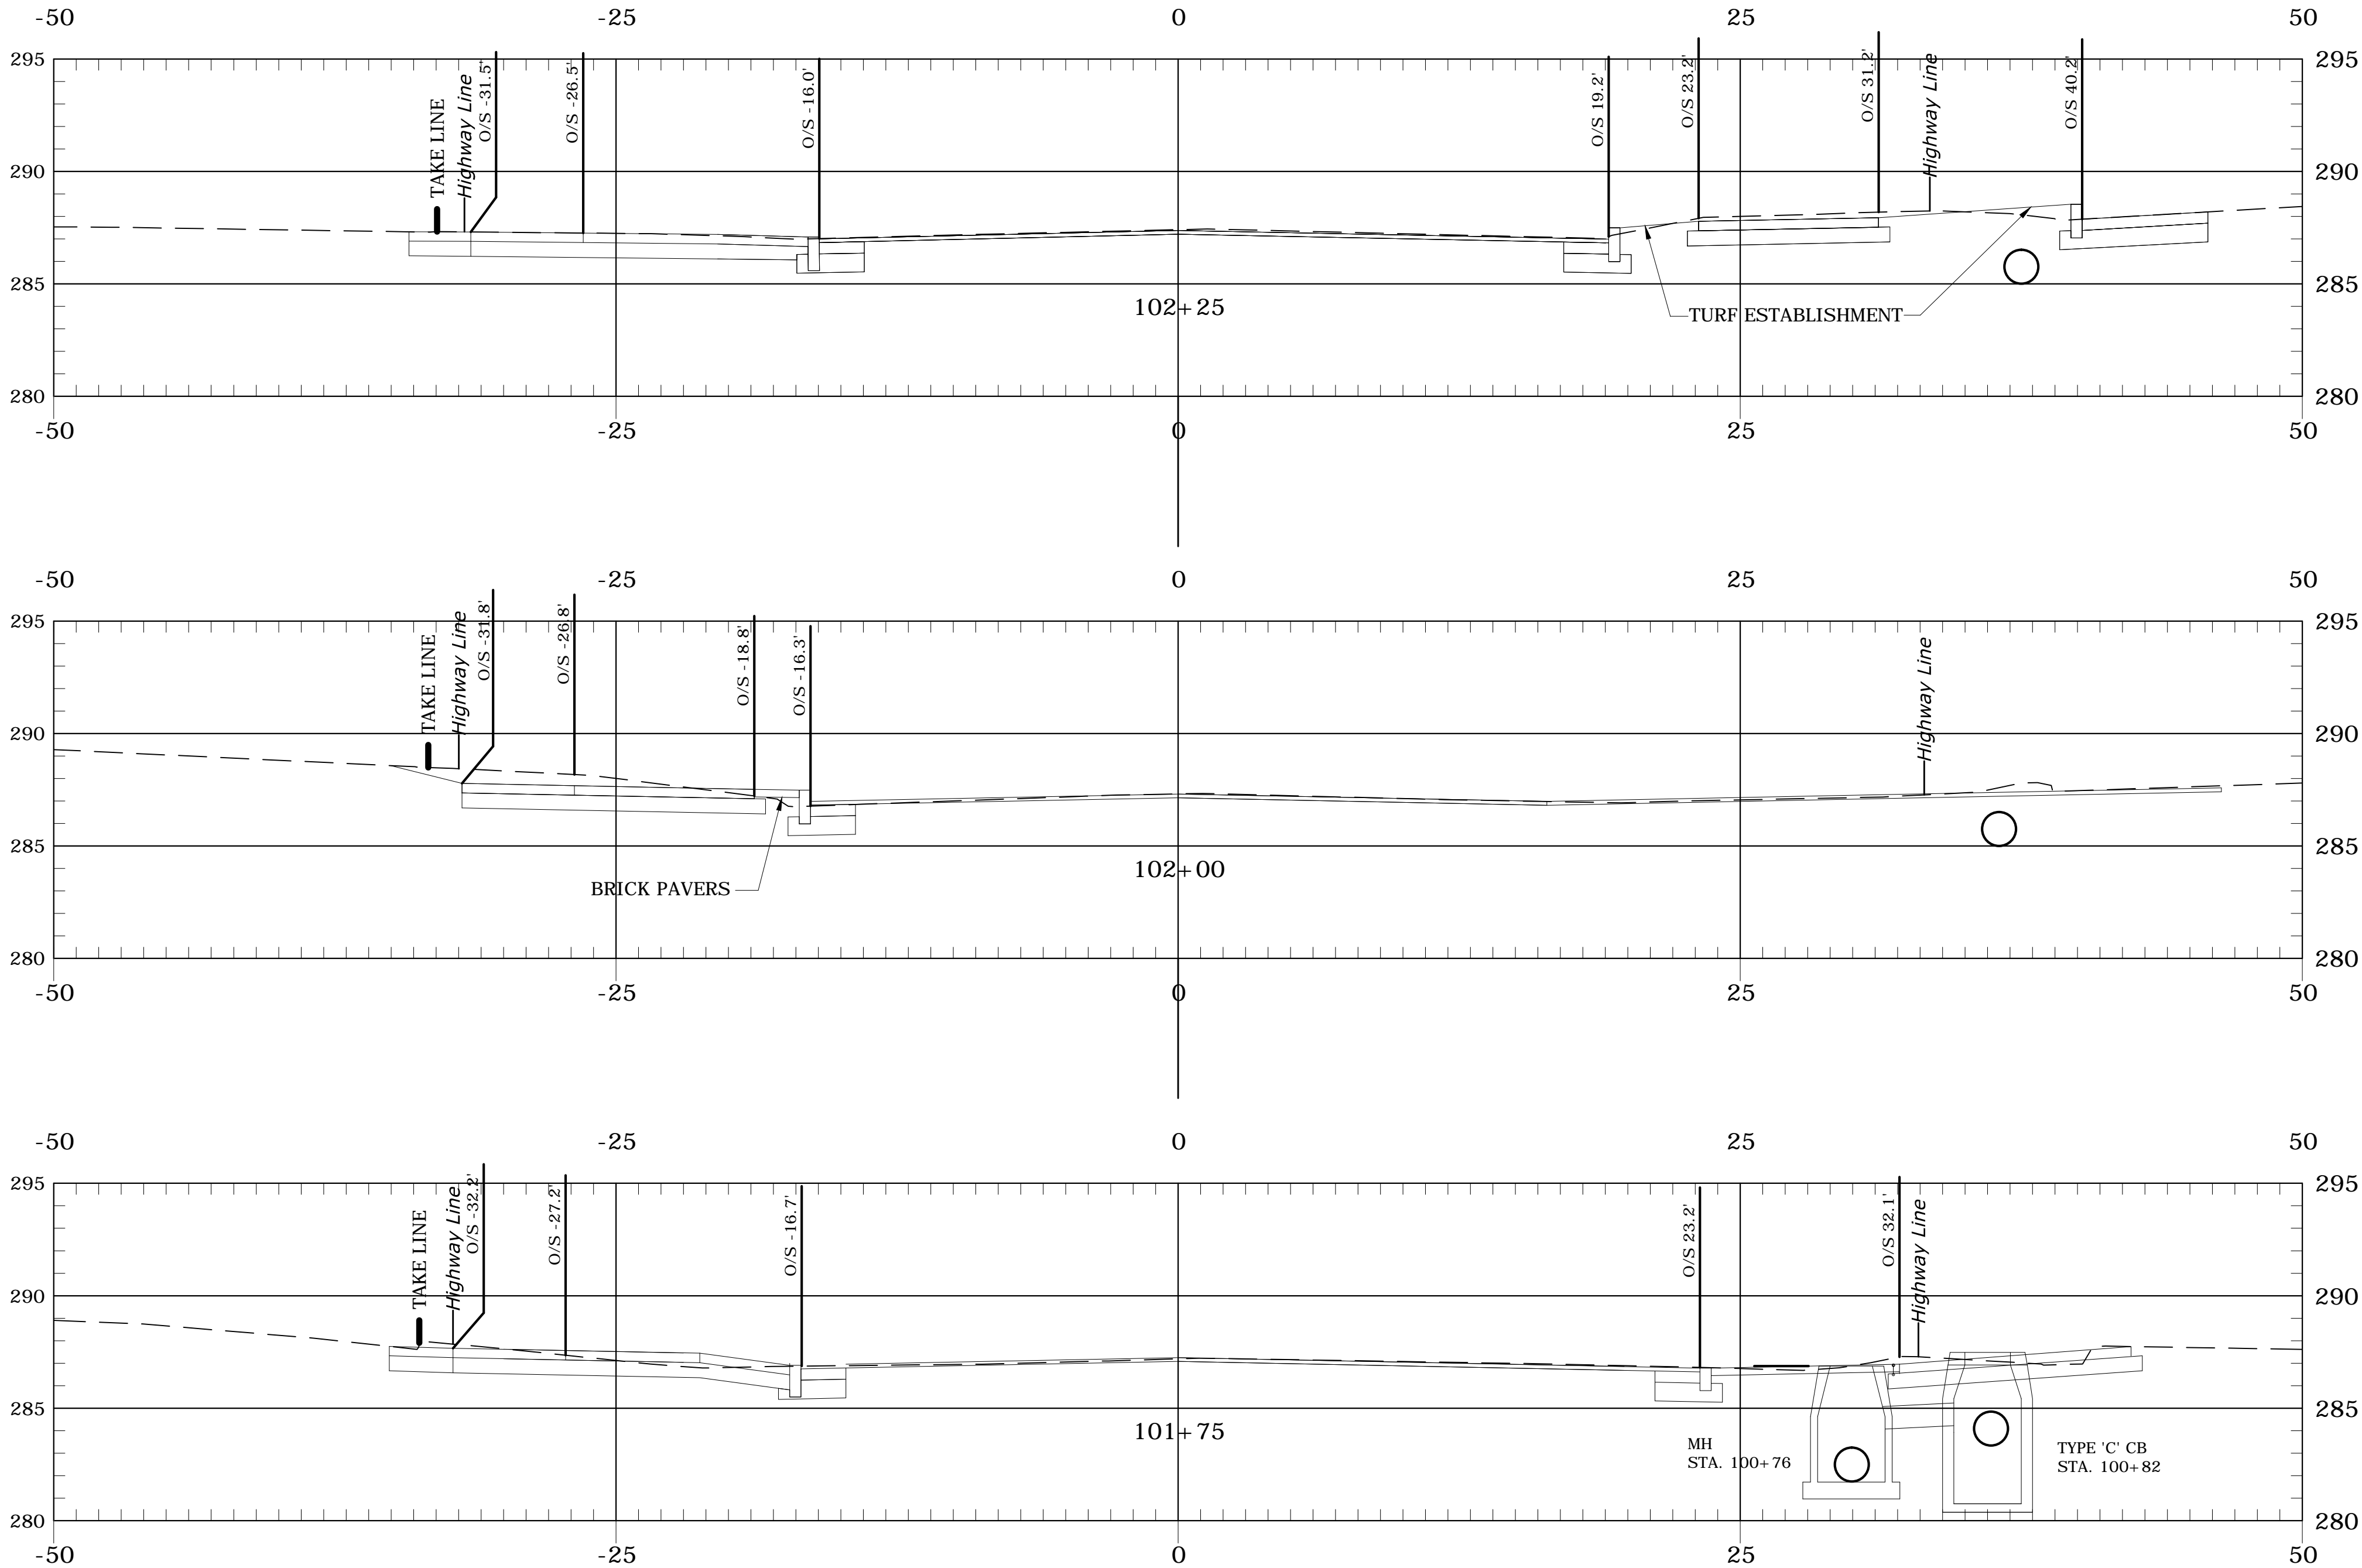
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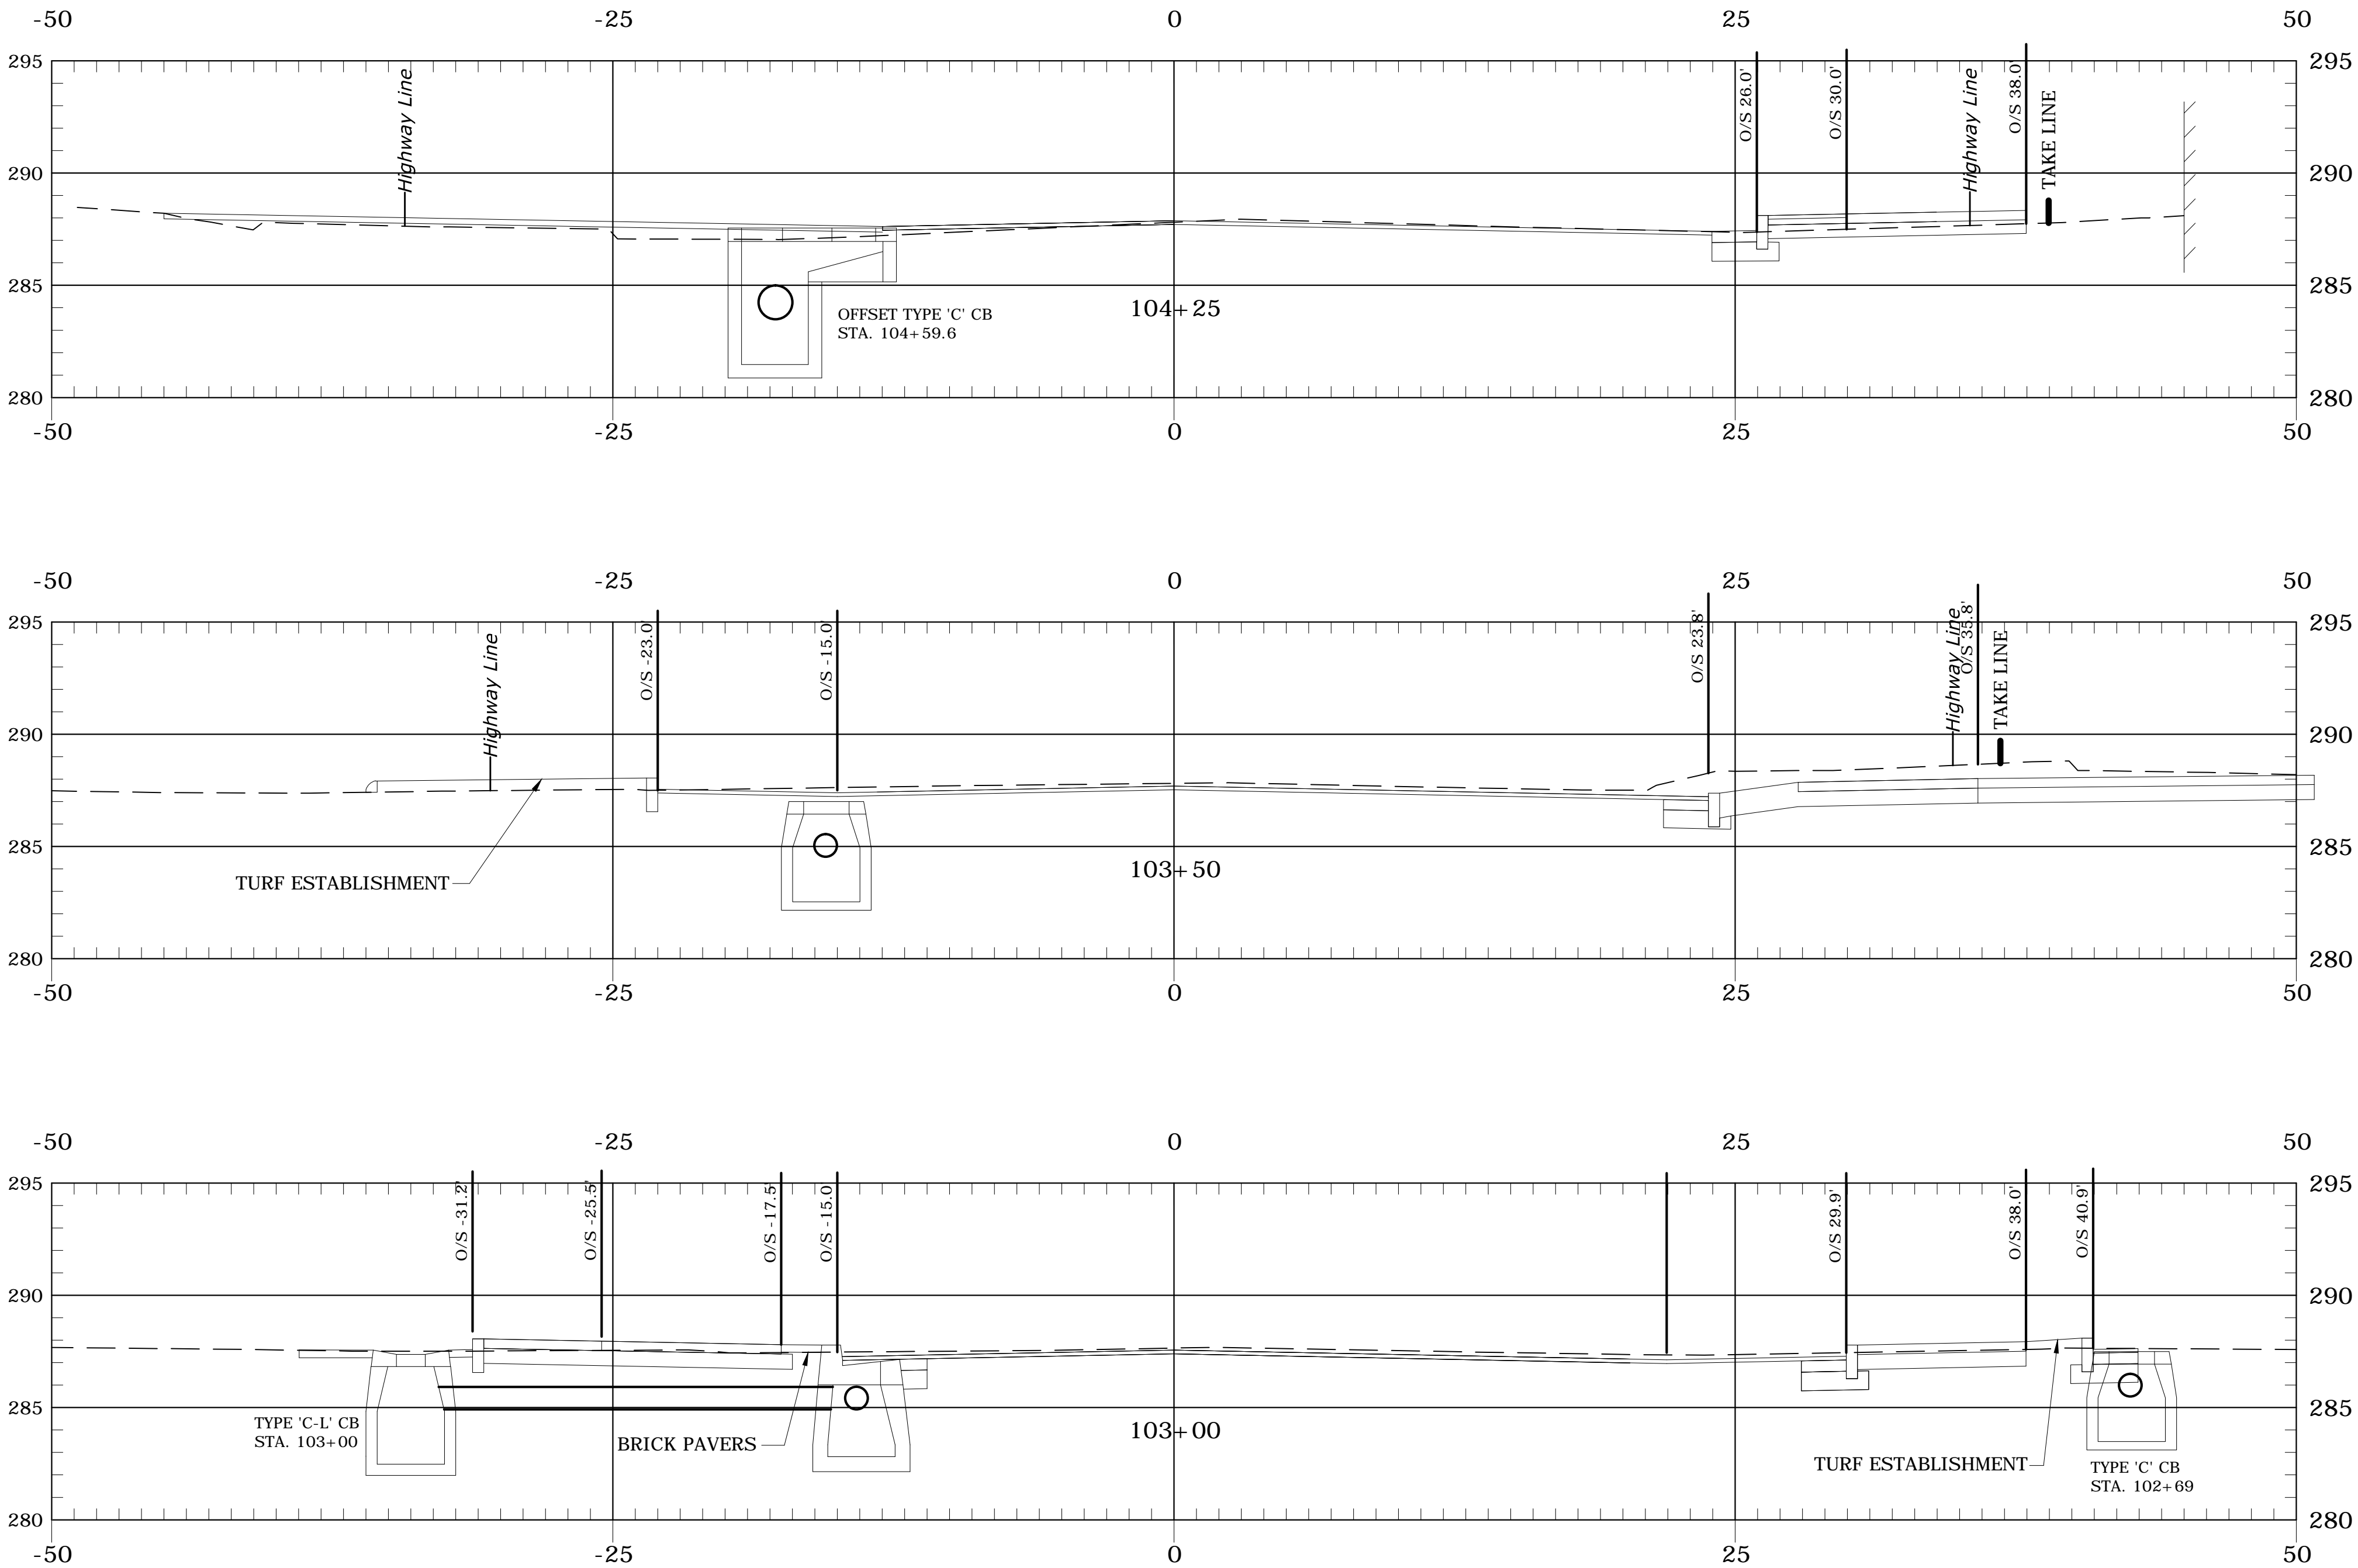
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GRAPHIC SCALE VERTICAL SCALE IN FEET 5 2.5 0 5		URS CORPORATION 500 ENTERPRISE DRIVE, SUITE 3B ROCKY HILL, CT 06067 (860) 529-8882	PROJECT NAME: TOWN DISTRICT SIDEWALK AND ACCESS MANAGEMENT PLAN
			SHEET TITLE: FEDERAL ROAD CROSS SECTION, SHEET 01
			FILE NAME:-----
		PLOT DATE: 4/20/2016	DRAWING NO.: XS-01
		PROJECT LEADER: SM	DRAWN BY: AG
		DESIGNED BY: AG	CHECKED BY: PG
			SHEET NO.: 54

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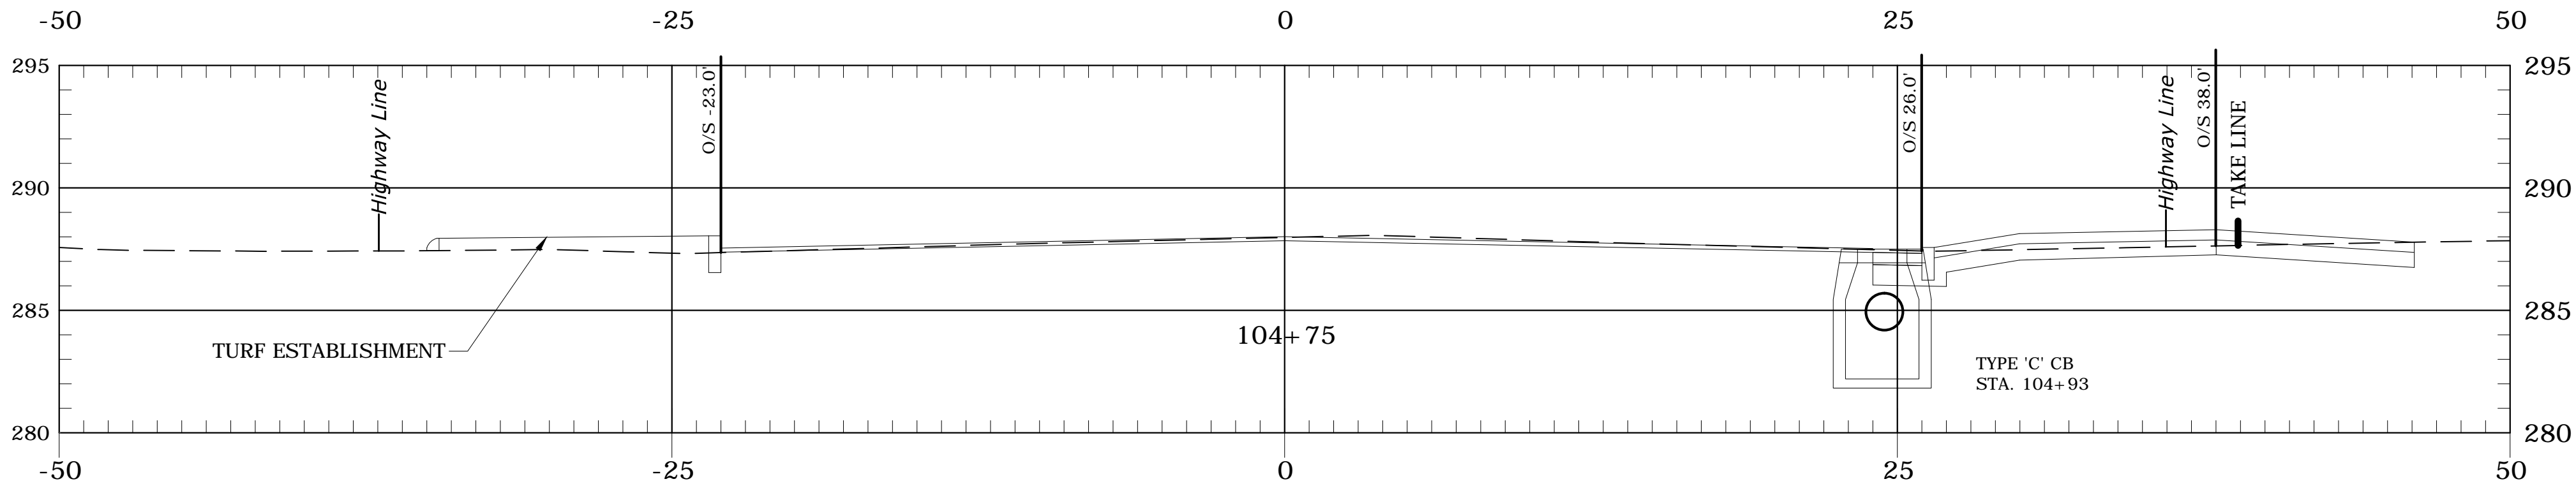
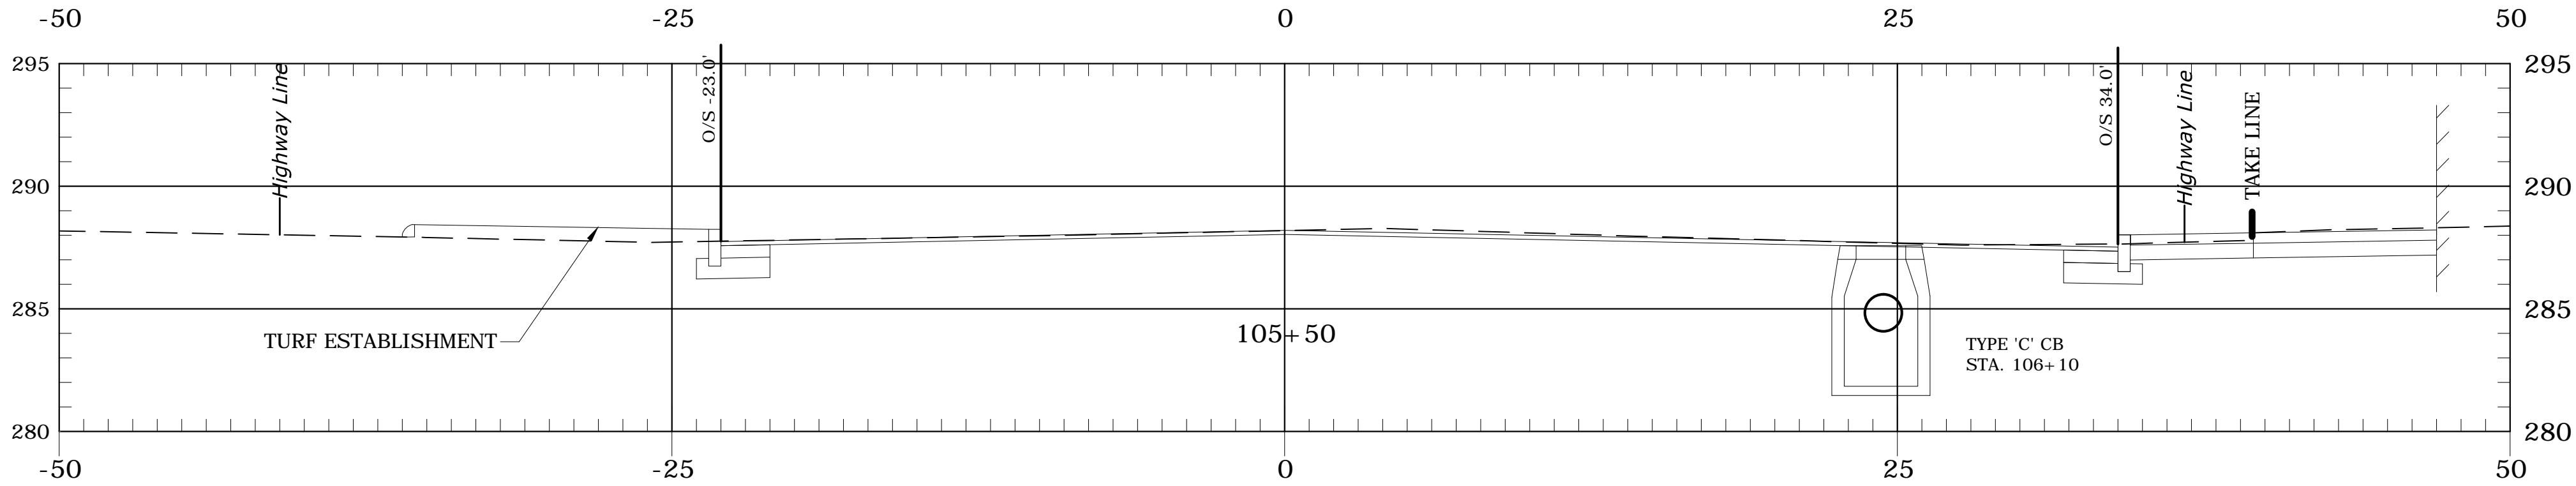
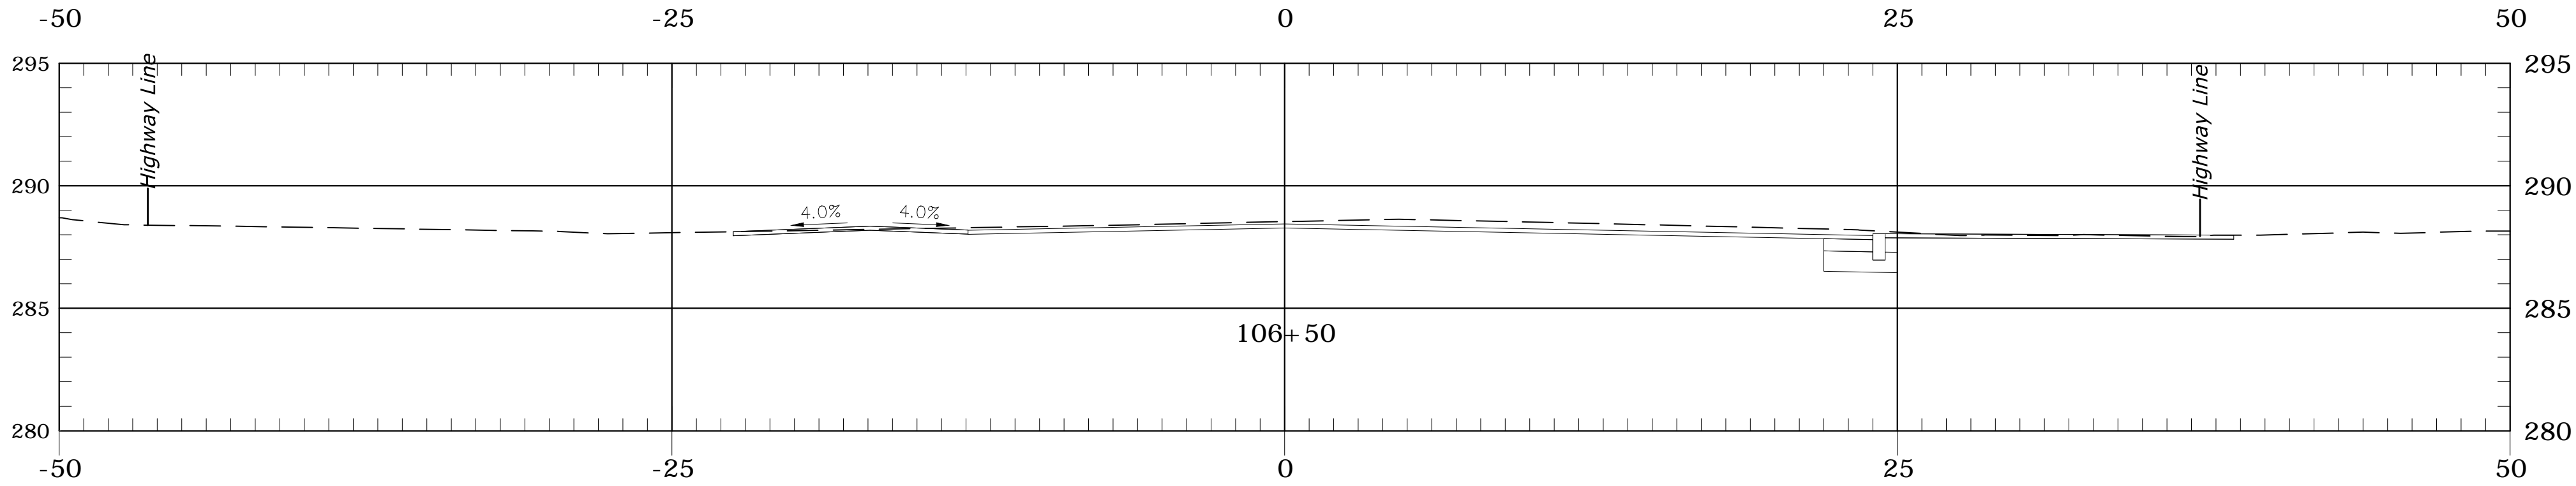
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GRAPHIC SCALE VERTICAL SCALE IN FEET 5 2.5 0 5		PROJECT NAME: TOWN DISTRICT SIDEWALK AND ACCESS MANAGEMENT PLAN	
URS CORPORATION 500 ENTERPRISE DRIVE, SUITE 3B ROCKY HILL, CT 06067 (860) 529-8882		SHEET TITLE: FEDERAL ROAD CROSS SECTION, SHEET 02	
		FILE NAME:----	PLOT DATE: 4/20/2016
		PROJECT LEADER: SM DESIGNED BY: AG	DRAWN BY: AG CHECKED BY: PG
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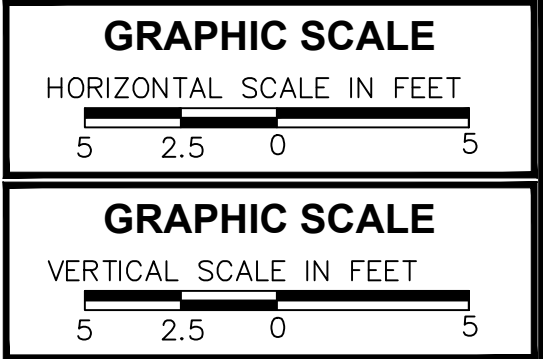
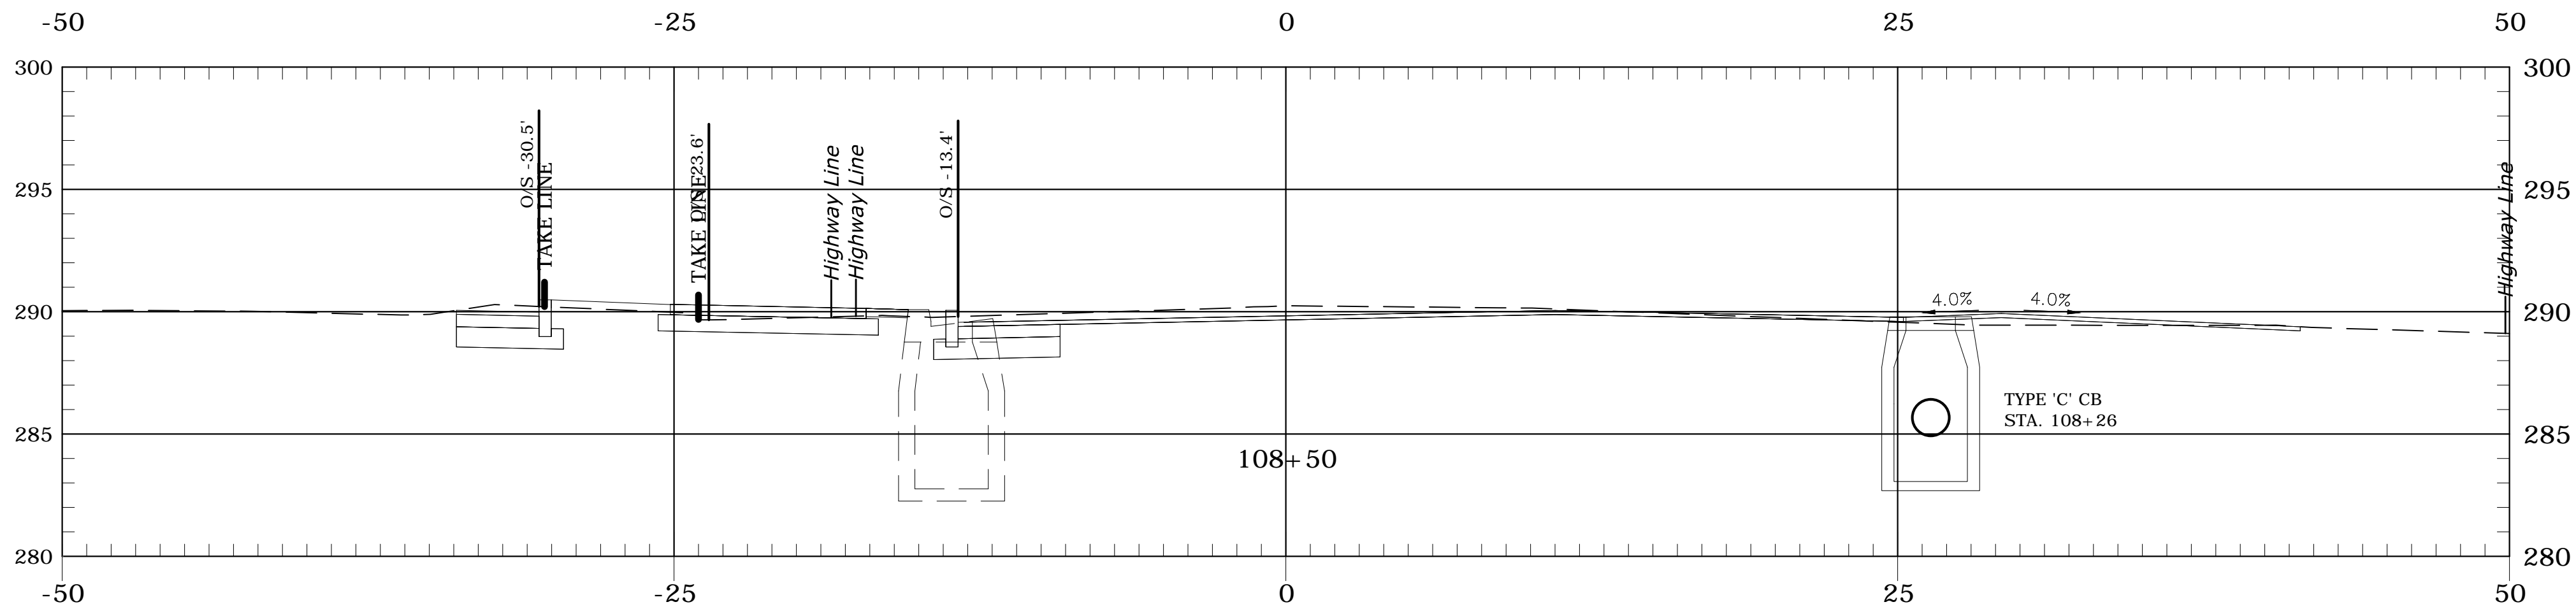
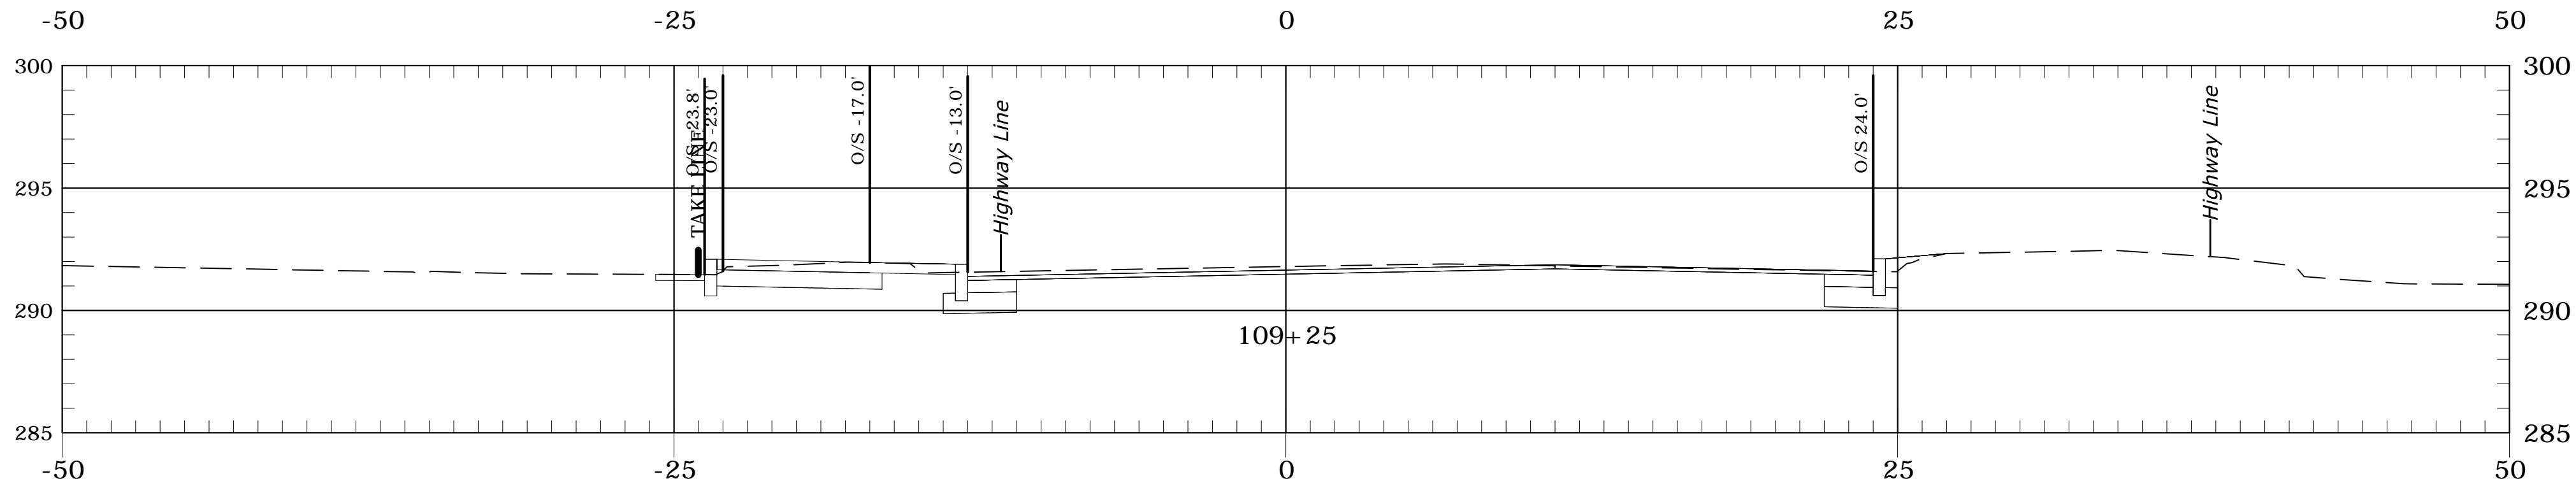
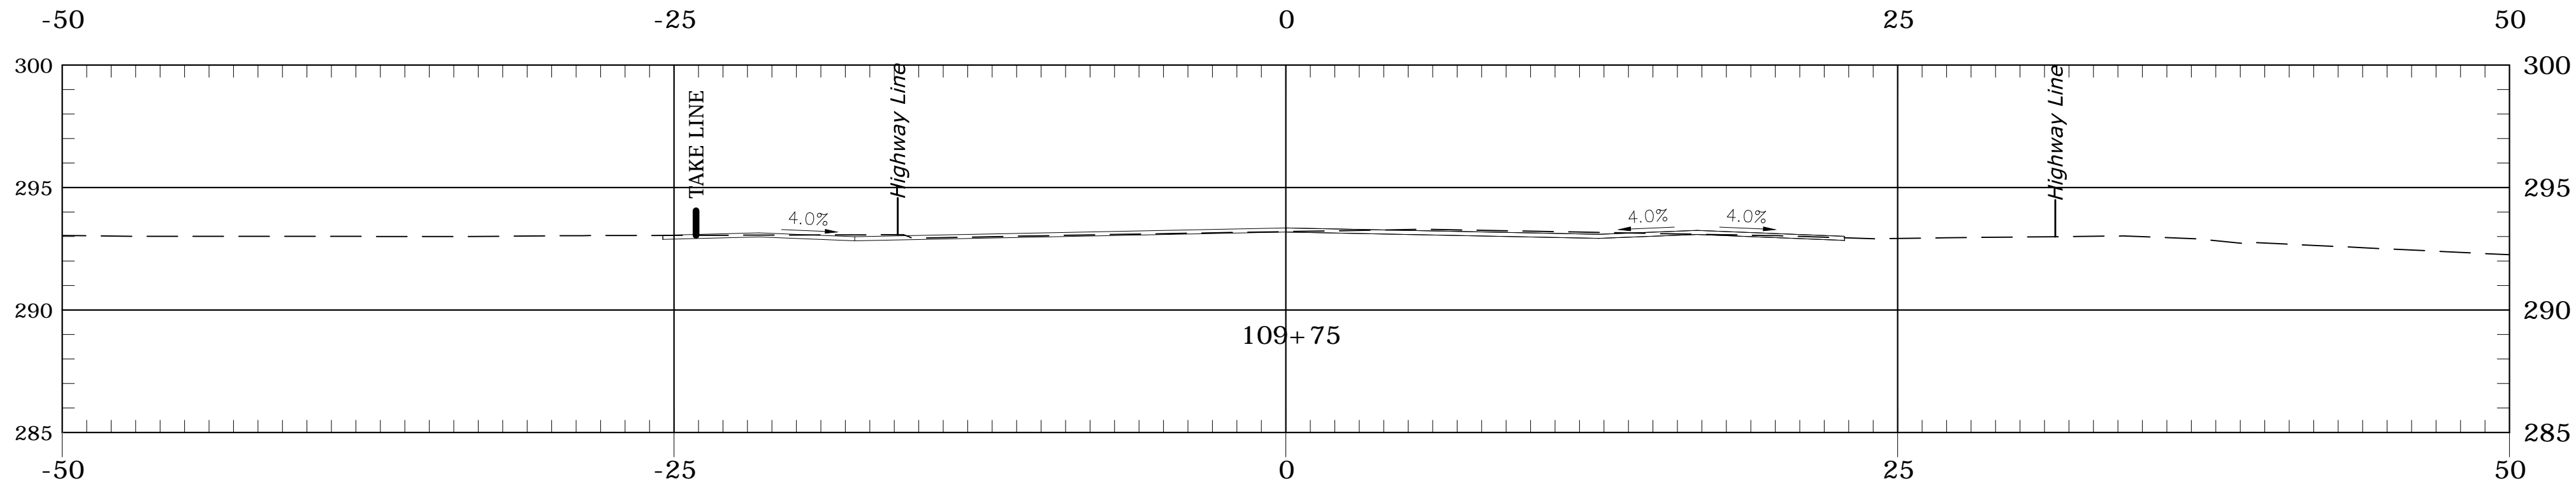
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GRAPHIC SCALE VERTICAL SCALE IN FEET 5 2.5 0 5		PROJECT NAME: TOWN DISTRICT SIDEWALK AND ACCESS MANAGEMENT PLAN	
URS CORPORATION 500 ENTERPRISE DRIVE, SUITE 3B ROCKY HILL, CT 06067 (860) 529-8882		SHEET TITLE: FEDERAL ROAD CROSS SECTION, SHEET 03	
		FILE NAME:-----	PLOT DATE: 4/20/2016
		PROJECT LEADER: SM DESIGNED BY: AG	DRAWN BY: AG CHECKED BY: PG
		DRAWING NO.: XS-03	SHEET NO.: 56

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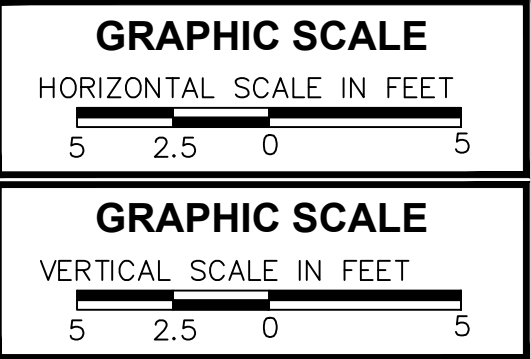
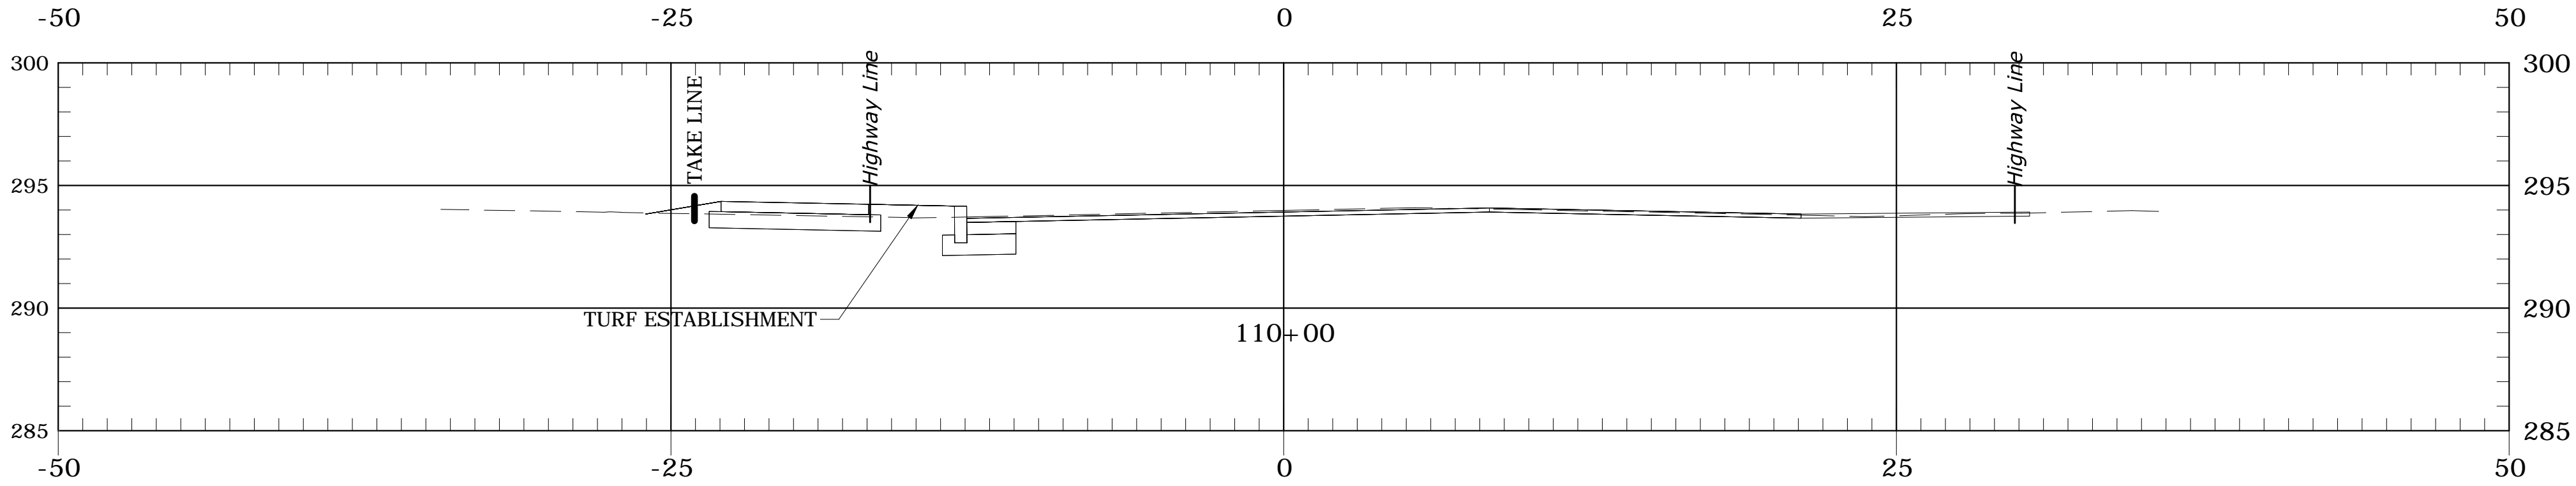
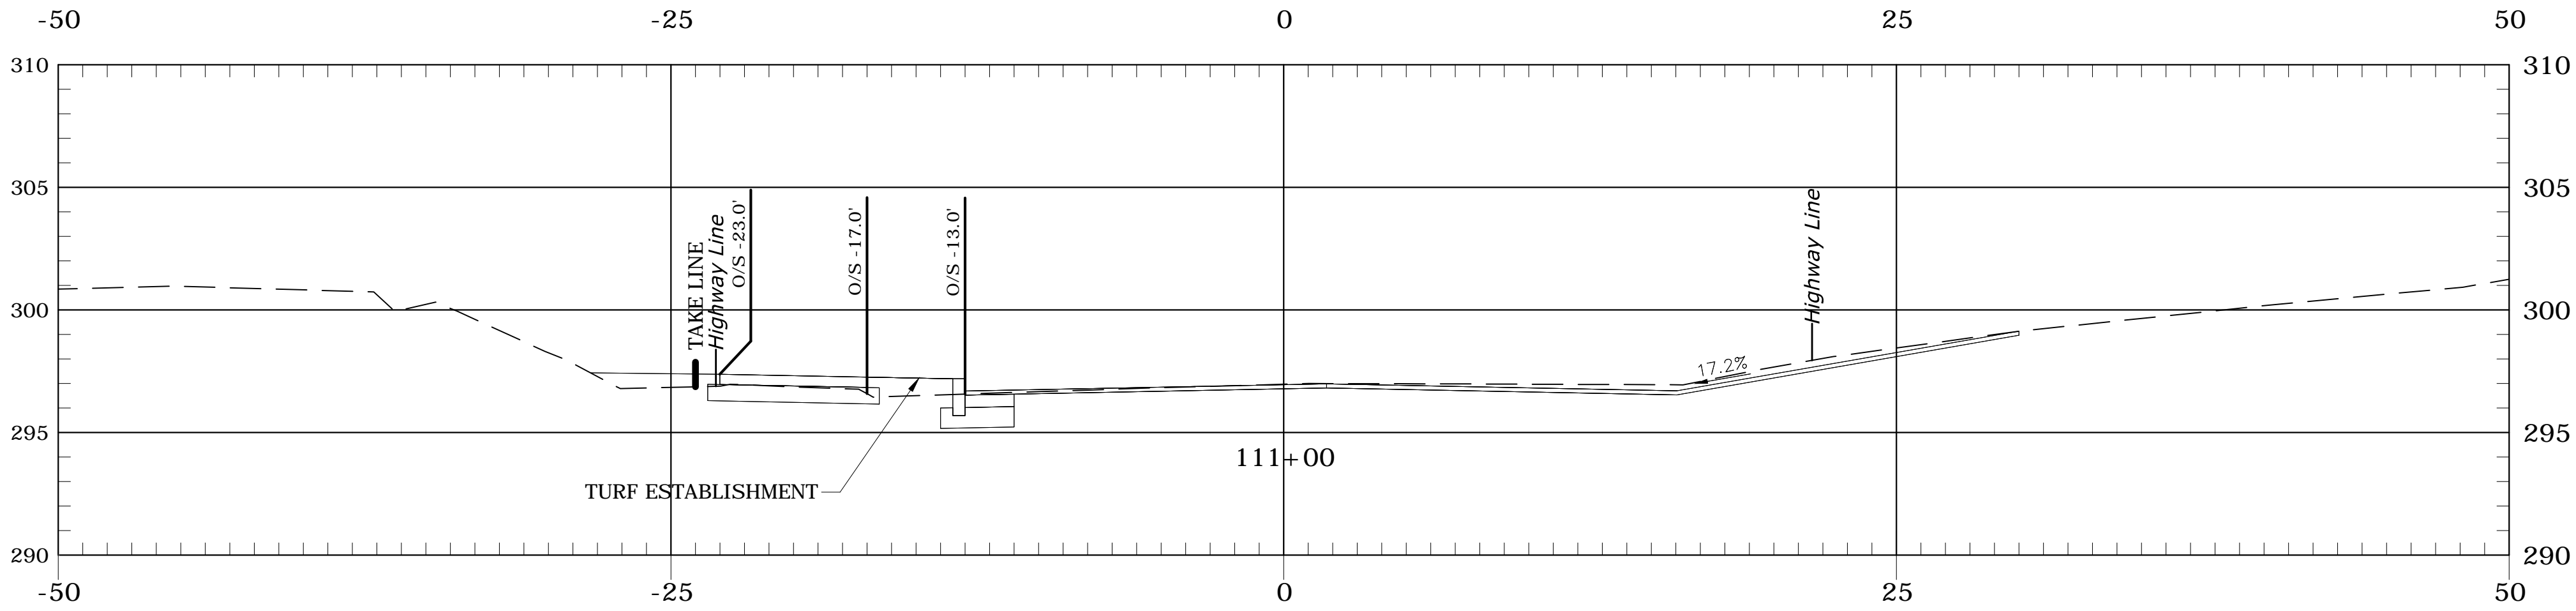
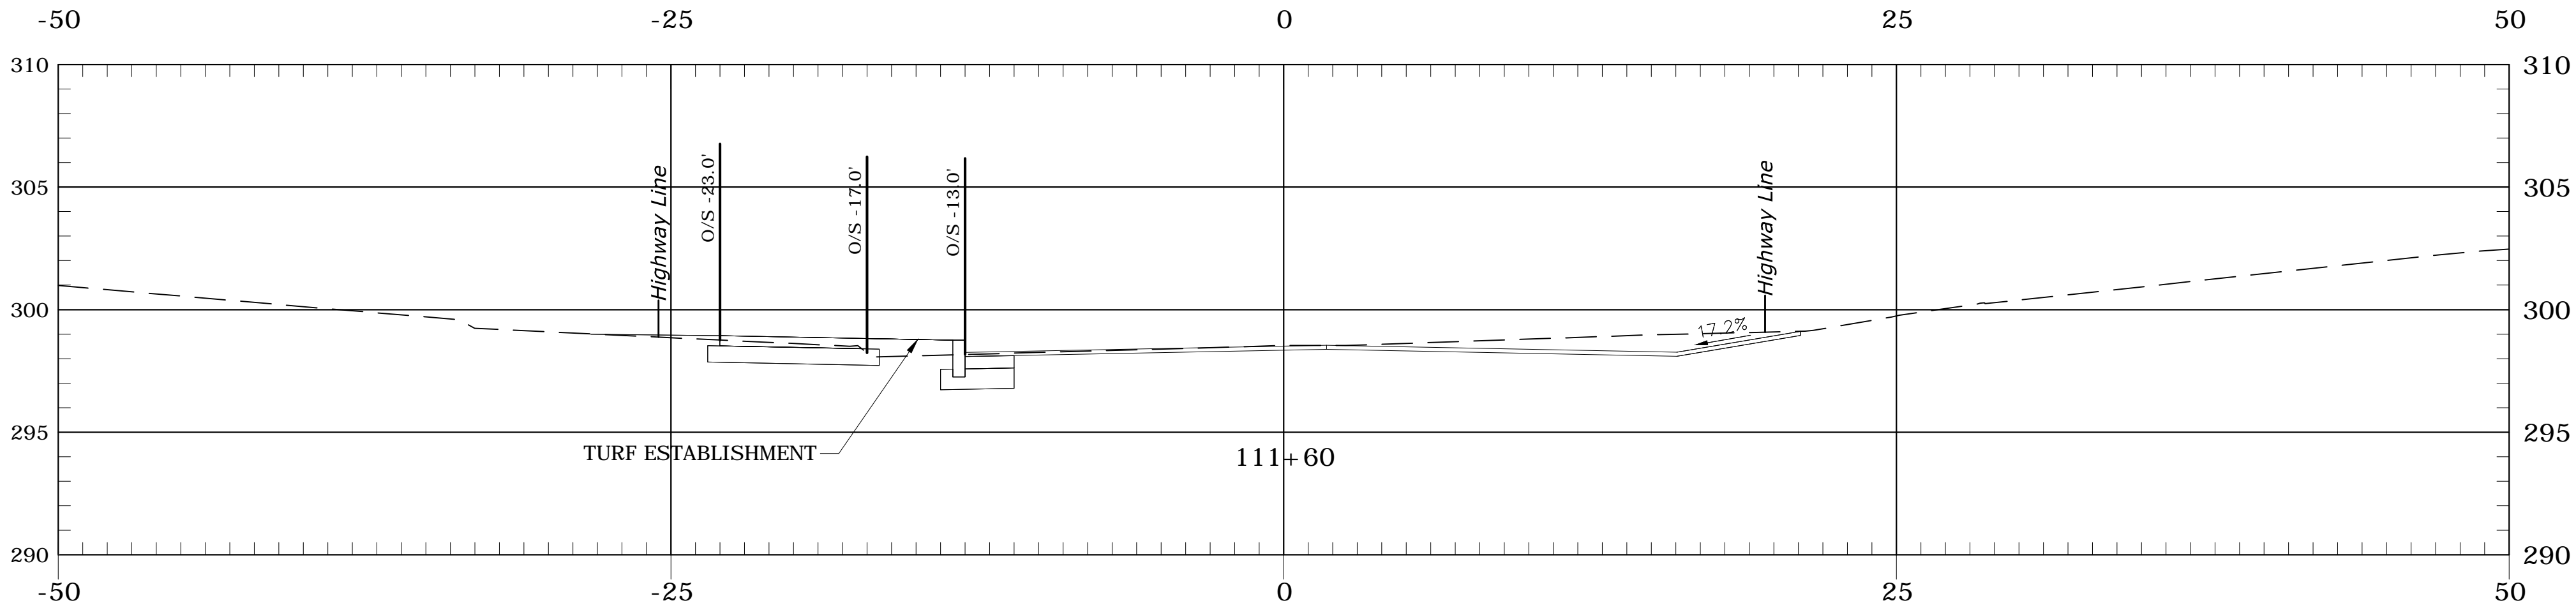
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URS CORPORATION 500 ENTERPRISE DRIVE, SUITE 3B ROCKY HILL, CT 06067 (860) 529-8882		SHEET TITLE: FEDERAL ROAD CROSS SECTION, SHEET 04	
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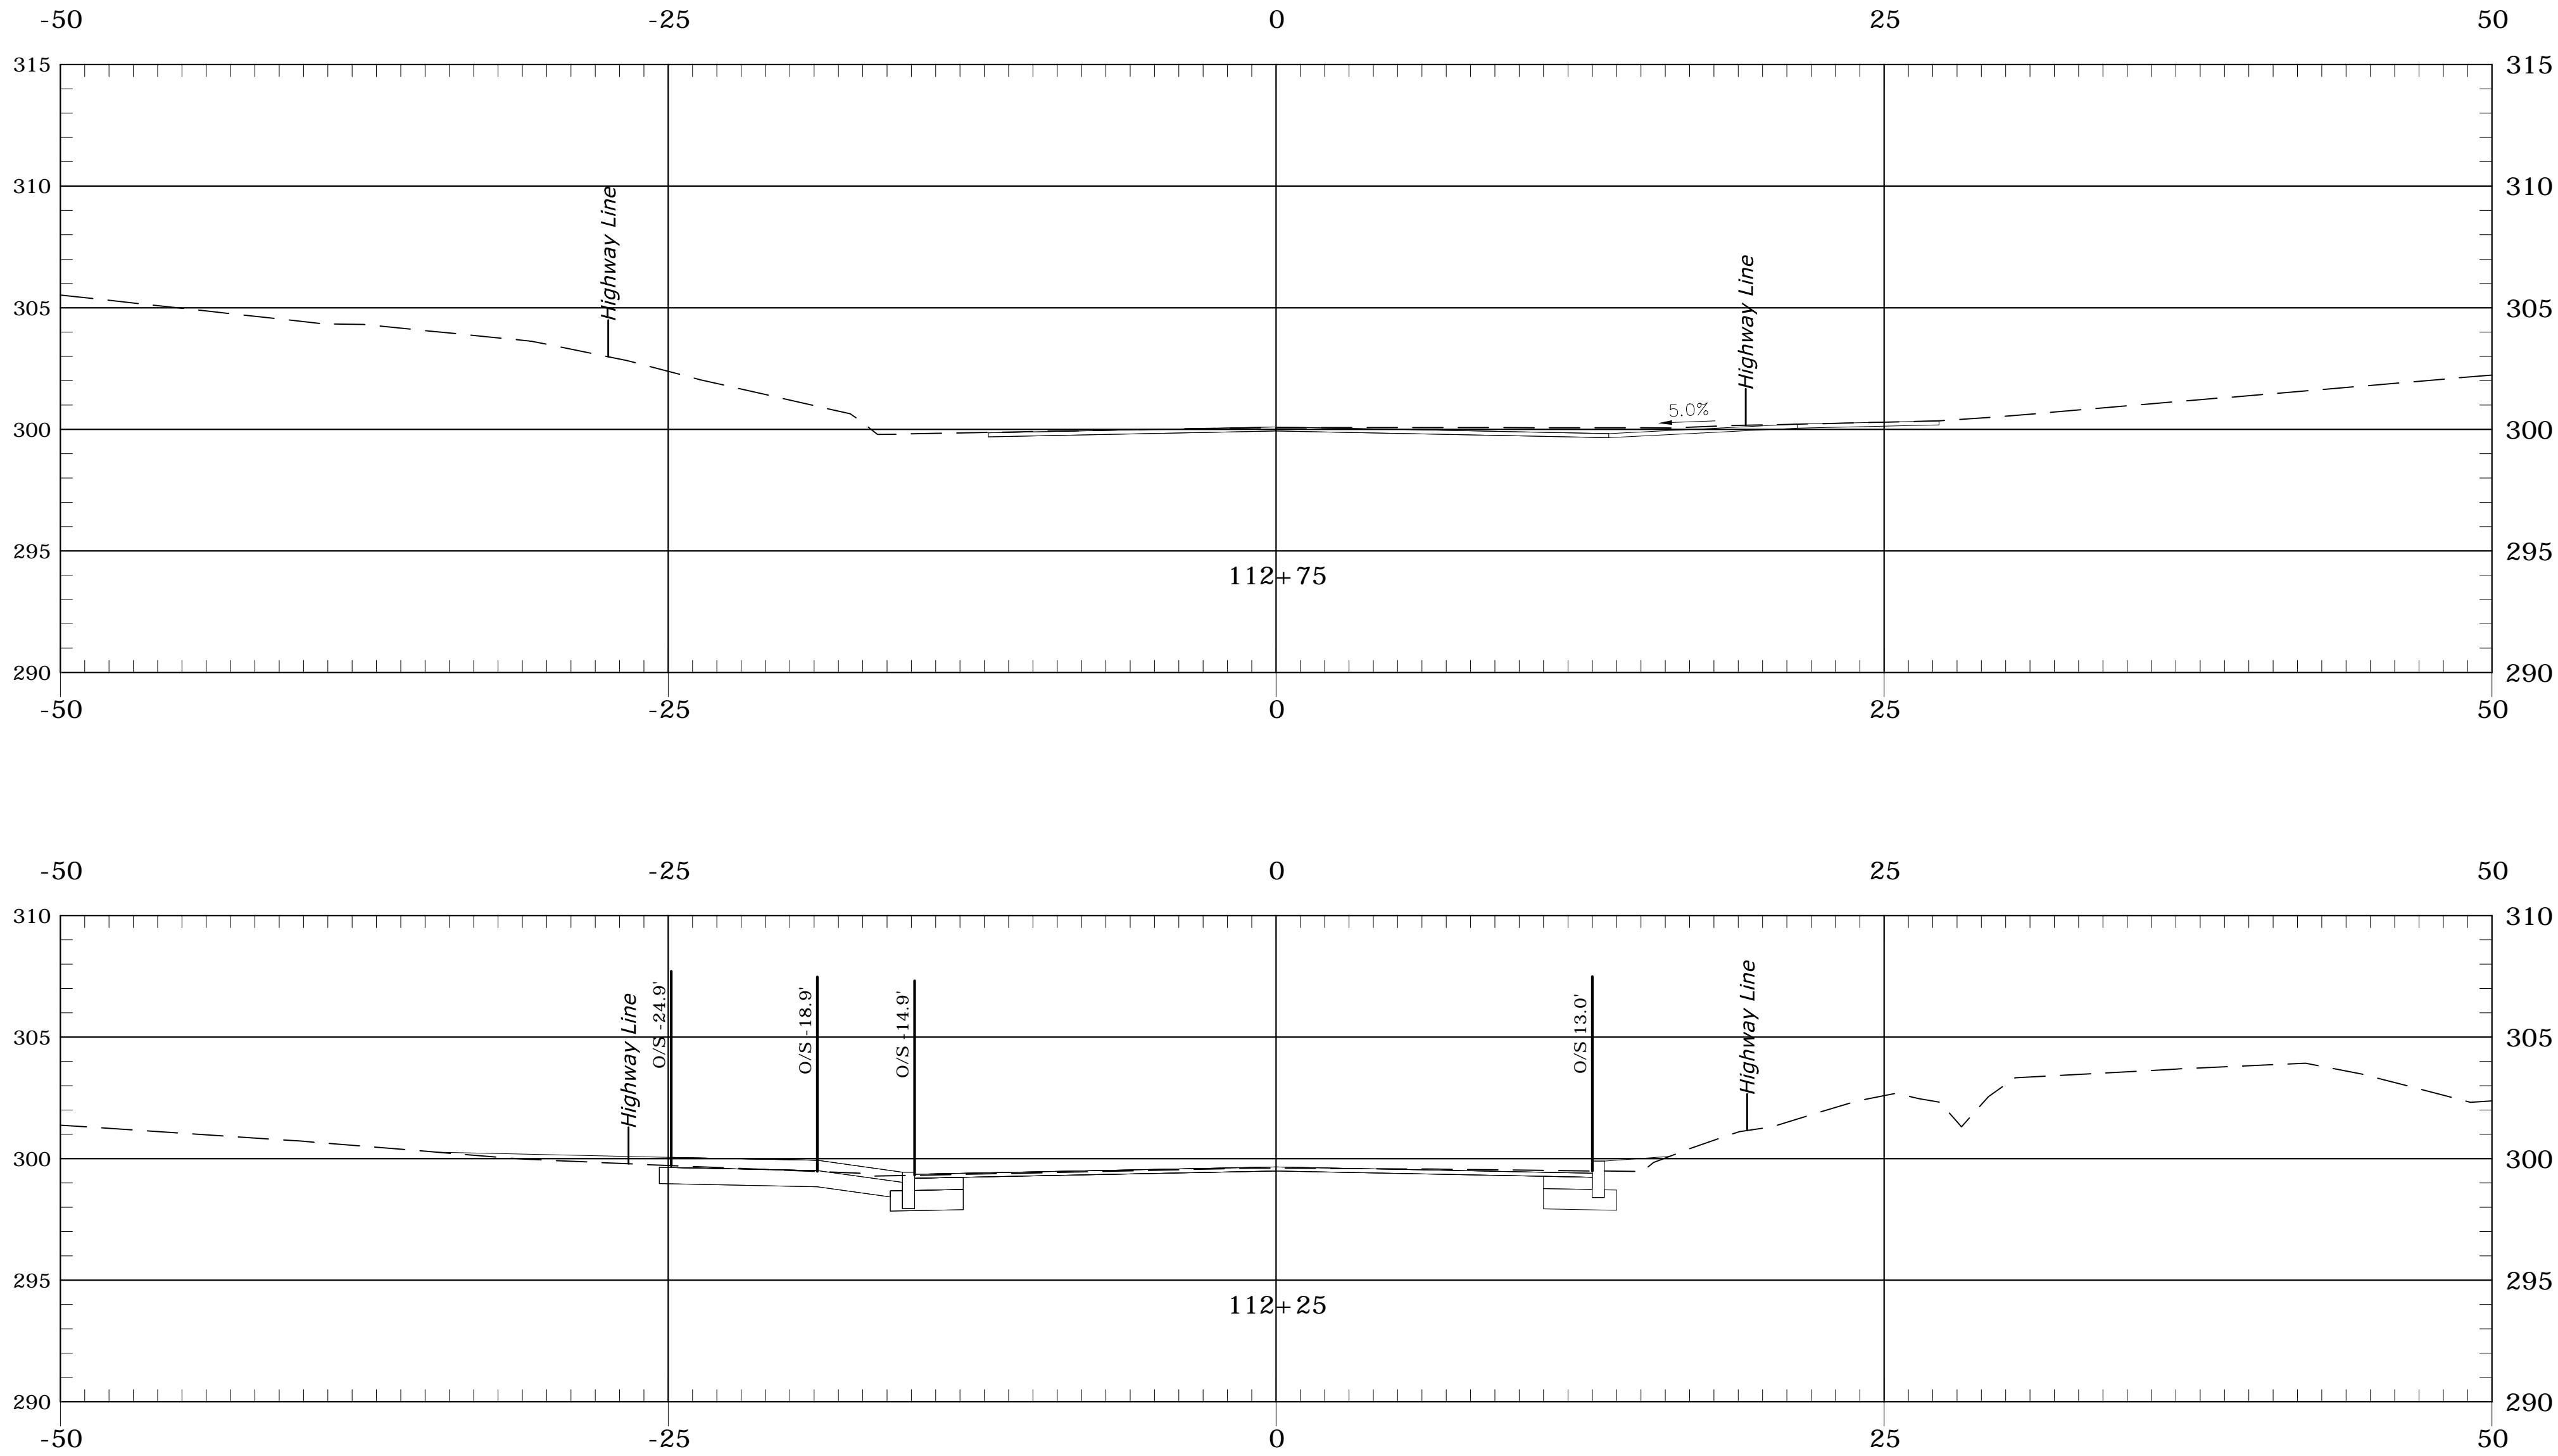
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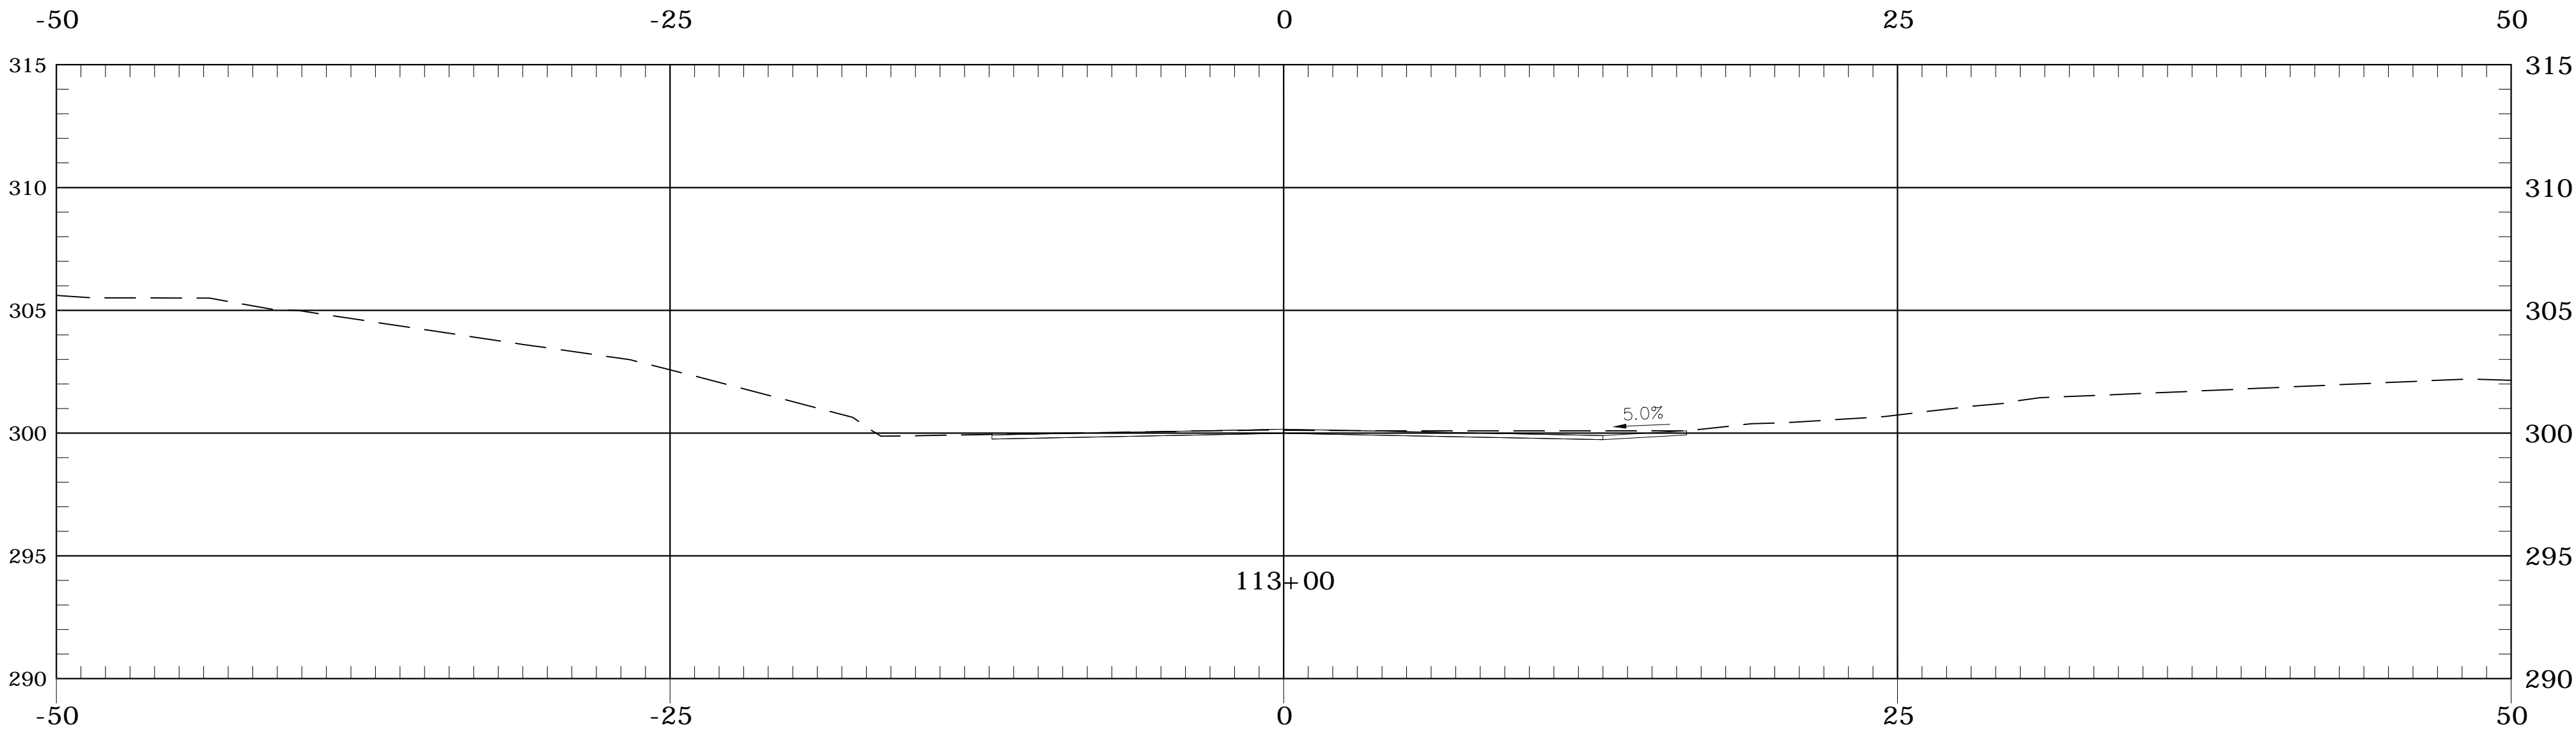
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	SHEET TITLE: FEDERAL ROAD CROSS SECTION, SHEET 06		
	FILE NAME:----	PLOT DATE: 4/20/2016	DRAWING NO.: XS-06
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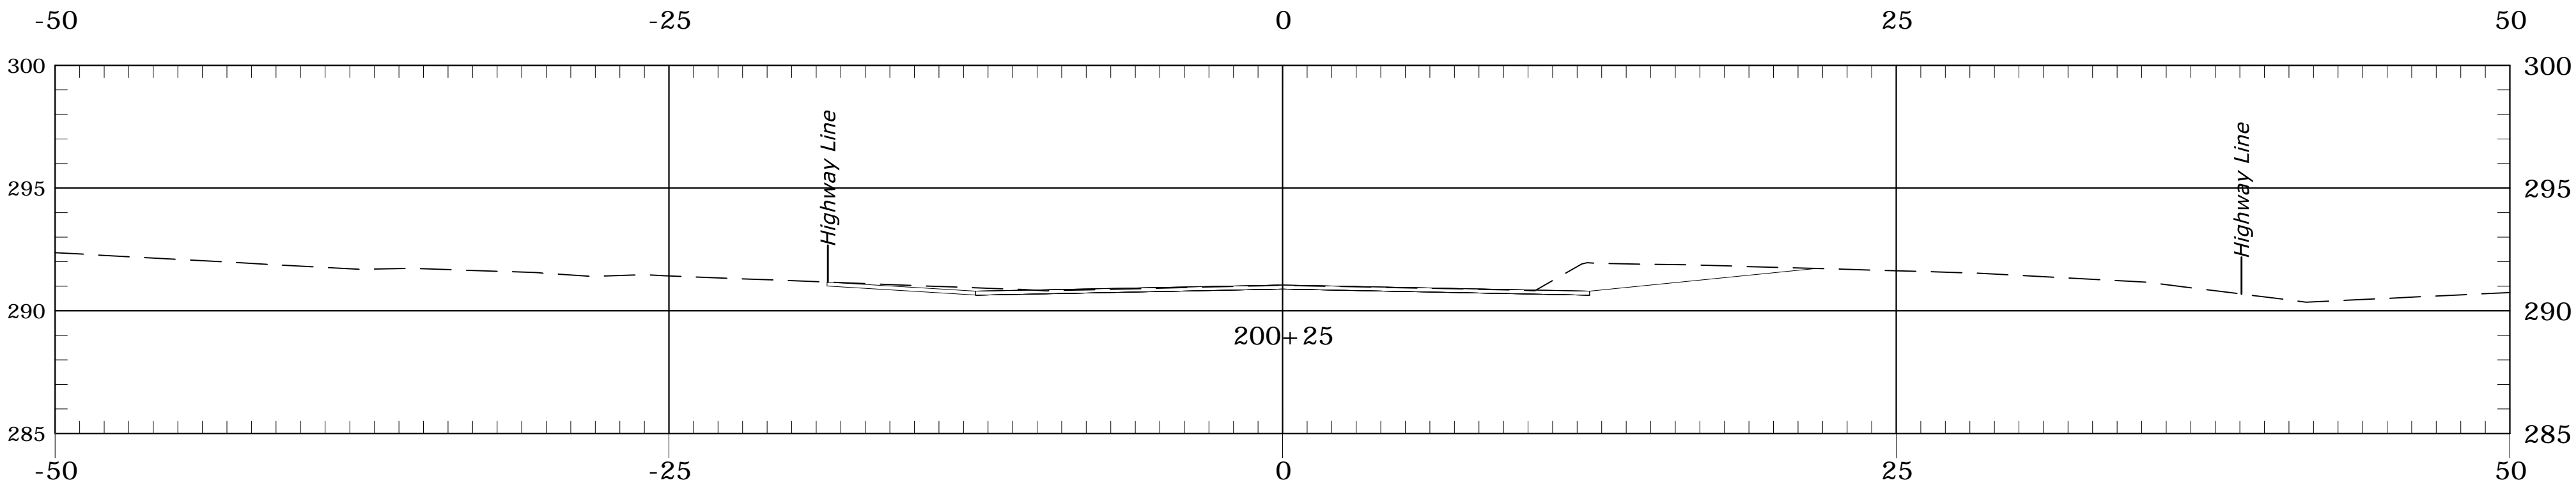
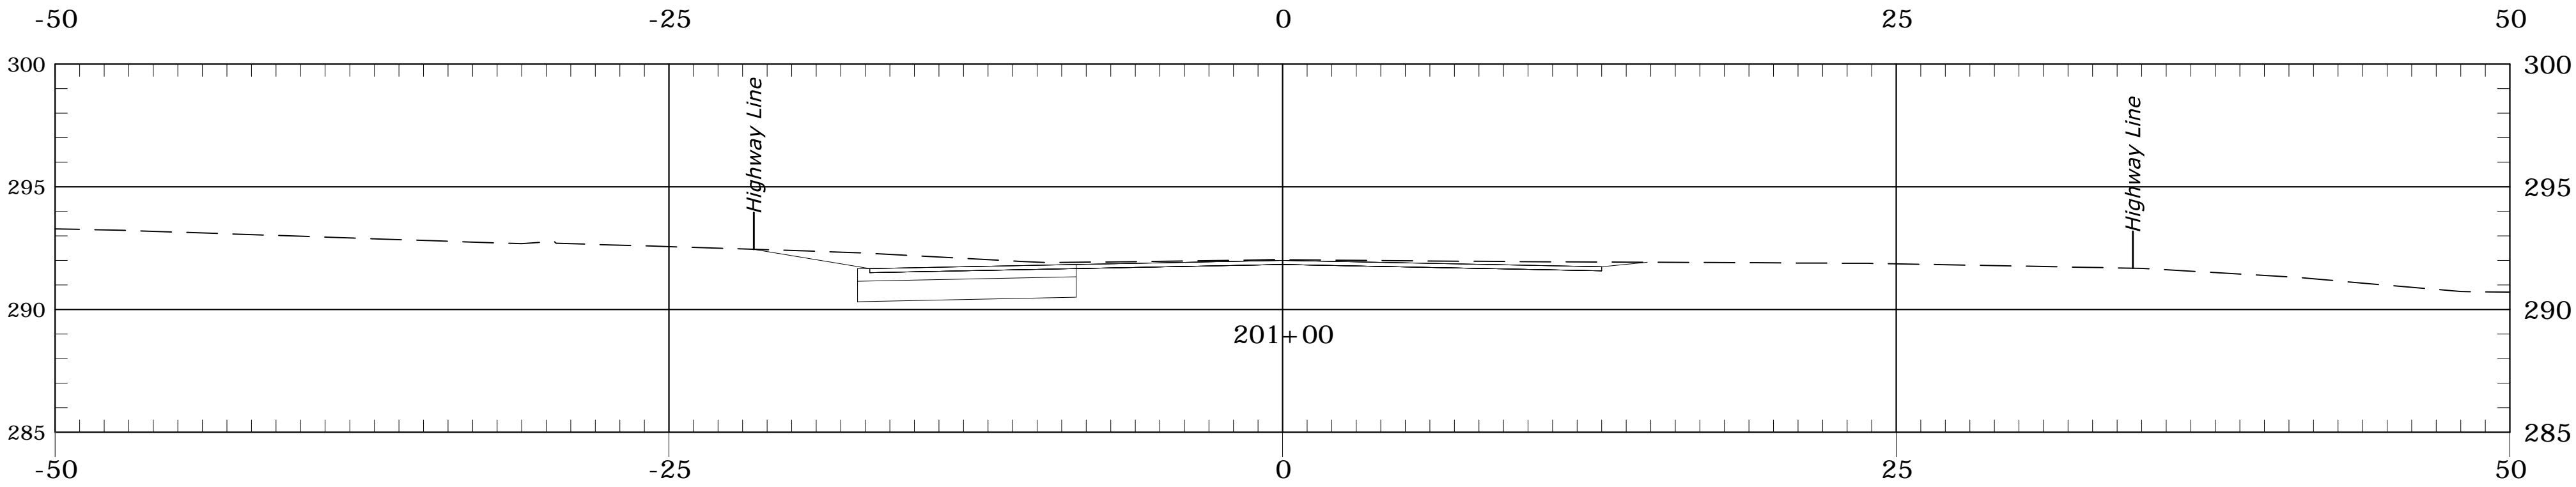
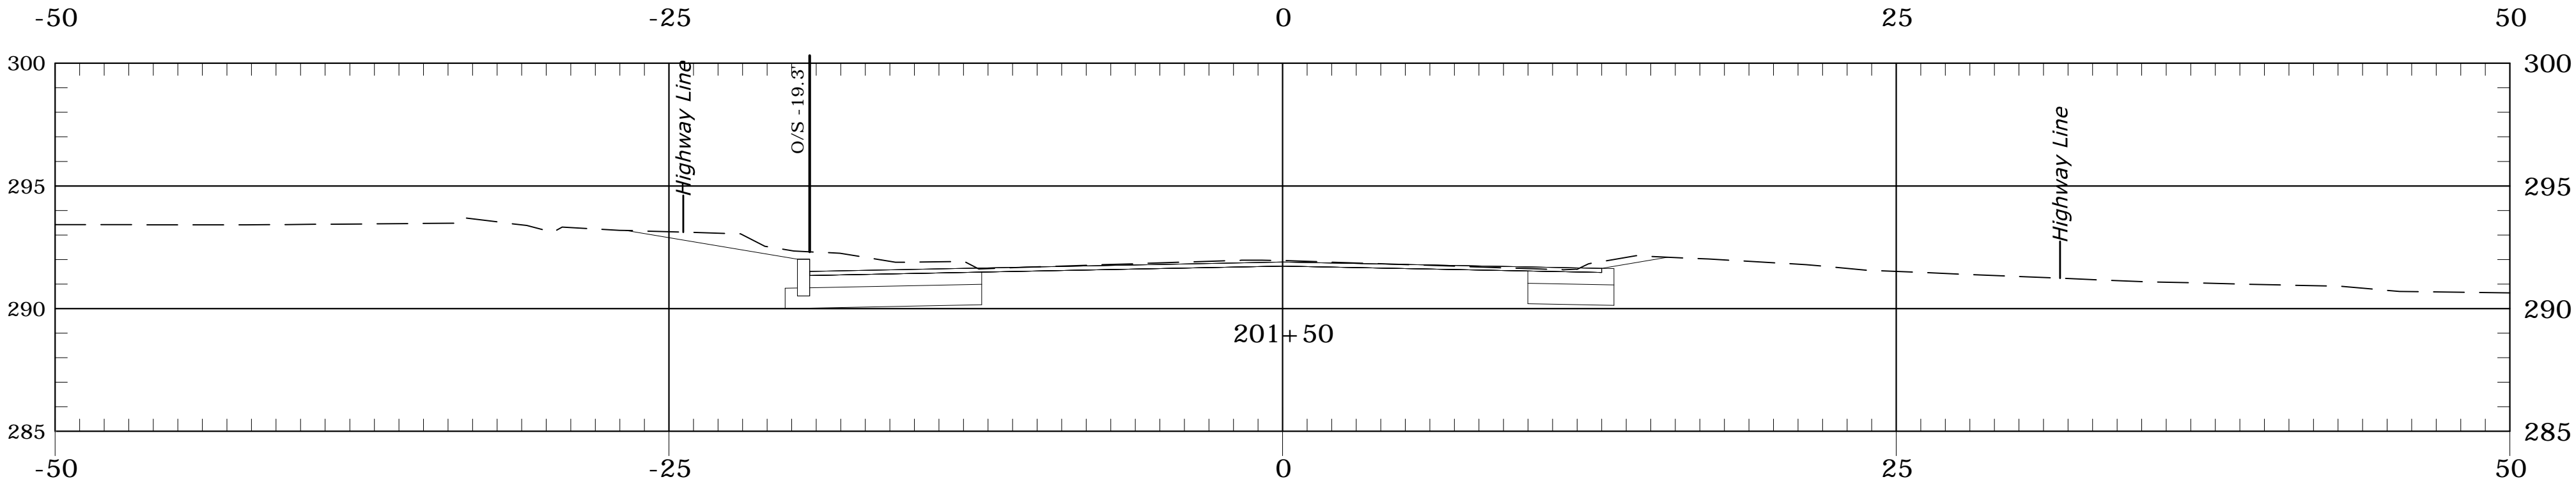
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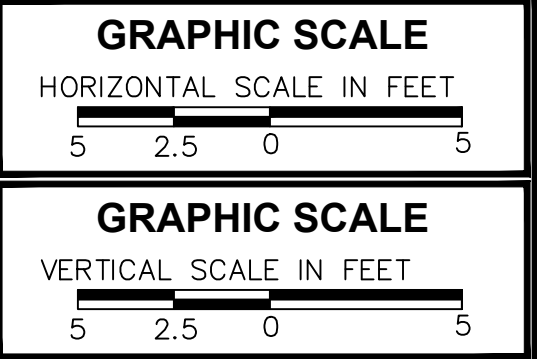
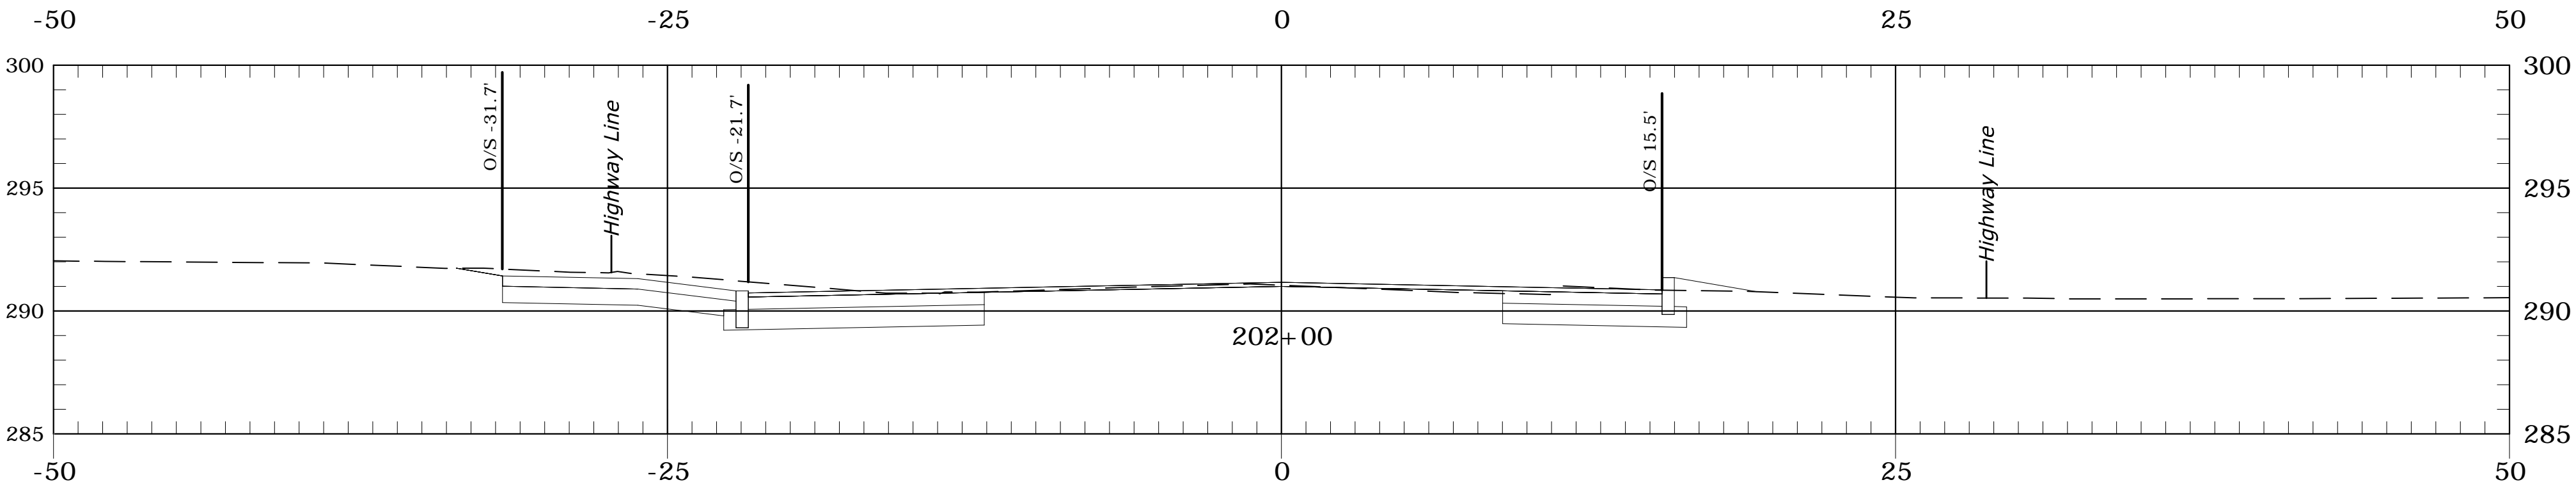
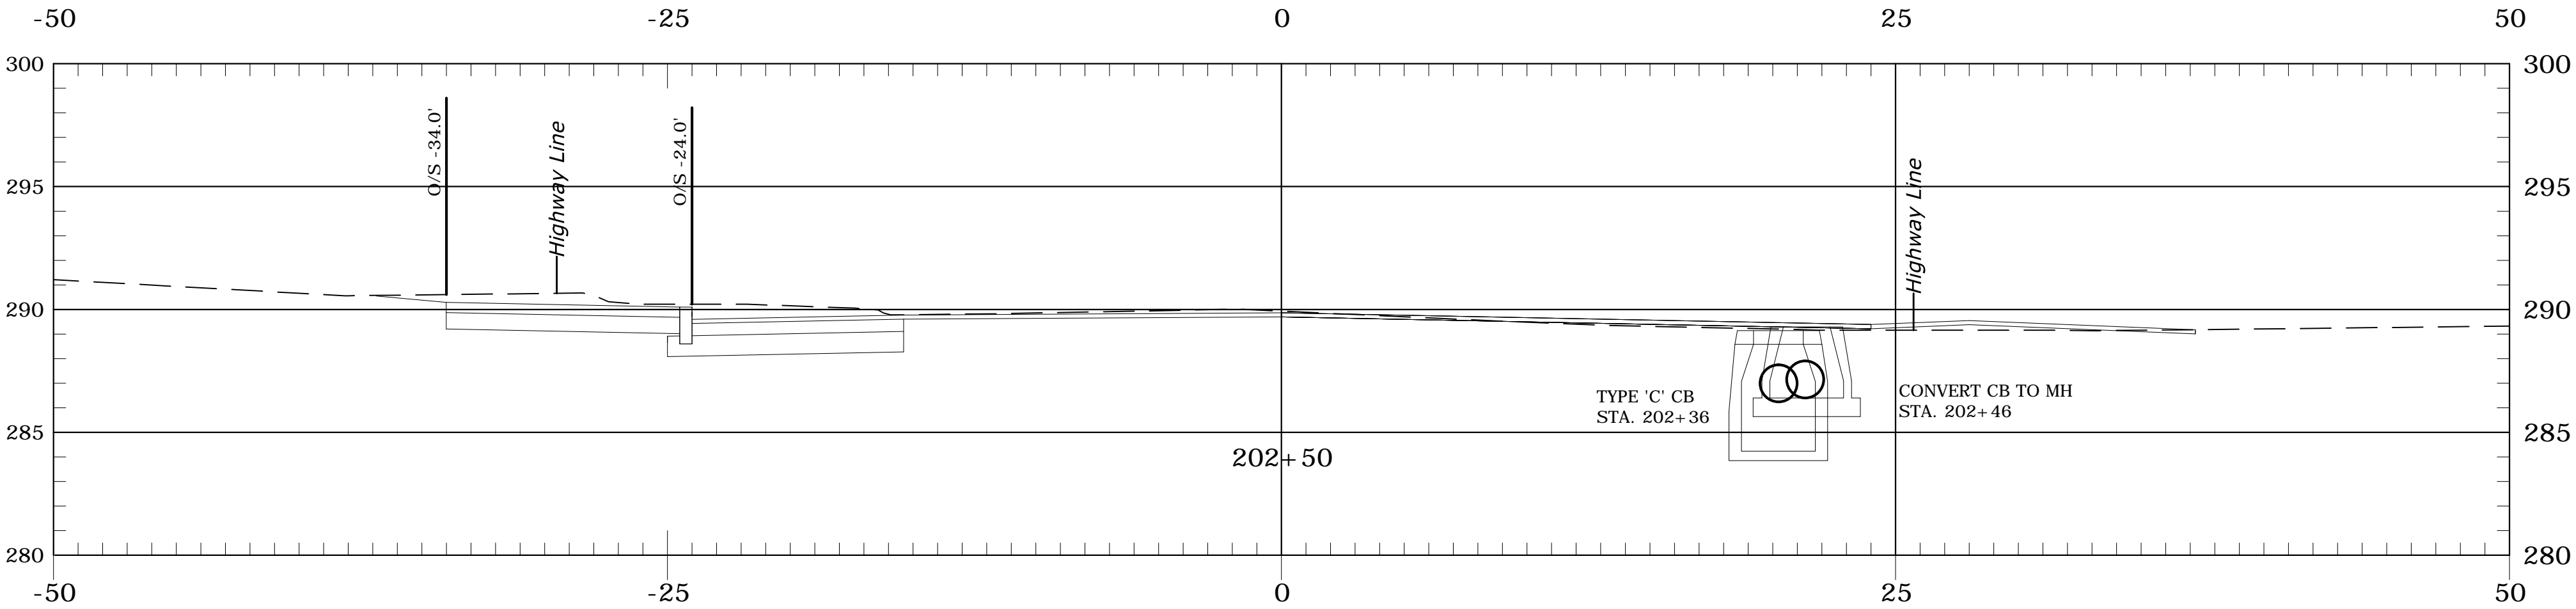
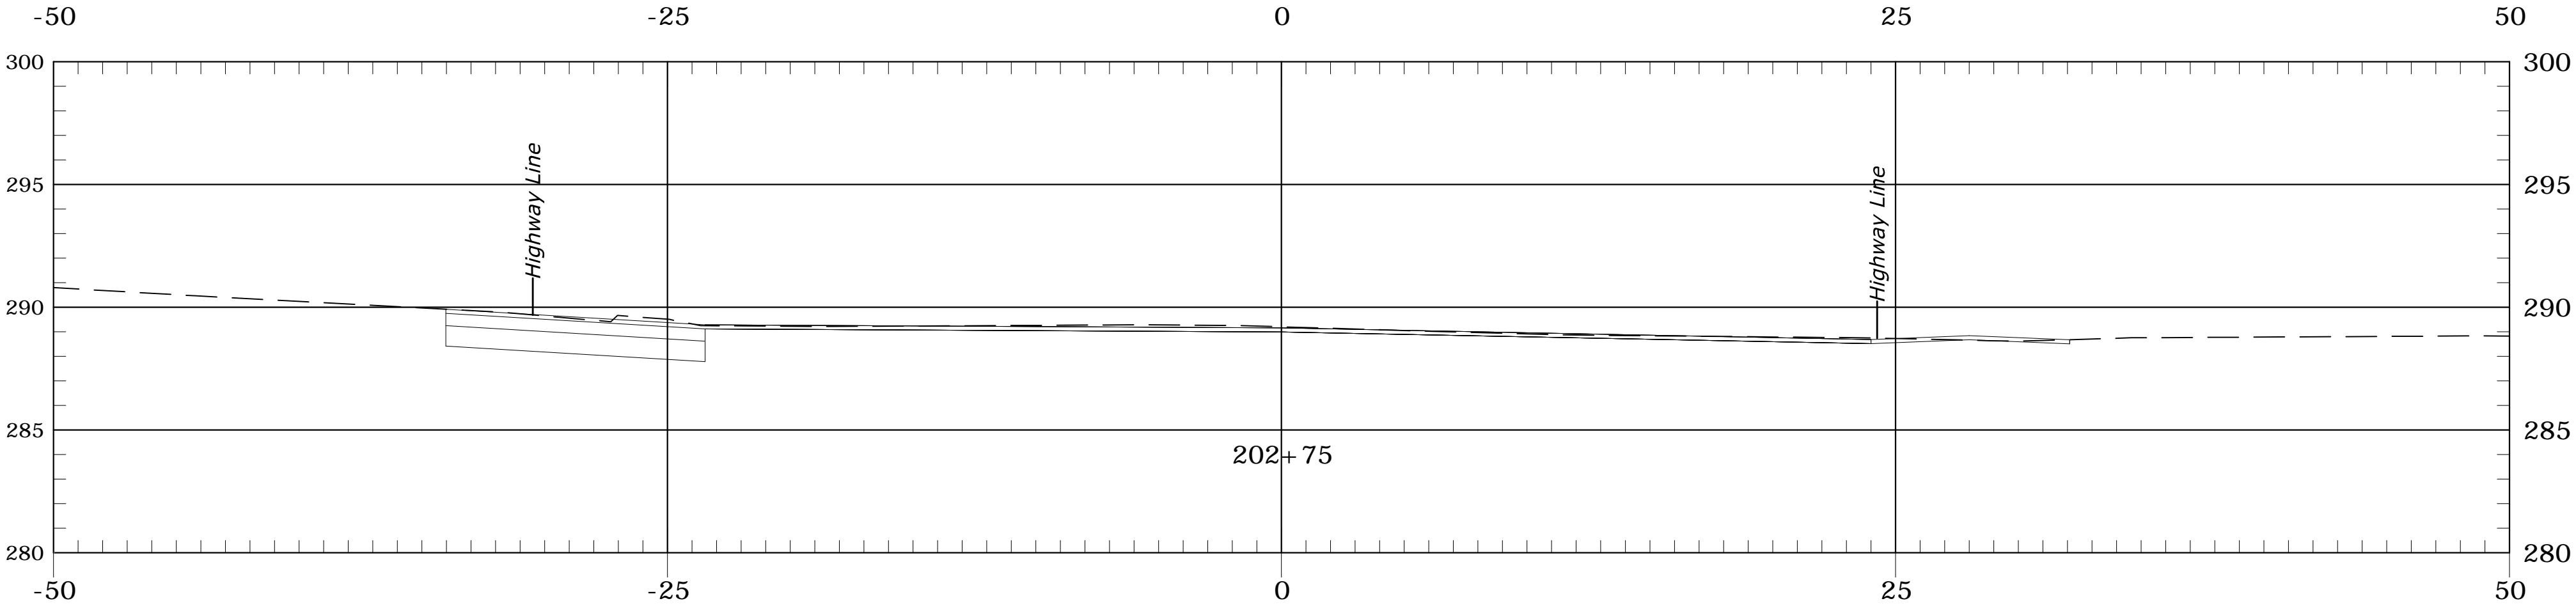
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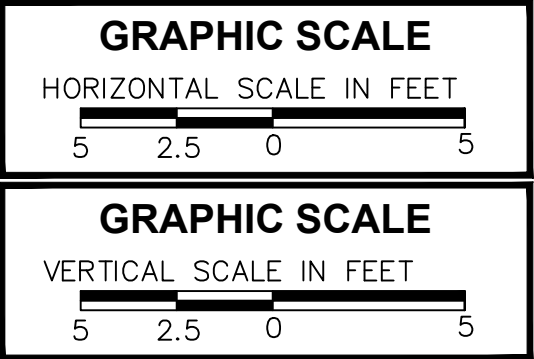
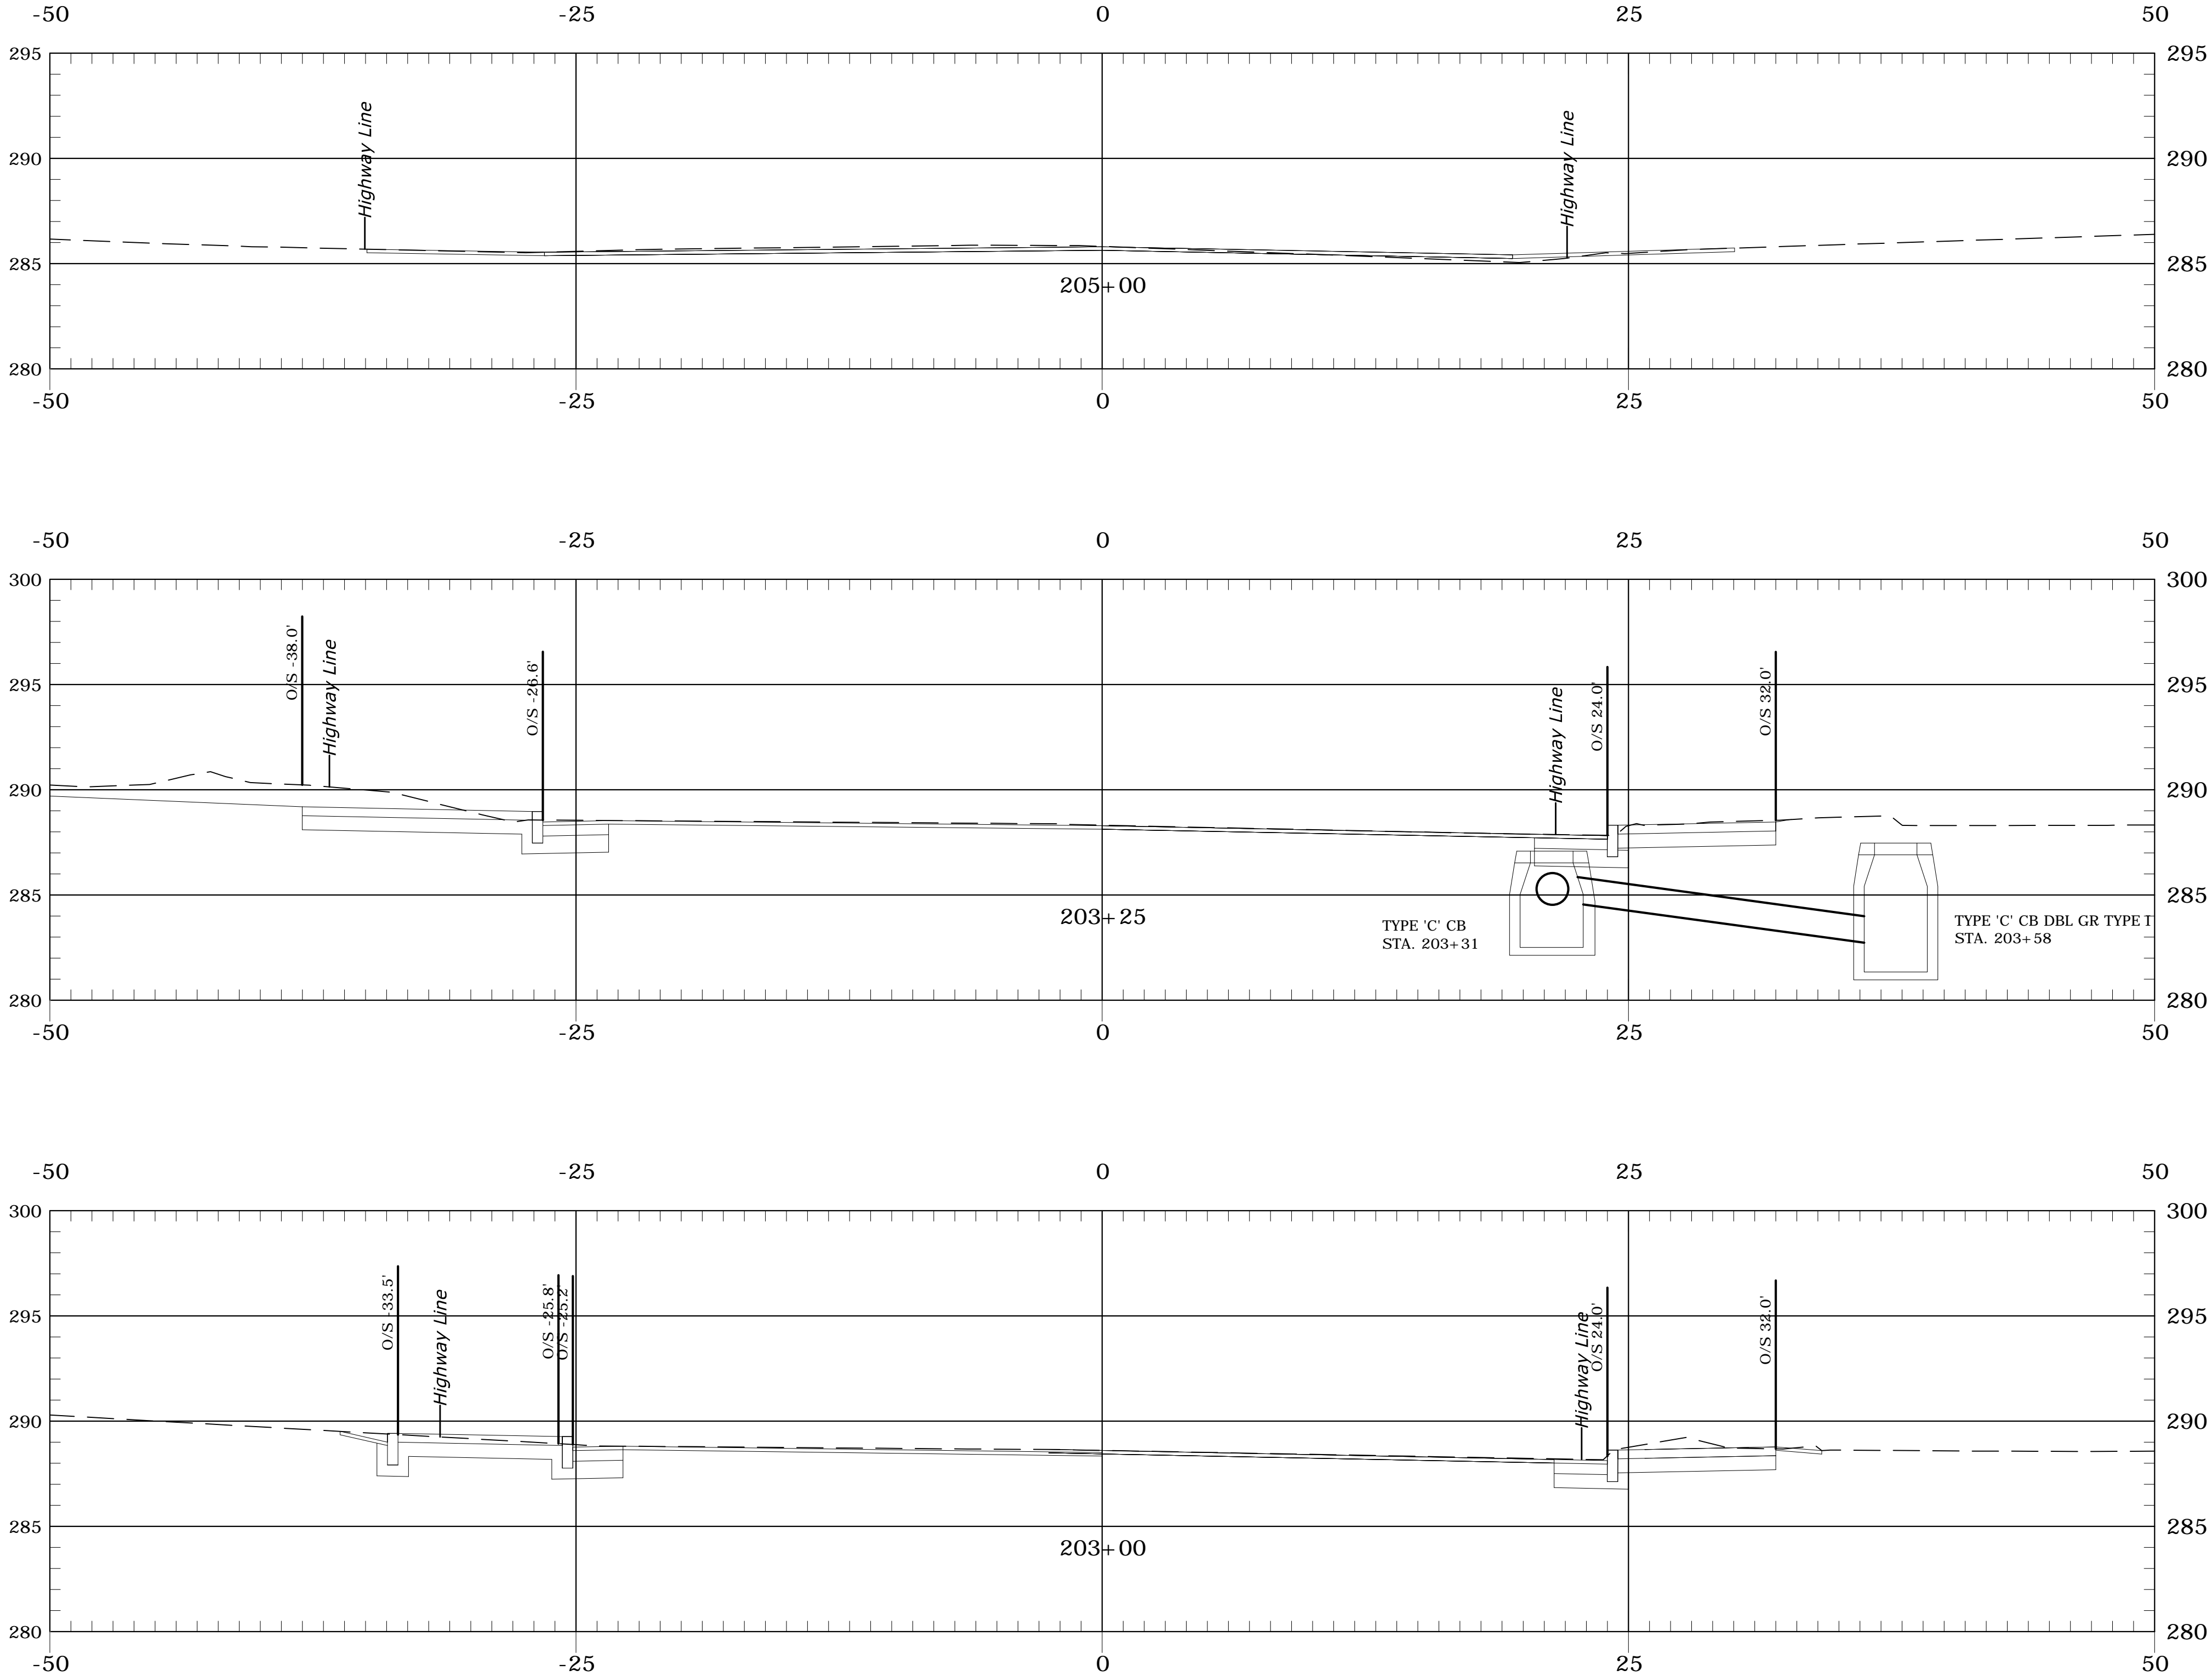
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		FILE NAME:----		PLOT DATE: 4/20/2016		
URS CORPORATION 500 ENTERPRISE DRIVE, SUITE 3B ROCKY HILL, CT 06067 (860) 529-8882		PROJECT LEADER: SM		DRAWN BY: AG		DRAWING NO.: XS-09
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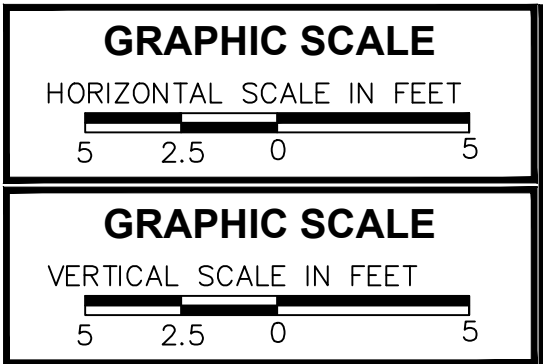
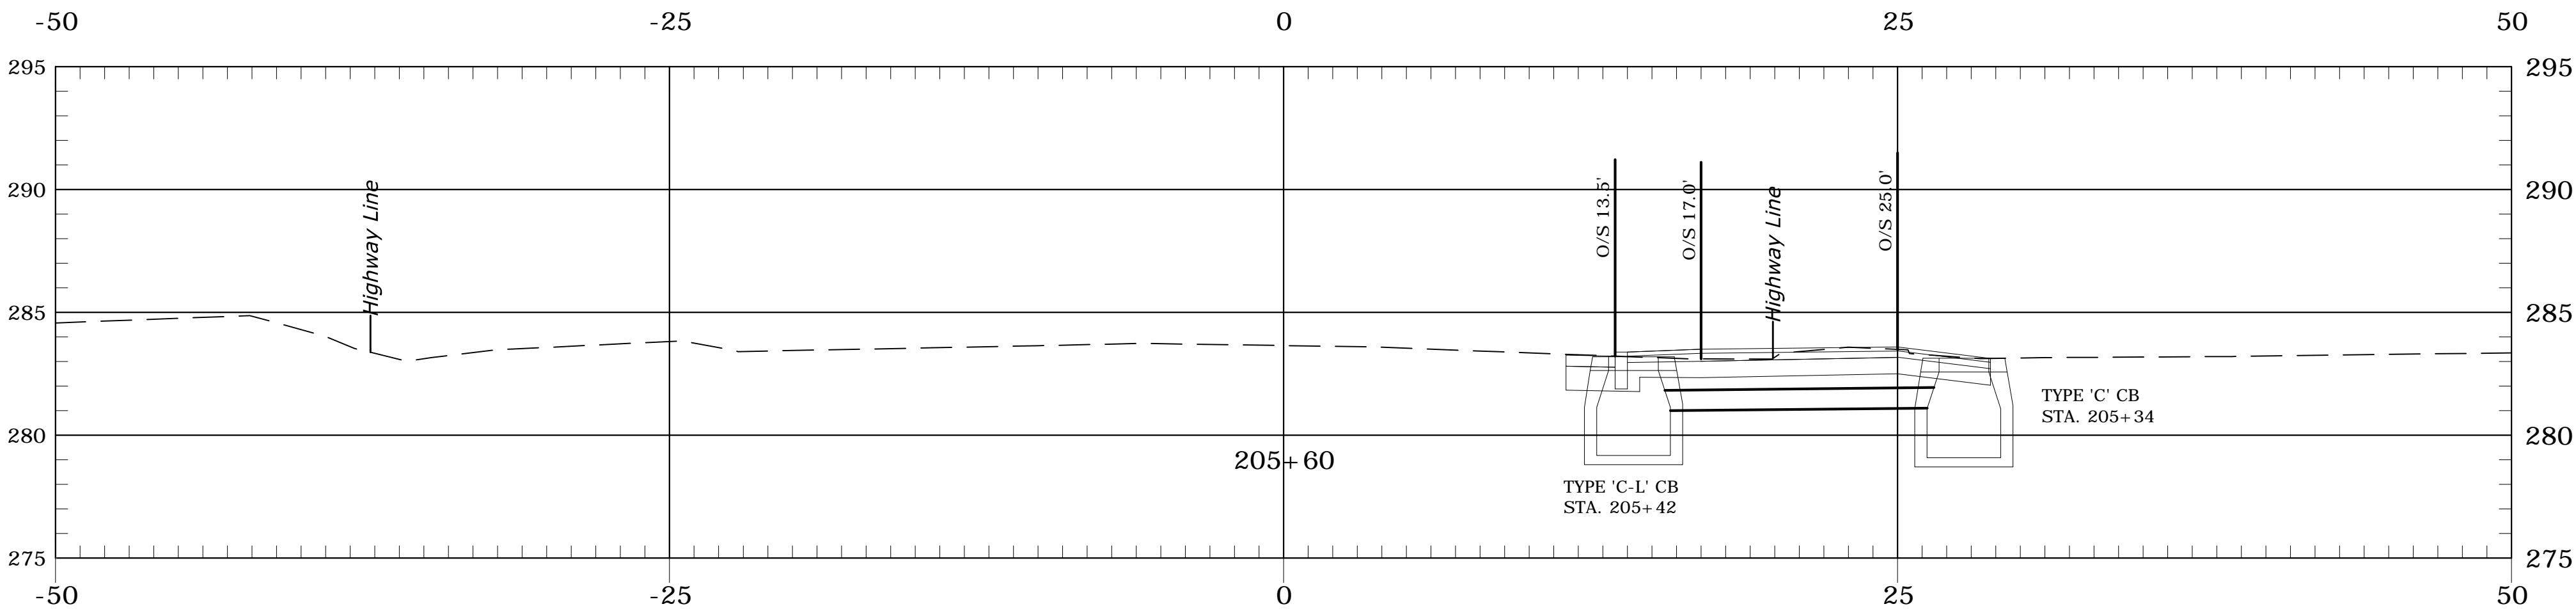
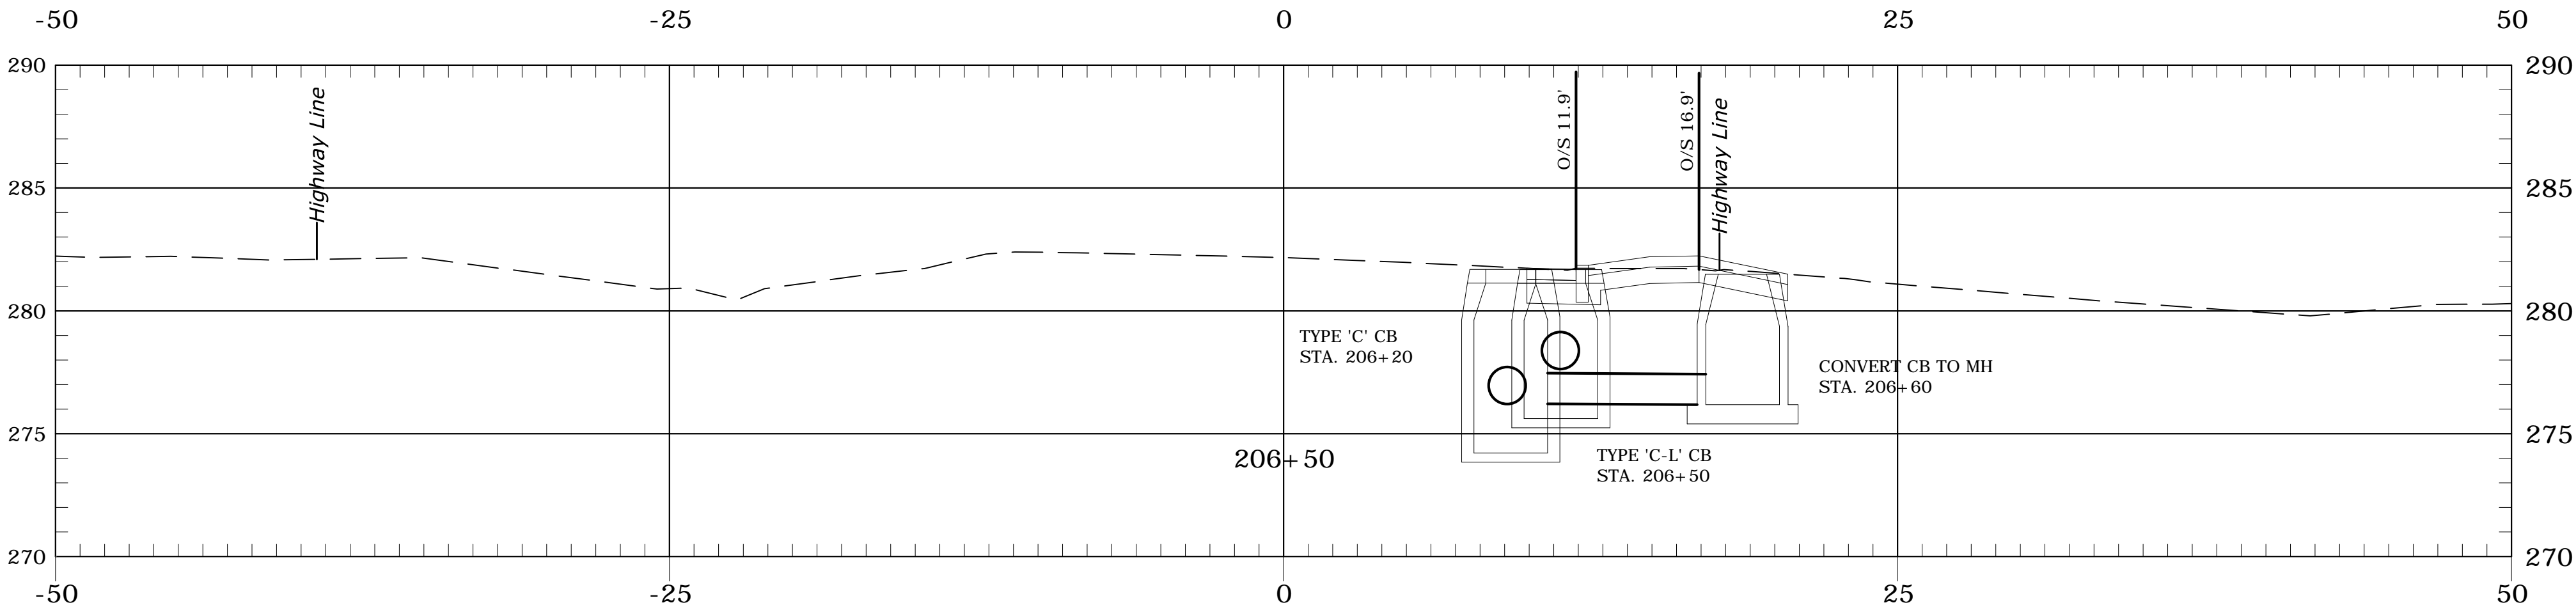
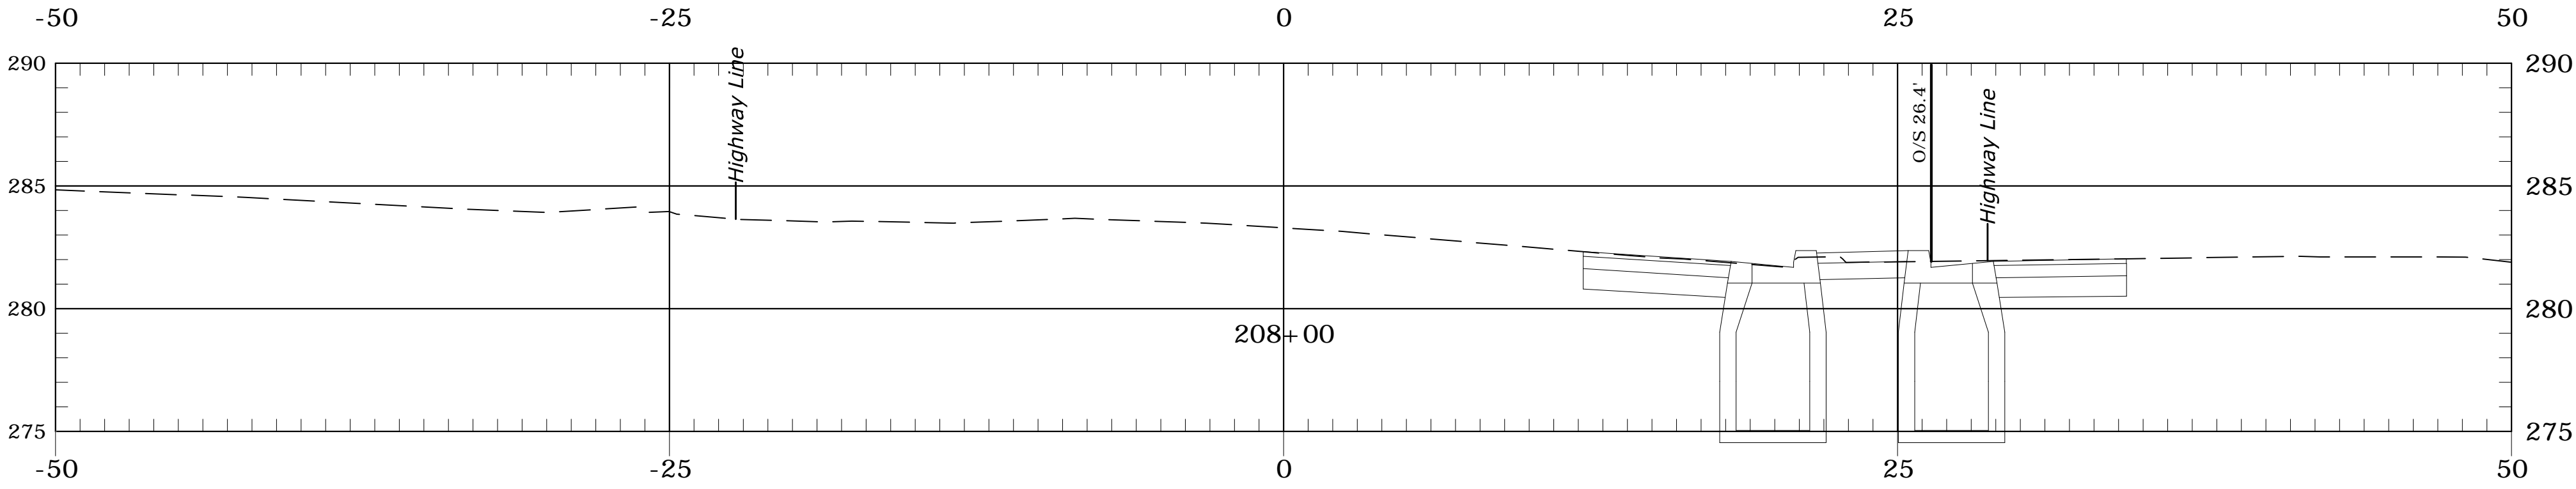
TOWN OF BROOKFIELD, CT			
URS CORPORATION 500 ENTERPRISE DRIVE, SUITE 3B ROCKY HILL, CT 06067 (860) 529-8882	PROJECT NAME: TOWN DISTRICT SIDEWALK AND ACCESS MANAGEMENT PLAN		
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TOWN OF BROOKFIELD, CT			
URS CORPORATION 500 ENTERPRISE DRIVE, SUITE 3B ROCKY HILL, CT 06067 (860) 529-8882	PROJECT NAME: TOWN DISTRICT SIDEWALK AND ACCESS MANAGEMENT PLAN		
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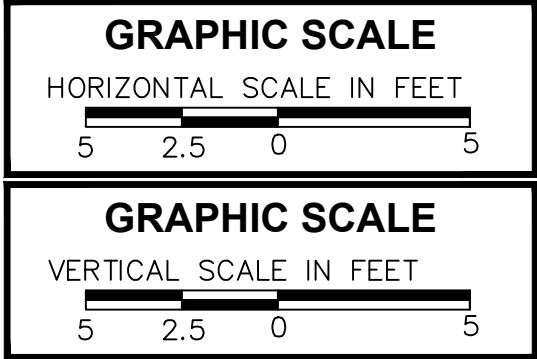
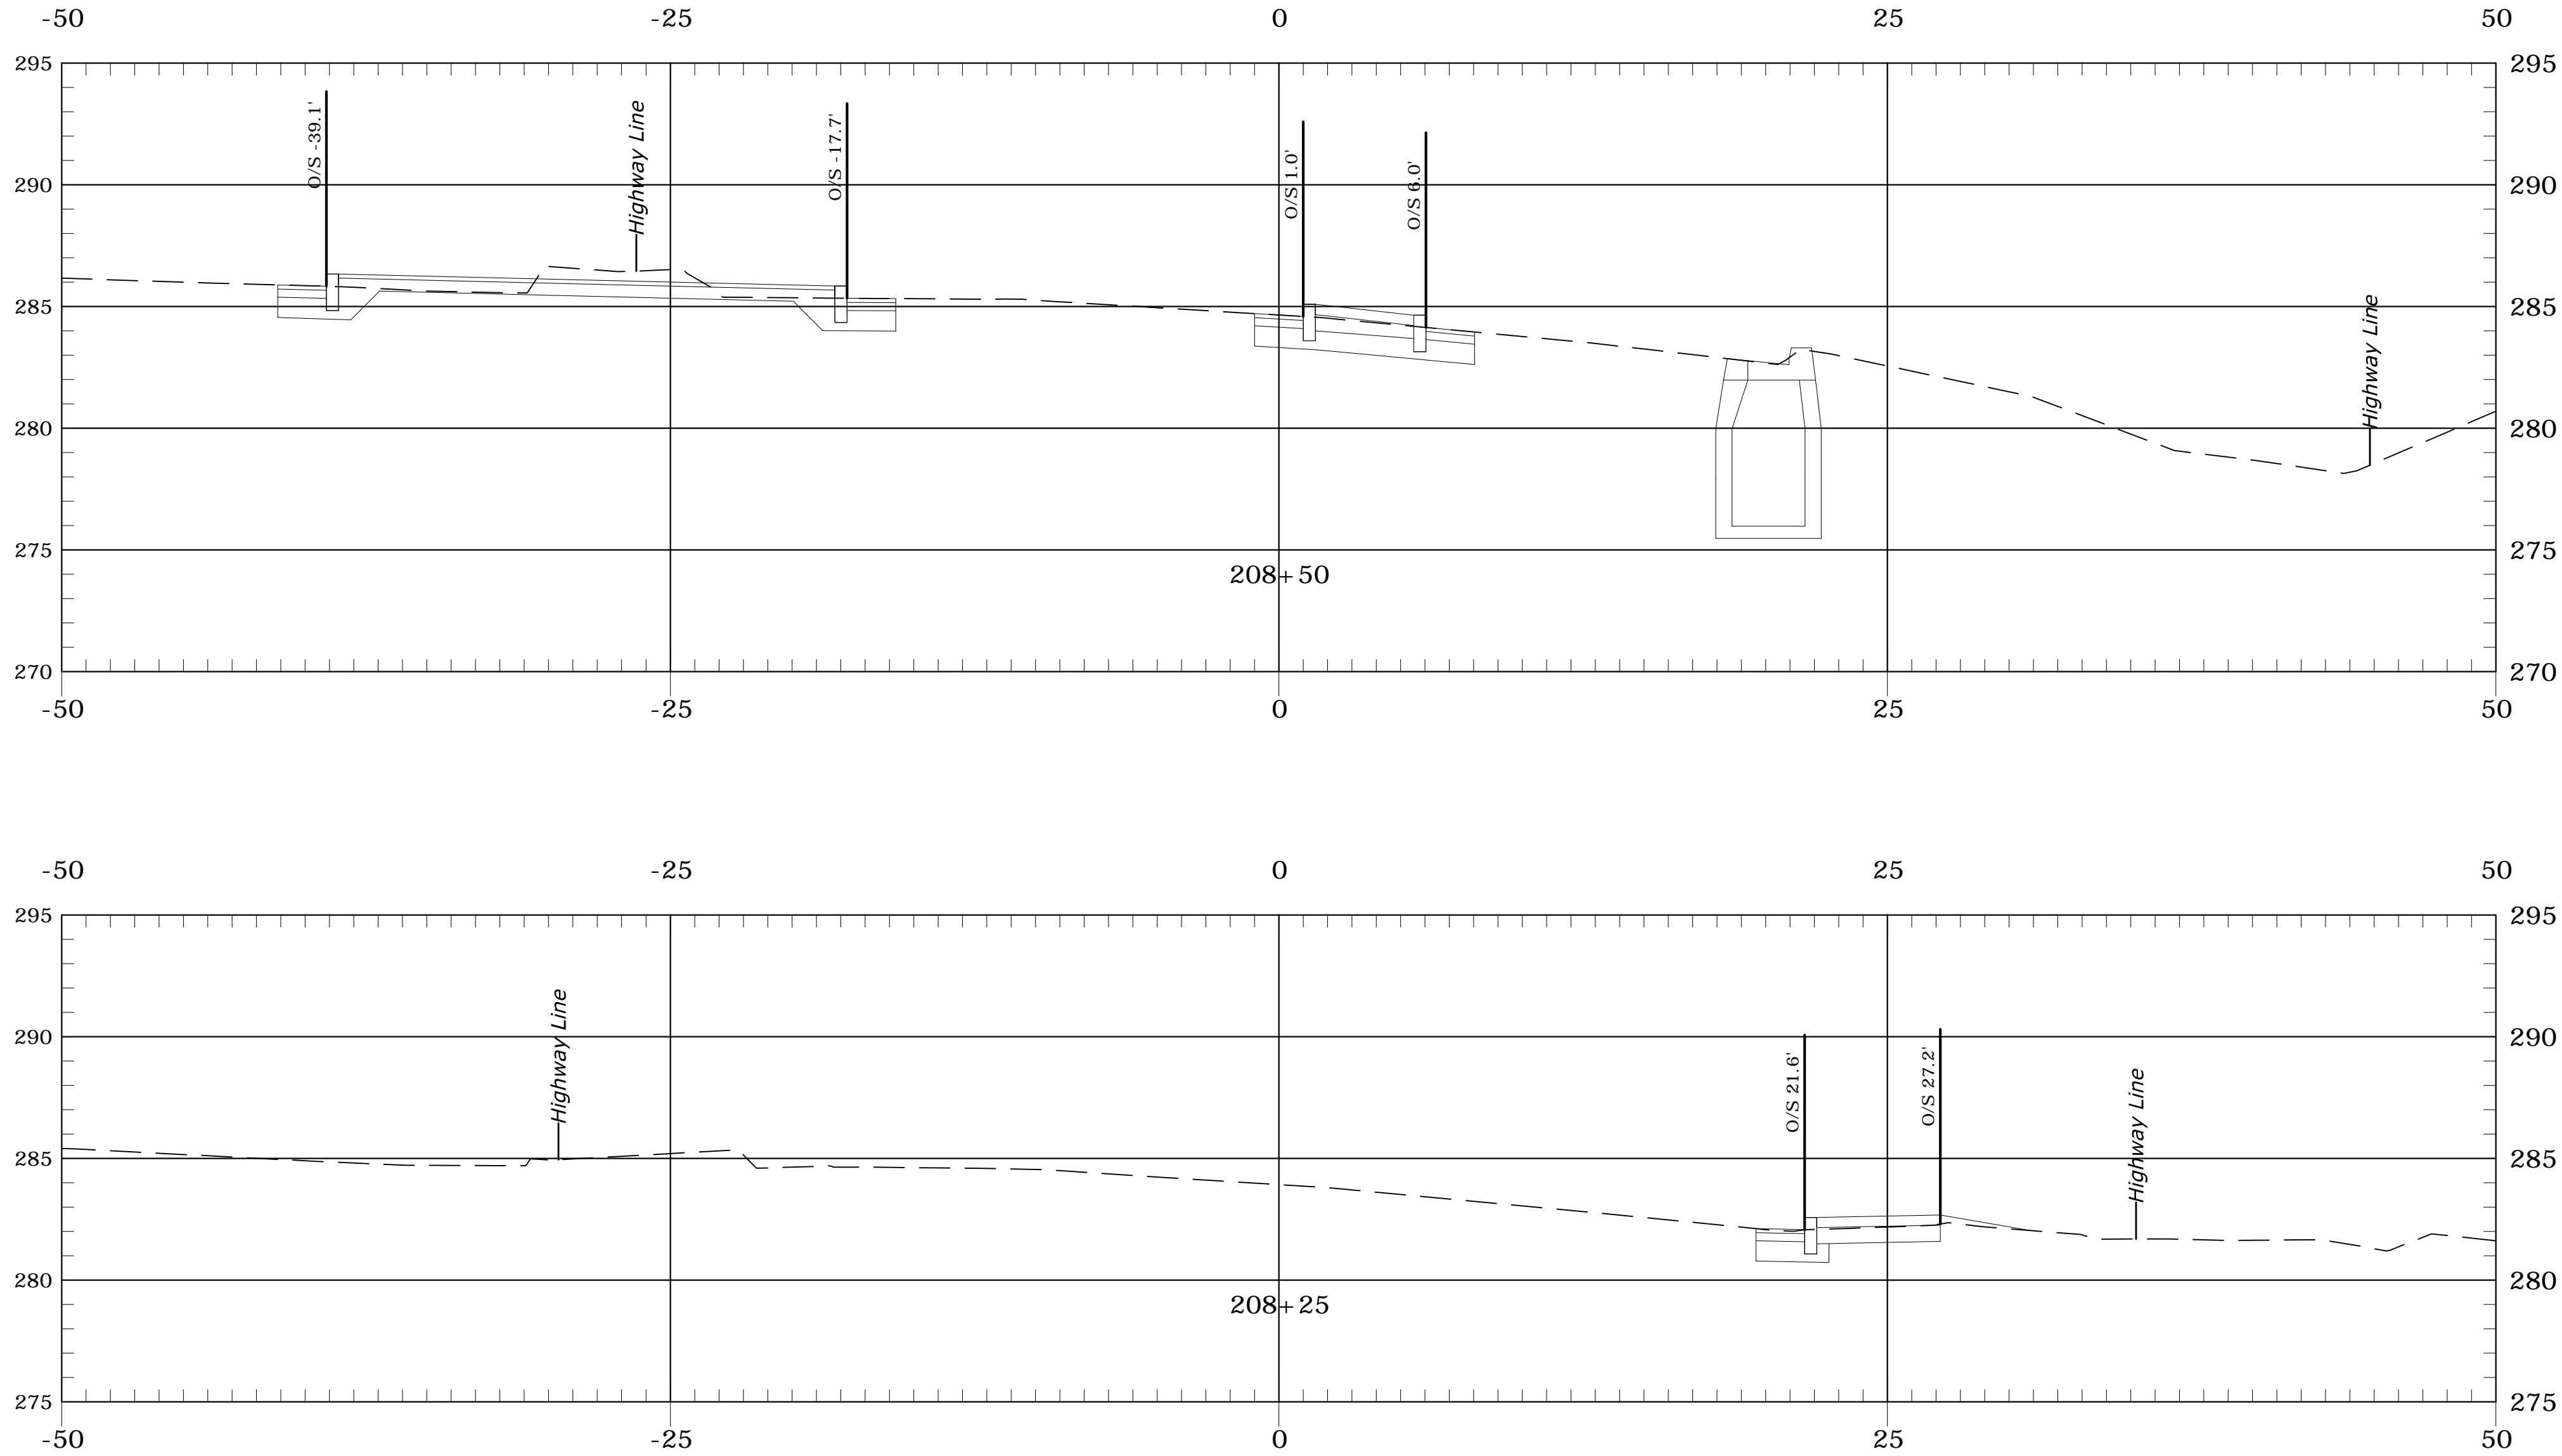
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TOWN OF BROOKFIELD, CT

URS CORPORATION 500 ENTERPRISE DRIVE, SUITE 3B ROCKY HILL, CT 06067 (860) 529-8882	PROJECT NAME: TOWN DISTRICT SIDEWALK AND ACCESS MANAGEMENT PLAN		
	SHEET TITLE: WHISCONIER ROAD CROSS SECTION, SHEET 12		
	FILE NAME:----	PLOT DATE: 4/20/2016	DRAWING NO.: XS-12
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TOWN OF BROOKFIELD, CT			
URS CORPORATION 500 ENTERPRISE DRIVE, SUITE 3B ROCKY HILL, CT 06067 (860) 529-8882	PROJECT NAME: TOWN DISTRICT SIDEWALK AND ACCESS MANAGEMENT PLAN		
	SHEET TITLE: WHISCONIER ROAD CROSS SECTION, SHEET 13		
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